

San Fernando Valley North-South Transit Corridor Regionally Significant Transportation Investment Study

Volume 2



Appendix

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Executive Summary

More than 100 members of the public attended a series of three mid-September community Open House meetings to kick off the San Fernando Valley North-South Transit Corridor Study.

The Open Houses were held on September 9, 10, and 12, 2002 at locations in the west, northeast and southeast San Fernando Valley — respectively in Northridge, the City of San Fernando and North Hollywood. All meetings were scheduled from 5:00 - 8:00 p.m. to accommodate those preferring to attend before dark as well as those residents needing to travel from outside the Study area.

These meetings were held in an Open House format which allows attendees to drop-in at a venue in a more relaxed environment and to circulate at their own pace between stations geared towards specific project elements. In this way, attendees can receive information and ask questions in a comfortable environment about topics that interest them.

This first round of community meetings was intended to introduce the public to the Study, and provide them with an opportunity to review and comment on a range of 13 north-south bus corridor alternatives developed. Specific stations provided at the Open Houses included a summary of the existing conditions, a PowerPoint presentation of the Study overview, the 13 Study alternatives and an overview of urban design options. Attendees were invited to provide their feedback by filling out comment forms (which they could also mail in) or via laptop computer.

Facilitating these Open Houses were members of the project team including key MTA project and consultant staff. Also in attendance were staff representatives of the San Fernando Valley Service Sector, the East/West BRT, Metrolink and LADOT.

These meetings were publicized via 10,000 "take-one" brochures distributed on MTA bus routes in the San Fernando Valley, invitations mailed to the project database, advertisements placed in local newspapers and were posted on MTA's website. Information about the Open Houses was also recorded on the Study's Information Line.

On the whole, attendees were positive about the Study and were enthusiastic about being included in the decision-making process. While there is a vestige of stakeholder interest remaining from the past East/West Study, most stakeholders responded well to the North-South Transit Study. They were especially interested in advocating connectivity with downtown, the Westside, Sylmar/Pacoima and the Santa Clarita Valley, and emphasized the importance of efficient connections with the East/West BRT, Metro Rail, other buses as well as Metrolink.. The Canoga right-of-way, Van Nuys and Sepulveda alternatives were especially supported at these meetings.

Meeting Publicity

To raise community awareness about the Open Houses and encourage attendance, MTA employed a number of publicity tools including:

- **Press releases** which were developed and distributed by MTA's Media Department..
- **5,000 Letters of invitation** and the Study Fact Sheet which were mailed to the stakeholder database.
- The **Study Information Line** (818) 701-2855 which has been publicized via the Study Fact Sheet, was updated to include information about the Open Houses.
- **Advertisements** which were placed in representative local newspapers, specifically the Los Angeles Times, Daily News, and San Fernando Sun (copies of the advertisements are located in the Appendix to this report.), appeared two weeks prior to the meeting dates.
- 10,000 on-board "**take-ones**" which were distributed beginning August 30, 2002 on appropriate bus routes in the San Fernando Valley including Routes 8 and 15. These brochures provided a brief Study description as well as information about the Open Houses.

Meeting Summaries


Northridge Open House Meeting

Date: Monday, September 9, 2002
5:00 – 8:00 p.m.

Location: Northridge Hospital Education Room
18300 Roscoe Boulevard, Northridge

Attendees:

Kevin Michel, MTA	Michael Meyer, MMA
Roger Martin, MTA	Viggen Davidian, MMA
David Armijo, MTA	Adolfo Ozaeta, MMA
Marta Maestas, MTA	Lee Ward, MMA
Mike Brewer, MTA	Manuel Soto, TDM
Eric Rapp, MTA	Gene Anderson, Ultrasystems
Kathleen Sanchez, MTA	Elaine Carbrey, Gruen Associates
Susan Bok, City of Los Angeles	Andrew Mondschein, Gruen Associates
Lupe Valdez, Metrolink	Clarissa Filgioun, TRG

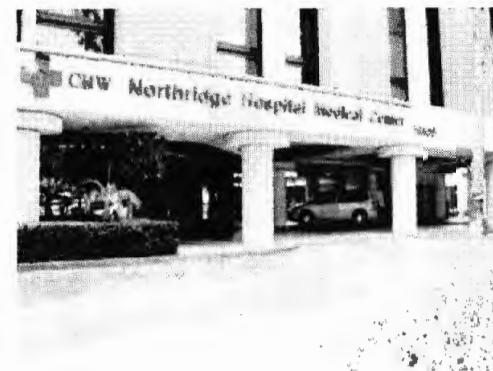

Meeting Summary

This was the first of three community meetings for the San Fernando Valley North-South Transit Corridor Study. The purpose of this meeting was to introduce the proposed project alternatives to the community and to solicit feedback from meeting attendees. A PowerPoint presentation ran throughout the meeting, explaining the purpose of the study. Presentation materials included specific information about current conditions, project alternatives and urban design ideas.

Approximately 38 members of the public attended the meeting. The Open House format of the meeting allowed community members to speak one-on-one with MTA representatives and the project consultant team. Staff from the MTA's SFV Sector, the East/West BRT, as well as Metrolink were also present during the meeting to speak with the public.

While some of the meeting attendees were interested in the status of the East/West corridor study, most attendees were encouraged by the opportunity to participate in the scoping efforts for this Study. Some participants were supportive of construction of light rail service in the Valley, possibly along the median of U.S. 101, or along the Canoga right-of-way. One community member voiced her overwhelming support for, and satisfaction with, Metro Red Line service.

Of the submitted written comments, there was significant support for the alternatives that provided service for Canoga Avenue and, to a lesser extent, Sepulveda and Winnetka Avenues. An attendee representing the auto dealers on Van Nuys Boulevard noted her concern that the project would negate the street and landscaping improvements the area's BID has already accomplished, and noted that cars are currently unloaded off trucks in the median to avoid disturbing adjacent neighborhood streets. Other community members commented that the transit system is crowded but that they are encouraged by the possibility of increased transit service resulting from the Study. Some also spoke in favor of further extending the subway in the SFV, and were supportive of more service along existing bus routes. Several attendees were in favor of providing project alternatives that increased connectivity with Metrolink, the Metro Red Line, and existing public transportation.

In Attendance

Name	Address	City	Zip	Phone	Email
Don Powers	8430 Ranchito Ave	Panorama City	91402	818.892.1898 818.285.2902, X 254	
David & Marcia Melcombe		Northridge	91325	818.594.1189	
Lancene Quicken Glauca Lloyd	16027 Royal Oak 17808 Sherman Way #235	Encino Reseda	91436 91335	818.345.4706	
Leslie Drayton	10746 Wystone Ave	Northridge	91325	818.360.5647	
Michael Besem	19040 Vanowen St.	Reseda	91335	818.756.8848	mbesem@council.lacity.org
Carol Wohlgemuth	20421 Hamlin St.	Winnetka	91306	818.594.5704	cwohlgl776@aol.com
Alan Stone	7521 Ruffner Ave	Van Nuys	91406	818.908.8902	astone@socal.rr.com
Stacey Siegel	5855 Van Nuys Blvd	Van Nuys	91401	818.907.4138	ssiegel@keyescars.com
Michael Tou	5000 Van Nuys Blvd, Suite 420	Sherman Oaks	91403	818.501.9200	michael.tou@mail.house.gov
Nancy Bennett	19960 Friar	Woodland Hills	91367		canben@ix.net.com
Don Teichner	6210 Penfield Ave	Woodland Hills	91367		gr8kevin@pacbell.net
Stan Opatowsky	4625 Degovia Ave	Woodland Hills	91364	818.225.8552	
Alan Wolfe	19718 Kittringe Lane	Canoga Park	91306		
Paul Dentzel	P.O. Box 28010	Northridge	91328	818.349.8020	saharaexpress@telis.org
Luba Kleiwman	14246 Bessene	Van Nuys	91401	818.613.1991	
Norbert Lado	18551 Oxnard St	Tarzana	91356	818.776.3200	
Al Rangel		Palmdale	93550	661.273.2425	rangela@mta.net
Ed Stauss	24125 Albers St	Woodland Hills	91367	818.883.7843	edstauss@yahoo.com
Ted Bremsey	8613 Columbus #5- 109	North Hills	91343	818.895.1060	
Travis Rosenberg	20420 Orey Pl	Winnetka	91306	818.347.3167	ldrozen@aol.com
Lee Bunzel	6443 Winnetka Ave	Winnetka	91306	818.340.6737	leebug@aol.com
L. Hepburn	333 S. Hope St	Los Angeles		213.576.1193	
Dorothy Bennett	20502 Hamlin	Winnetka	91306	818.348.3784	
Bruce Moicma	P.O. Box 37-1311	Reseda	91337	818.898.3320	
Victoria Rodriguez	6527 Laramie Ave	Winnetka	91306	818.340.7598	
George Rodriguez	6527 Laramie Ave	Winnetka	91306	818.340.7598	
Steve Hoffman	18801 Ventura Blvd	Tarzana	91356	818.708.2001	shoffman@moderncontinental.com
Dolores Kuipers	7841 Reseda Blvd, #324	Reseda	91335	818.345.5240	
Charles Powell	147 Ave Alipaz	Walnut	91789	909.595.9621	
Bob Poer					
Norma Bunzel	6443 Winnetka	Winnetka	91306	818.340.6737	
William Bennett	20502 Hamlin	Winnetka	91306	818.348.3484	
Cheryl Gerger	19924 Archwood St	Winnetka	91306	818.887.6915	
Edward Kaiserski	21027 Lanark	Canoga Park	91304	818.882.2398	
Ryan Oliver	21221 Oxnard Street	Woodland Hills	91601	818.713.3669	

4/24/2003



Comments

Name	Address, Email, Phone	Add to Mailing List?	Summarized Comment
Blanca Lloyd	17808 Sherman Way #235 Reseda, 91335 818.345.4706	Yes	<ul style="list-style-type: none"> ▪ <>To Translation>>
Venancio Gutierrez	venanciogutierrez@hotmail.com		<ul style="list-style-type: none"> ▪ Uses transit daily (bus and Red Line). ▪ Buses are overcrowded. ▪ Most transit users are traveling from SFV to Downtown/Union Station. ▪ Doesn't believe a North/South system can ease traffic. ▪ No preference for any of the project alternatives. ▪ Doesn't support the East/West BRT. ▪ Supports the alternatives that includes BRT stops at Winnetka Avenue, rather than Mason Avenue. ▪ Alternative selected should provides better connections with other bus routes. ▪ Opposes all project alternatives. ▪ Supports an east-west subway extension.
Lee Bunzel	6443 Winnetka Ave Winnetka, 91306 leebunz@aol.com	Yes	
Carol Wohlgomuth	20532 Hamlin St Winnetka, 91306 Cwohlg1776@aol.com 818.594.5704	Yes	
Louis Rosenberg	20420 Orey Place Winnetka, 91306 loroznen@aol.com 818.347.3167	Yes	
Dolores Kuipers	7841 Reseda Blvd, #324 Reseda, 91335 818.345.5240	Yes	<ul style="list-style-type: none"> ▪ Very satisfied with public outreach efforts: close to public transportation and evening meeting is convenient. ▪ Wants to become more involved in planning efforts. ▪ Wants to have surveys mailed to her house. ▪ Supports increased services on existing routes. ▪ Local travel from Mason to Roscoe is a priority.
William Bennett	20502 Hamlin Winnetka, 91306 818.348.3784	Yes	
Charles Powell	147 Ave Alipaz Walnut, 91789 cmtap@msn.com 909.595.9621	Yes	<ul style="list-style-type: none"> ▪ Supportive of Rapid Bus deployment in region.

Edward Kaiserski	21027 Lanark St Canoga Park, 91304 818.882.2398	Yes	<ul style="list-style-type: none"> ▪ Would like to see Route 150 extended north to Devonshire. ▪ Would like to move Route 750 to Topanga and East of Reseda Boulevards, along Ventura Blvd. ▪ Suggests increased service on Desoto during “off-hours”. ▪ Very satisfied with Metro Red Line service. ▪ Supports Canoga Alternative.
Jack Atlas	10814 Gaynor Avenue Granada Hills, 91344	Yes	<ul style="list-style-type: none"> ▪ Supports Canoga Alternative.
John Danko	11410 Pala Mesa Drive Northridge, 91326	Yes	<ul style="list-style-type: none"> ▪ Supports Canoga Alternative.
Jeannine Engelhart	6701 Ruffner Avenue Van Nuys, 91406	Yes	<ul style="list-style-type: none"> ▪ Supports Canoga Alternative.
Laird Hepburn	333 South Hope Street Los Angeles	No	<ul style="list-style-type: none"> ▪ Connect the north end of the Reseda Line to the Northridge Metrolink station.
Francine Oschin	16027 Royal Oak Road Encino, 91436	Yes	<ul style="list-style-type: none"> ▪ Supports Canoga Alternative. The MTA owns the right-of-way. ▪ Wants to see some buses continue to the Chatsworth Industrial Park, bringing people from Metrolink to Warner Center. ▪ Supports Canoga Alternative.
James Quinn	8353 Buffalo Avenue Panorama City, 91402	Yes	<ul style="list-style-type: none"> ▪ Supports Canoga and Sepulveda Alternatives.
Sar Ali	8831 Moorcroft Avenue West Hills, 91304	Yes	<ul style="list-style-type: none"> ▪ Auto Row Business Improvement District does not support Alternative 6. The BID has made a significant investment in landscaping and building medians along Van Nuys Boulevard. ▪ Supports Sepulveda Alternative.
Stacey Siegel	5855 Van Nuys Blvd Van Nuys, 91401 ssiegel@keyescars.com	Yes	<ul style="list-style-type: none"> ▪ Supports Sepulveda Alternative.

North Hollywood Meeting

Date: Tuesday, September 10, 2002
5:00 – 8:00 p.m.



Location: North Hollywood Recreation Center
11430 Chandler Boulevard, North Hollywood

In Attendance:

Kevin Michel, MTA	Lee Ward, MMA
Roger Martin, MTA	Bryan Mayeda, MMA
David Armijo, MTA	Adolfo Ozaeta, MMA
Marta Maestas, MTA	Manuel Soto, TDM
Mike Brewer, MTA	Gene Anderson, Ultrasystems
Eric Rapp, MTA	Elaine Carbrey, Gruen Associates
Susan Bok, City of Los Angeles	Andrew Mondschein, Gruen Associates
Kathleen Sanchez, MTA	Clarissa Filgioun, TRG
Michael Meyer, MMA	Ginny-Marie Case, TRG

Meeting Summary

This was the second of three community meetings for the San Fernando Valley North-South Transit Corridor Study. The purpose of this meeting was to introduce the proposed project alternatives to the community and to solicit feedback from meeting attendees. A PowerPoint presentation ran throughout the meeting, explaining the purpose of the Study. Presentation materials included specific information about current conditions, project alternatives and urban design ideas.

Approximately 22 members of the public attended the meeting. The Open House format of the meeting allowed community members to speak one-on-one with the project consultant team and MTA employees. Representatives from the MTA's SFV Sector and the East/West BRT were present during the meeting to speak with the public.

Many of the meeting attendees inquired regarding the status of the East/West corridor study. Other attendees were encouraged by the opportunity to participate in the scoping efforts, and looked forward to more opportunities to participate as the Study moves forward. Staff fielded questions about why BRT was being proposed (rather than light rail which was supported by a number of attendees) and were very interested in possible landscaping and shelter treatments. Participants were not supportive of the I-405 alternative, and a number felt that more service needs to be provided in the Sylmar area, north of the Metrolink station. Also, support for increased transit connections with the Santa Clarita Valley was vocalized.

Written comments were received from nine attendees. Many supported better connectivity with other transit elements serving the Valley, but looked more favorably on light rail than BRT. This group was particularly interested in urban design and landscaping, but the written comments received relating to the alternatives reflected support for the Sepulveda, Reseda and Laurel Canyon Boulevard alignments. Submitted comments also included suggestions for increased service on specific existing bus routes, as well as enhanced amenities such as benches and signage.



In Attendance

Name	Address	City	Zip	Phone	Email
Jack E. Smith	7323 Camellia Ave	North Hollywood	91605	818.982.5819	
Dorothy Beffman	1825 N. Berendosn	Los Feliz	90027	323.669.3880	
Frank Schroder	10329 Valley Glow Dr.	Sunland	91040	818.353.4492	
Charles Thoros	10827 Oysego St.	North Hollywood	91601	818.980.8459	Charlest@cvio6.ca.gov
Henry David Keesing	5245 Bakman Ave 6A	North Hollywood	91601	818.769.9637	
Chambise Koracevich	6350 Laurel Cyn Ave	North Hollywood	91606	818.755.7676	ckoracevich@council.lacity.org
John Barma	35 N. Lake Ave #640	Pasadena	91101	626.440.9377	jbarma@planningcompany.com
Sondra Mercer	5751 Vista Del Monte	Van Nuys	91411	818.780.7206	
John Robert					
Stuart Bogartz	16904 Citrona	Northridge	91343	818.348.9894	
Nathan Zablen	4301 Fulton Ave #201	Sherman Oaks	91423		
Peer Ghent					
Paul Arney	111 E Broadway, Suite 205	Glendale	91205	818.240.6330	Paul.arney@asm.ca.gov
Bill Rains	6301 Coldwater Canyon	Valley Glen	91606	818.761.8075	
Anthony Cruzi	15424 Camarillo St	Sherman Oaks	91403	818.987.1027	anthcur@aol.com
Bud R.					
Gerald Silner	P.O. Box 260205	Encino	91426		gsliner@sprintmail.com
Cecelia Nowlin	P.O. Box 260456	Encino	91426	818.292.3629	cecelianowlin@hotmail.com
Florence Omens	6647 Morella Ave	North Hollywood	91606	818.982.8289	
Dion Gazzaruso	11614 Hesby St	Valley Village	91601	818.752.8060	
Lorna Boyd	15437 Camarillo	Sherman Oaks	91403	818.986.6557	
Terry O'Shaughnessy	6143 Cartright Ave	North Hollywood	91606		

Comments

Name	Address, Email, Phone	Add to Mailing List?	Summarized Comment
Isabel Morro	10706 Victory Blvd North Hollywood, 91606	Yes	<ul style="list-style-type: none"> ▪ System needs to be networked better. ▪ Develop more accurate schedules. ▪ Wished more people would utilize existing transit. ▪ Supports Light Rail construction in SFV.
Bill Rains	6301 Coldwater Canyon #12 Los Angeles, 91606 818.761.8075		
Nathan Zablen	4301 Fulton Ave, #201 Sherman Oaks 91423	Yes	<ul style="list-style-type: none"> ▪ Would like to see project alternatives include Sylmar as a destination. ▪ Supportive of Ventura BRT with stops at Ventura Blvd. and Desoto. ▪ Supportive of increased service on Route 243, along Winnetka and Desoto. ▪ Would like to see increased service for Pierce College on Winnetka and Kaiser Hospital on Desoto. ▪ Would like to see a train from Moorpark to Union Station. ▪ Supportive of increased Amtrak service in SFV. ▪ Supportive of light rail in the SFV. ▪ Would like more information about network connectivity to LAX
Sondra Mercer	5752 Vista Del Monte Van Nuys 91411 818.780.7206	Yes	<ul style="list-style-type: none"> ▪ Most supportive of alternatives that include Sepulveda, Reseda, and Laurel Canyon Boulevards. ▪ Supportive of alternatives along Tampa Avenue, Canoga Avenue and Topanga Canyon Boulevard ▪ Would like more information about benefits of BRT over regular bus service. ▪ Would like to see additional signage to alert riders when next bus is to arrive. ▪ Supports placement of benches at BRT stops. ▪ Greatest need at Lankershim to Northeast Valley, based on her experience on Route 166. ▪ Supports increased bus service and intervals. ▪ Would like to see schedule and map at every stop. ▪ Requests that shade be provided at bus stop.
Henry David Keesing	5245 Bakman Ave 6A North Hollywood, 91601 818.769.9637	No	
Florence Omens	6647 Morella Ave North Hollywood, 91606 818.982.8289	Yes	


Stuart Bogarzt	United Chambers, Transportation Committee		
Lorna Boyd	15437 Camarillo Sherman Oaks, 91403 818.986.6557	Yes	<ul style="list-style-type: none"> ▪ Supports route from Chandler-Lankershim/ West to Van Nuys Blvd, to Sherman Way along Van Nuys, to Metrolink station at Raymer St, to San Fernando Road, to Sylmar Metrolink Station. ▪ Supports electric trolley buses, replacing natural gas buses. ▪ Supports the construction of overhead trolley bus wires, in hopes of light rail development, when funds become available. ▪ Supports avoiding the Sepulveda and Ventura Boulevard intersection.
Anthony Curzi	15424 Camarillo Street Sherman Oaks, 91403 818.981.1027 anthcur@aol.com	Yes	<ul style="list-style-type: none"> ▪ Disappointed that none of the alternatives include service to the Cascades Business Park in Sylmar. ▪ Would like to consider Olive View Medical Center as a possible terminal. ▪ Would like to see improvements in local bus service, with ideal headways of 10-12 minutes. ▪ Supports placing service on Kester, Fulton, and Hazeltine. Van Nuys Boulevard Route 233 would be extended west on Ventura to Kester, and north to Saticoy.



City of San Fernando Meeting

Date: Thursday, September 12, 2002,
5:00 - 8:00 p.m.

Location: City of San Fernando Recreation Center
Gymnasium
208 Park Avenue, San Fernando

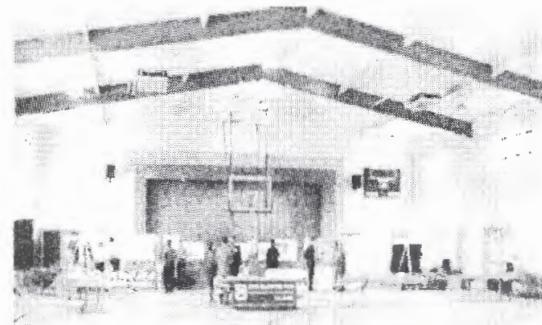

Attendees:

Roger Martin, MTA
David Armijo, MTA
Marta Maestas, MTA
Mike Brewer, MTA
Eric Rapp, MTA
Susan Bok, City of Los Angeles
Edwin Galvez, City of San Fernando
Michael Meyer, MMA

Viggen Davidian, MMA
Adolfo Ozaeta, MMA
Lee Ward, MMA
Manuel Soto, TDM
Andrew Mondschein, GA
Clarissa Filgioun, TRG
Ginny-Marie Case, TRG

Meeting Summary

This was the last of three community meetings for the San Fernando Valley North-South Transit Corridor Study. The purpose of this meeting was to introduce the proposed project alternatives to the community and to solicit feedback from meeting attendees. A PowerPoint presentation ran throughout the meeting, explaining the purpose of the Study. Presentation materials included specific information about current conditions, project alternatives and urban design ideas.

Approximately 31 members of the public attended the meeting. The Open House format of the meeting allowed community members to speak one-on-one with the project consultant team and MTA employees. Representatives from the MTA's SFV Sector were also present during the meeting to speak with the public.

Of the submitted written comments, there was most support for the Canoga right-of-way and Van Nuys Boulevard alternatives. Also, there was interest in the development of a transit connection from Mission College to CSUN. A MTA bus operator attending as a member of the public invited the project team to attend the next union meeting to solicit input from the bus operators on these routes.

In Attendance

Name	Address	City	Zip	Phone	Email
James Hogan	27601 N Bernina Ave	Canyon Country	91351		
Bart Reed					
Abbie Rosenberg					
Steve Angarita	117 Macneil	San Fernando	91340	818.898.1242	sangarita@sfcity.org
Angel Avila	93191 Louvre Street	Pacoima	91331	818.899.0837	
Ron Ruiz	117 Macneil	San Fernando	91340	818.898.1237	Rruiz@ci.san-fernando.ca.us
Jeanette Davialos	13965 Candlewood Dr.	Sylmar	91342	818.356.0290	
Paul Dentzel	P.O. Box 280101	Northridge	91328	818.349.8020	Saharaexpress@telis.org
Paul Deibel				818.898.1232	pdeibel@ci.san-fernando.ca.us
David Whiteman	16804 Severo Place	Encino	91436	818.789.4176	david@autopsy.com
Roger Christensen	14335 Huston #205	Sherman Oaks	91423	818.995.4859	Rog4rail.com <incorrect>
Jose Hernandez	652 S Brand Street	San Fernando	91340	818838.2023	
James Wilson	11816 Joulett Street	Pacoima	91342	818.756.9115	
Tim Steuam	8352 Costello	Pacoima	91331	818.892.9478	lldstud@earthlink.net
Edwin Ramirez	12335 Osborne Place	Pacoima	91331	818.383.8499	ramediv@yahoo.com
Roger Everett	8600 International Avenue	Canoga Park	91304	818.886.0086	
William Petty	13060 Wheeler Ave	Sylmar	91342	818.365.7888	
John Robert					
Pam Hogan	27601 N Bernina Ave	Canyon Country	91351		
E.H. Patotzka	8415 Eitwanda Ave	Northridge	91325		
Pat O'Connor	P.O. Box 330333	Pacoima	91333	818.366.4333	

Submitted Comments

Name	Address, Email, Phone	Add to Mailing List?	Summarized Comment
Roger Everett	8600 International Avenue Canoga Park, 91304 818.886.0080		<ul style="list-style-type: none">▪ Supportive of the Canoga Alternative.▪ Encourages improvements along Van Nuys Boulevard.▪ Would like to see increased bus service during evenings.▪ Project needs additional outreach to City of San Fernando▪ Reach out to neighborhood councils.
Robert Focosi	12314 Willow Way Pacoima, CA 91331 818.899.0602 mactl@aol.com	Yes	



Additional Comments

Comments submitted via US Mail

Name

David Goldstein
9941 Comanche Avenue
Chatsworth, CA 91311

Summarized Comment

- ❖ Read article in 8/29/02 Daily News
- ❖ Supports I-405 alternative from SFV to Westwood
- ❖ Would like to see a park/ride developed at Sherman Oaks Galleria and at Federal Building in Westwood
- ❖ Supports construction of a subway or light rail line along I-405
- ❖ Believes that adding more buses won't resolve congestion

Emaline Rich
6445 Lubao Avenue
Woodland Hills, CA 91367

- ❖ Discouraged by long wait for bus service
- ❖ Supports construction of a subway or light rail line

Lillian Michaels
11035 Magnolia Boulevard, Apt 205
North Hollywood, CA 91601

Comments submitted via email

Name

Soraya Dosaj
famdosaf@earthlink.net

Comment

- ❖ Supports Van Nuys Boulevard alternative
- ❖ Replace some existing service with BRT

Faramarz Nabavi
fnabavi@wso.williams.edu

- ❖ Would like to see more buses placed in SFV sector
- ❖ Develop BRT that uses I-405
- ❖ Opposes spending money on Transit Corridor Study; would prefer to see improvements to specific SFV sector routes
- ❖ Utilize shuttle service for less traveled routes
- ❖ Shuttle drivers should be MTA drivers, able to be members of the union
- ❖ Do not eliminate local bus service for BRT
- ❖ Supports better connection to existing rail corridors
- ❖ Would like to see a transit network connecting rail and bus corridors, e.g. Sepulveda from SFV to Long Beach
- ❖ Construction of a transit corridor along Old Santa Monica Boulevard from Westwood to West Hollywood.

Dennis Allard
allard@oceanpark.com

Media

Los Angeles Times: 10 Possible Routes Identified for Valley Public Transit Corridor

Page 1 of 2



<http://www.latimes.com/news/local/la-me-corridor31aug31.story>

LOS ANGELES

10 Possible Routes Identified for Valley Public Transit Corridor

By CAITLIN LIU
TIMES STAFF WRITER

August 31 2002

The Metropolitan Transportation Authority has identified 10 potential routes for a north-south public transit corridor in the San Fernando Valley, officials said Friday.

The proposed paths, which could include dedicated bus lanes, range from Topanga Canyon Boulevard in the west to Vineland Avenue in the east. One possible plan would run buses down the San Diego Freeway. Other possibilities include Canoga and Woodley avenues, San Fernando Road, and Reseda, Sepulveda, Van Nuys and Lankershim boulevards. Several of the routes would connect Metrolink or subway stations.

The transit agency's other options include increasing regular bus service on existing routes, adding more Metro Rapid bus lines, or doing nothing.

One of the agency's goals is to provide quicker connections from Ventura Boulevard's Metro Rapid bus line to the future east-west busway, which will use a defunct rail corridor on Chandler and Victory boulevards to provide transit between Warner Center in Woodland Hills and the North Hollywood Red Line subway station, said Rick Jager, an MTA spokesman. The 14-mile busway is scheduled to open in spring 2005.

The proposals for the north-south corridor were generated by a \$1-million, one-year study that began in May. The proposals are in their early stages and the study has not yet identified costs, Jager said.

MTA staff and consultants plan to present the top one or two options to the agency's board early next year. About \$100 million in state funding has been secured for the project. Already, bus-rider advocates are expressing concerns about the possibilities.

The proposed routes ignore most of Sylmar, said Bart Reed, executive director of the Transit Coalition, a rider advocacy group based in that community. "I'm extremely perturbed," he said.

The transit agency plans to hold several public hearings on the potential routes.

Meetings are scheduled Sept. 9 in the ground-floor auditorium of Northridge Hospital Medical Center, 18300 Roscoe Blvd.; Sept. 10 in the main gym of the North Hollywood Recreation Center, 11430 Chandler Blvd.; and Sept. 12 in the main gym of the city of San Fernando Recreation Park, 208 Park Ave. Each meeting is expected to run from 5 p.m. to 8 p.m.

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<http://www.latimes.com/templates/misc/printstory.jsp?slug=la%2Dme%2Dcorridor31aug31>

9/12/2002

Los Angeles Daily News

Valley busway options listed

MTA identifies 12 routes for north-south express
By Lisa Mascaro
Staff Writer

Wednesday, August 28, 2002 - By Lisa Mascaro, Staff Writer The MTA has identified 12 possible routes for a new north-south busway through the San Fernando Valley as part of a plan to attract new riders, move them faster and improve connections to other lines.

Armed with \$100 million in state money won by Valley leaders two years ago for the project, planners have sketched out a dozen possible streets to link the city of San Fernando in the north to Ventura Boulevard in the south.

The north-south busway would provide a key link to the Rapid Bus already operating on Ventura, the end of the subway line in North Hollywood and the east-west busway already planned to connect the subway to Warner Center.

The new line could utilize a buses-only lane in some sections or during rush hour. It most likely would employ technology like that used on Ventura and on Wilshire Boulevard with red Rapid Buses that control traffic lights to reduce travel time.

"This is a tremendous benefit to the San Fernando Valley. Now we're really taking a wonderful glance at a north-south transit corridor," said Roger Martin, the Metropolitan Transportation Authority's project manager.

Many transit activists see the north-south busway as a crucial next step to improving public transit in the Valley by providing faster buses and a link to other services.

The proposals will be presented during community meetings in early September before MTA planners narrow the options to a few choices for the MTA board to vote on in early 2003, about the time construction is scheduled to begin on the east-west busway.

"There will be palpable improvement in the quality and speed of the bus service in the San Fernando Valley as a result," said Los Angeles County Supervisor and MTA board member Zev Yaroslavsky.

"It will make a difference. ... There's a certain critical mass where it begins to make a difference. ... Suddenly the San Fernando Valley will be connected both intra- and inter- in the rest of the system."

Valley transit activists welcomed the plans as a step toward fixing the MTA's service in the Valley, which leaders have long complained has been neglected.

"Trips are jammed. ... It's like sardine cans," said Valley resident Bart Reed, executive director of the Transit Coalition and a regular bus and train user.

"It's not a panacea, a solve-all. It's definitely a step up from what we have today."

The money could fund one, and possibly two north-south routes, and is likely to be supplemented with other funding sources, officials said.

Plans show a dozen preliminary choices for the route through the San Fernando Valley, including up and down Topanga Canyon Boulevard and Canoga Avenue on the west; Reseda Boulevard and Woodley/Haskell avenues in the central Valley; and Sepulveda Boulevard, Van Nuys Boulevard and Lankershim Boulevard in the east.

One proposal calls for putting the route along the San Diego Freeway, between the Valley and Westwood.

Planners have not yet determined how the buses would travel along the route - whether they would run on exclusive lanes like the new east-west busway down Burbank Boulevard that will connect the Red Line station in North Hollywood to Warner Center.

Taking away a vehicle lane for buses would prove an explosive political issue on streets jammed with cars, shops and parking, like Van Nuys Boulevard, some said.

However, on the Canoga Avenue route, the MTA owns an old rail line on the east side of Canoga that could be a candidate for a bus-only lane.

Planners said that the north-south route could have a combination of dedicated bus-only lanes in some sections or only during rush-hour periods, and could also rely on parking restrictions to make room for buses.

Continued on next

"We want to have this dialogue with the public and have them help us shape the alternatives that we take along for further study," said Kevin Michel, the MTA's planning director for the San Fernando Valley/North County areas. "We're at this point, there are a number of good corridors out there ... These are sort of a menu of options that we at staff have come up with."

Reed, the transit activist, said an exclusive bus route like the east-west busway would clearly provide an advantage, but that the political costs might be too great.

"Exclusive lanes are definitely one way that can get a leg up to the transit consumer. Political will is another question," he said.

"Merchants and a lot of the motorists would have such an uproar. ... The irony is (an) exclusive, bus-only lane would actually be more efficient in moving people."

But he and others said that even without a bus-only lane, the MTA's preliminary plans could go a long way toward improving service.

Ticket vending machines at the bus stops, for example, could shorten the time a driver must wait while riders pay their fare and wait for change.

Improved bus stops with benches and landscaping, along with new park-and-ride lots, as the MTA is considering, could entice drivers to get out of their cars and ride the bus for part of their commute.

Yaroslavsky said that even without a dedicated lane, the north-south route could provide a needed element to the overall transit choices in the Valley.

Planners said they looked at the population and employment centers in the Valley, as well as areas of heavy bus use, to determine proposed streets for the new route.

Van Nuys Boulevard, where the MTA is also planning to put a red Metro Rapid Bus route in 2003, is among the Valley's busiest routes, with 16,000 daily boardings on an average weekday, officials said.

Warner Center, the Van Nuys Government Center and the Burbank Media Center also emerged as high-density employment centers.

Van Nuys Boulevard is Reed's top choice for the north-south route, with the Lankershim/San Fernando Road route No. 2. Both of those, along with Sepulveda, he said, were priority routes in the Valley - though he was interested in the MTA's plans for West Valley streets. COMMUNITY MEETINGS Community meetings on the San Fernando Valley North-South Transit Corridor Study will be held 5-8 p.m. on Sept. 9 in the Educational Auditorium at Northridge Hospital Medical Center, 18300 Roscoe Blvd.; Sept. 10 at North Hollywood Recreation Center, 11430 Chandler Blvd.; and Sept. 12, San Fernando Recreation Park, Main Gym, 208 Park Ave.

For more information, call the San Fernando Valley North-South Information Line at (818) 701-2855 or visit www.mta.net.

Comments can be sent by e-mail to martinr@mta.net or by mail to Countywide Planning & Development, M/S99-22-9, Attention: SFV North/South MIS Study, One Gateway Plaza, Los Angeles, CA 90012-2952. All comments must be received by Sept. 13.

Los Angeles Daily News

Get on the bus

The Valley inches toward decent public transportation

Friday, August 30, 2002 - STEP by step, the San Fernando Valley moves ever closer to obtaining better public transportation.

Last week, the Metropolitan Transportation Authority identified 12 possible routes for a new north-south Valley busway. The busway, by tying up some loose ends in local mass transit, would provide better service for the transit-dependent and ease traffic by taking cars off the road.

None of the plans, of course, is perfect, but there's no such thing as a perfect solution to a thorny and complicated problem. But when service is as bad as it is in the Valley, anything is better than nothing.

In the interest of improving quality of life throughout the Valley, some sacrifices will need to be made, and the MTA must do its best to mitigate the impact of whatever plan it chooses.

And while buses aren't the long-term solution to mass transit - that will probably involve subways, light rail or both - they're a first step. Thanks to Assemblyman Bob Hertzberg and others, the MTA got \$100 million in state funds for this project, and spending that money wisely will improve the Valley's prospects for additional funds in the future.

Whichever plan the MTA settles on, it's in the best interest of all Vals to fully support it.

Los Angeles Daily News

MTA hears gripes about busway, more

By Ryan Oliver
Staff Writer

Monday, September 09, 2002 - Twelve recently unveiled proposals for a new north-south busway through the San Fernando Valley received a lukewarm reception Monday at a public hearing attended largely by critics of the MTA.

Many who attended were largely oblivious to the north-south busway proposals and simply wanted to express dissatisfaction with unrelated issues.

Others wanted to remind the Metropolitan Transportation Authority that there was still opposition to the \$330 million east-west busway and that the agency needs to resolve that issue before it moves on to other projects.

Bart Reed, executive director of the Transit Coalition, said he showed up to remind MTA officials of Sylmar's existence. None of the 12 proposed north-south busway routes goes north of the Sylmar-San Fernando train station and into the heart of the community.

"Because this community is so transit-dependent, we deserve to be part of this study," Reed said. "We have the highest levels of poverty and dependency on public services."

Also left out of the proposals are any connections to Olive View Hospital or Mission College.

Kevin Michel, director of the MTA's San Fernando Valley-North County Area Team, said he was aware of Reed's concerns and said the agency will look into shuttle or feeder service from the northernmost stop of the busway and into areas of Sylmar.

The meeting was one of three the MTA plans to hold around the Valley to show the proposed routes and garner community comment.

COMMUNITY TRANSIT MEETING

You will also have an opportunity to talk one-on-one with MTA service planning staff about routes, service, schedules, and any other bus service related issues.

JOIN US AT ONE OF THREE OPEN HOUSES

WEST VALLEY:

Northridge Medical Hospital
Monday, September 9th; 5 – 8 pm
18300 Rascoe Boulevard, Northridge
Educational Auditorium (Ground Floor)

SOUTH VALLEY:

North Hollywood Recreation Center
Tuesday, September 10th; 5 – 8 pm
11430 Chandler Boulevard
North Hollywood
Main Gym

NORTH VALLEY:

City of San Fernando Recreation Park
Thursday, September 12th; 5 – 8 pm
208 Park Avenue, City of San Fernando
Main Gym

03-0113

REUNION COMUNITARIA (OPEN HOUSE)

MTA DESEA SABER SU OPINIÓN

Los Angeles County Metropolitan Transportation Authority invita a usted a una de una serie de reuniones comunitarias para enterarse sobre el Estudio de Transporte del Eje Vial Norte-Sur del Valle de San Fernando y al mismo tiempo opinar sobre como mejorar el transporte público en su comunidad. El estudio considerará alternativas para proveer un corredor Norte-Sur de alta capacidad en el Valle de San Fernando que pueda conectarse mejor con los otros dos ejes viales San Fernando East/West Metro Rapid Transitway y el Metro Rapid del bulevar Ventura.

Por favor, venga a obtener información y a hacer comentarios sobre varias alternativas de norte a sur que han sido identificadas hasta ahora para el Valle de San Fernando. Su participación es vital para escoger y darle prioridad a una de esas alternativas y poder efectuar mayores estudios.



REUNIÓN COMUNITARIA DE TRANSPORTE

Usted tendrá también la oportunidad de hablar personalmente con representantes del Departamento de Servicios de MTA acerca de las rutas, servicio, horarios, y muchos otros temas relacionados con el servicio de autobuses.

VISITENOS EN CUALQUIERA DE ESTAS TRES REUNIONES COMUNITARIAS

WEST VALLEY:

Northridge Medical Hospital
Lunes 9 de septiembre; de 5 a 8 p.m.
18300 Roscoe Boulevard, Northridge
Educational Auditorium (planta baja)

SOUTH VALLEY:

North Hollywood, Recreation Center
Martes 10 de septiembre; de 5 a 8 p.m.
Chandler Boulevard, North Hollywood
Gimnasio Principal

NORTH VALLEY:

City of San Fernando Recreation Park
Jueves, 12 de septiembre; de 5 a 8 p.m.
208 Park Avenue, Ciudad de San Fernando
Gimnasio Principal

Para más información sobre esta y otras reuniones públicas, favor de llamar a San Fernando Valley North-South Information Line en el (818) 701-2855 o visite nuestra página electrónica www.mta.net y oprima en "Transit Corridor Studies".

Si usted no puede atender, pero le gustaría hacer algún comentario, por favor envíe un correo electrónico a martinr@mta.net o escribanos a MTA, Atención SFV North/South MIS Study, M/S 99-22-9, One Gateway Plaza, Los Angeles, CA 90012. Sus comentarios deben de ser recibidos antes del 13 de septiembre de 2002 para que sean tomados en cuenta.

COMMUNITY OPEN HOUSE

MTA WANTS TO HEAR FROM YOU!

The Los Angeles County Metropolitan Transportation Authority invites you to join us at one of the series of open houses to hear about the San Fernando Valley North-South Transit Corridor Study and provide input to improve Community Transit. The study will look at alternatives to provide a high capacity north-south transit corridor in the San Fernando Valley that would best connect with both the San Fernando East/West Metro Rapid Transitway and the Ventura Boulevard Metro Rapid.

Please come hear about, and provide comments on, numerous north-south alternatives currently identified for the San Fernando Valley. Your feedback will be vital as we narrow down and prioritize these alternatives for further study.



Advertisements

COMMUNITY OPEN HOUSE

MTA WANTS TO HEAR FROM YOU!

Join us at an open house to hear about the San Fernando Valley North-South Transit Corridor Study and provide input to improve your community transit.

You will also have an opportunity to talk one-on-one with MTA service planning staff about routes, service, schedules, and any other bus service related issues.

West Valley:

Northridge Medical Hospital

Monday, September 9th; 5 – 8 pm

18300 Roscoe Boulevard, Northridge

Educational Auditorium (Ground Floor)

South Valley:

North Hollywood Recreation Center

Tuesday, September 10th; 5 – 8 pm

11430 Chandler Boulevard,

North Hollywood

Main Gym

North Valley:

City of San Fernando Recreation Park

Thursday, September 12th; 5 – 8 pm

208 Park Avenue, City of San Fernando

Main Gym

For more information please call 818-701-2855 or check our website at www.mta.net and click on "Transit Corridor Studies."

If you are not able to attend, and would like to comment, please send an e-mail to martinr@mta.net or write to us at MTA, Attention: SFV North/South MIS Study, M/S 99-22-9, One Gateway Plaza, Los Angeles, CA 90012. Comments must be received by September 13th, 2002 to be considered.



03-0122



SAN FERNANDO VALLEY NORTH-SOUTH TRANSIT CORRIDOR STUDY

Summary of December 2002 Community Open House Meetings

December 10, 2002

Sherman Oaks Women's Club
Sherman Oaks


December 11, 2002

Pierce College, Campus Center
Woodland Hills

December 12, 2002

*City of San Fernando Recreation Park,
Multipurpose Room*
City of San Fernando

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An ECA Company

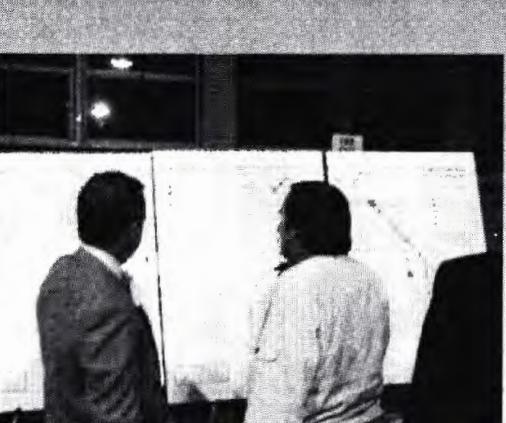January 2003

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Executive Summary

The December 2002 Open Houses were the second and last in a series of opportunities for the community to provide public comment during the MIS phase of the San Fernando Valley North/South Transit Corridor Study. These Open Houses followed a first series of community meetings that were held during September 2002.

To ensure geographic coverage, three Open Houses were scheduled at locations dispersed across the San Fernando Valley, respectively in the southeast Valley at the Sherman Oaks Women's Club, the west Valley at Pierce College in Woodland Hills, and the northeast Valley at Recreation Park in the City of San Fernando. The meetings were held on the consecutive nights of December 10-12 between 5:00 and 8:00 p.m. Information presented at the meetings included the five refined route alternatives, demographic information as well as urban design options.

Approximately 40 members of the public attended these evening meetings. Community members were encouraged to discuss the refined alternatives with members of the project team, as well as provide written feedback by filling out comment forms that were also made available on laptop computers. A total of 12 comments were received via email, as well as in hard copy (both handwritten and via laptop computer) at the Open House meetings. These comments are located in the appendix of this document.

Public input from the meeting revealed that there is considerable support for improved transit on Van Nuys. The Lankershim, Reseda and Sepulveda alignments also received backing largely because of ridership potential, and the possibility of creating a loop serving large portions of Valley that would possibly linking with CSUN. There was also some support for linking the northeast Valley communities of Sylmar, Pacoima, Sun Valley and the City of San Fernando with the North Hollywood Metro Red Line station. At the west Valley meeting, a number of people were in favor of the Canoga Avenue alternative because it links activity centers and would be constructed in the existing railroad right-of-way. However, one participant voiced disappointment that the I-405 alternative was not one of the refined alternatives.

Attendees were pleased to find out that there was potential for improvements to more than one alignment. Many of the written comments noted that current ridership information could support an increase in transit service. Many respondents were encouraged by the potential for increased network connections to other transit service.

To ensure the broadest coverage of publicity for the community about the Open Houses, newspaper advertisements were placed in the Los Angeles Times-Valley Edition, the Daily News, and the San Fernando Sun. Additionally, a bilingual project Fact Sheet/Project Update, which included an invitation to the community meetings, was mailed out to the project database of approximately 6,500. This database had been significantly enhanced since the late summer Open Houses by adding a new list of residents and property owners along those streets potentially impacted by peak parking prohibitions. Approximately 10,000 bilingual take-one announcements were placed on local bus routes, meeting information was posted on the project website at www.mta.net and the project information line was updated to announce the public meetings and website information.

Appendix

Summary of Sign-in Sheets

Sherman Oaks Women's Club, Sherman Oaks — December 10, 2002

Name	Address	City	Zip	Phone	Email
Howard Raphael	4546 Allot Avenue	Sherman Oaks	91423	918.981.9518	hraphael@earthlink.net
Steve Kidd	9232 Dorrington Rd	Arleta	91331	818.892.1252	
Robert Meinert	7161 Hidden Pine Dr	San Gabriel	91775	626.286.9325	meinertr@mta.net
Diana Lipari	5924 Varna Avenue	Valley Glen	91401	818.989.4853	sold@dianalipari.com
Bart Reed			91342	8183671661	
M. Scherzer	6609 Vesper Avenue	Van Nuys	91405		
A. Feld	6612 Vesper Avenue	Van Nuys	91405		
C. Shapiro	6639 Vesper Avenue	Van Nuys	91405		
R. Carnegie	6731 Vesper Avenue	Van Nuys	91405		
Carlos Rios	201 N. Figueroa #505	Los Angeles	90012	213.847.6064	crios@dot.lacity.org
Lan Nguyen	221 N. Figueroa #500	Los Angeles	90012	213.580.5471	lnynguyen@dot.lacity.org

Pierce College Campus Center, Woodland Hills —December 11, 2002

Name	Address	City	Zip	Phone	Email
Bill Dennis	6301 Orion Avenue	Van Nuys	91411	818.902.1922	ritzdennis@earthlink.net
WD Jones	21205 Bryant St	Canoga Park	91304	818.341.1535	Jones8@juno.com
Gary Forbes	20818 Skouras Drive	Canoga Park	91306	818.347.6395	
Glenn Bailey	5926 Hesperia Avenue	Encino	91316	818.344.1992	Glenn.bailey@csun.edu
Steve Carletti	22241 Burton St	Canoga Park	91304	818.347.9284	quoteman@ix.netcom.com
Paul Abrams					
Francine Oschin	16027 Royal Oak	Encino	91436	818.906.8728	
Pauline Tallent	20205 Saticoy St	Winnetka	91306	818.998.3833	talent@instanet.com
Dorothy Bennett	20502 Hamlin St	Winnetka	91306	818.348.3784	
Bill Bennett	20502 Hamlin St	Winnetka	91306	818.348.3784	
Rob Vinson				818.341.1611	mvpdev@pacbell.net
Glen Wilson	18925 Citronia St	Northridge	91324	818.886.3534	
Robert Wilson	18925 Citronia St	Northridge	91324	818.886.3534	
Gordon Murley	4128 Murro Dr	Woodland Hills	91364	818.346.5842	g.murley@worldnet.att.net
Swathi Kadur	20518 Germain St	Chatsworth	91311		muskaansk@yahoo.com
Normal Lau	6539 Platt Avenue	West Hills	91307		norlau@juno.com
Nate Zablen	4301 Fulton Avenue	Sherman Oaks	91423		
Roger Dames	12256 Catronia Dr	Granada Hills	91344	818.363.5696	damesr@mta.net

Recreation Center, Multipurpose Room, City of San Fernando

— December 12, 2002

Name	Address	City	Zip	Phone	Email
Shannon Smith	35 N Lake Avenue	Pasadena	91101	626.4409377	ssmith@planningcompany.com
Mayor Jose Hernandez		San Fernando	91340	818.898.1201	
Frank Schroder	10329 Valley Glow Dr	Sunland	91040		
Sevana Mailian	6251 Van Nuys Boulevard	Los Angeles		818.756.9936	smailian@lacityplanning.org
Bart Reed		Sylmar	91342		
R. Benseman	22020 Ventura Boulevard	Woodland Hills	91364	818.884.1500	
Logan Wilbur	19512 Roxford St	Sylmar	91342	818.367.2345	
Ben Wilbur	19512 Roxford St	Sylmar	91342	818.367.2345	
Craig Howell	10557 Danube Avenue	Granada Hills	91344	818.891.3412	
Paul Deibel	City of San Fernando				
David Goldstein	9941 Comanche Avenue	Chatsworth	91311	818.709.9737	digoldst@earthlink.net
Bob Sandoval	10250 Haskell Avenue	Granada Hills	91344-7200	818.359.8087	

Summary of Comments

Name	Summarized Response
Frank Schroder 10329 Valley Glow Drive Sunland, CA 91404 818.353.4492 frankrtd73@aol.com	<ul style="list-style-type: none">• Lankershim Boulevard should be a top priority alignment• Van Nuys should be the second priority alignment• Would like to see a direct connection with Sylmar, Pacoima, San Fernando and Sun Valley to the North Hollywood Red Line Station• Increased local bus service• Supports the Reseda Boulevard as the best north/south route• Does not support the Canoga ROW
Glen Wilson 18925 Citroni Street Northridge, CA 91324 818.886.3534	
Diana Lipari sold@dianalipari.com	<ul style="list-style-type: none">• Would like PDFs of proposed corridors
Howard Raphael 4546 Allot Avenue Sherman Oaks, CA 91423 818.971.9518	<ul style="list-style-type: none">• Would like copies of all maps
William Dennis 6301 Orion Avenue Van Nuys, CA 91411 818.902.1922 Rit2dennis@earthlink.net	<ul style="list-style-type: none">• Lankershim Boulevard/San Fernando Road, Van Nuys Boulevard, and Reseda Boulevard alternative• Alignments make sense, as they outline where the ridership exists.• Would like to see three routes built

Electronically Submitted Comments

Name	Response
Gary Forbes	I think that MTA has gotten off to a good start. I would like to see a north-south possibly along Canoga Avenue to service the business on the west side of Canoga from the Chatsworth Station to Victory and possibly east and west to Burbank so the student body at Pierce and Valley Junior Colleges could receive their passengers from different points along the way. There are some really good ideas for CSUN. Burbank Airport needs to be better served by transit.
Nate Zablen 4301 Fulton Ave # 201 Sherman Oaks, Ca. 91423 nzab48@yahoo.com	Reseda Boulevard, Sepulveda Boulevard, and Lankershim Blvd would be good choices for the Transit Corridor. The Sepulveda Corridor should continue on to West Los Angeles and possibly LAX by means of an HOV lane or exclusive bus lane on the 405 Freeway. There is also a need for an East/West Rapid Bus Route on Roscoe Boulevard and possibly Sherman Way. The proposed Rapid Bus line on Van Nuys Boulevard should be implemented as soon as possible. A North/South corridor along the Canoga right-of-way should also be considered.
Francine Oschin 16027 Royal Oak Encino, CA 91436 818 906-8728	I believe the Canoga Ave. route is the best choice. It is a dedicated right-of-way on a street with no bus service. It connects to the Chatsworth Metrolink and Warner Center. It goes through a modest income area which includes a number of mobile home parks as well as an industrial area. It makes sense and does not disrupt business. Canoga is the way to go.
Norman Lau norlau@juno.com	I vote for the Van Nuys corridor where the bus riders are. I believe the line should be extended up thru Sylmar and on the southern end, join up with the 750 line and head toward Universal. The latter will shorten the time patron heading for the Red line will have to ride as they need not transfer to the 750.
Pauline Tallent 20205 Saticoy St. Winnetka, CA 91306 818-882-0946 tallent@instanet.com	The Canoga Avenue route in the West Valley makes sense as it connects the Metro Link station with Warner Center. This route could possibly alleviate traffic on the #101. With the construction due to start on the Ahmanson Ranch, this North-South route would be very important.
Roger Dames 12256 Catenia Dr. Granada Hills, CA 91344 818 363-5696 RogerDames@aol.com	I believe that the Canoga Avenue railroad right of way and the Van Nuys Boulevard alternatives are the best.

<i>Name</i>	<i>Response</i>
David Goldstein 9941 Comanche Avenue Chatsworth, CA 91311 818-7093731 digoldst@earthlink.net	I appreciated the opportunity to talk with MTA officials today. I support the Sepulveda option, to relieve most of the parallel traffic along the 405 freeway in the North Valley. However, I am disappointed that the 405 option was defeated in preliminary studies. The REAL congestion is along the 405 from the S.O. Galleria to Westwood/LAX. I hope in a future MTA study, there can be serious discussions about a center divider 405 light rail, similar to the Gold Line along the 210 in Pasadena. However, this busway is a good start. I support the Red Line and East-West Chandler route...I hope this connecting bus will support those routes. I plan to take my wife along the Red Line to Staples Center soon. The more connecting routes the better!

Public Comments sent via email and postal mail

---Original Message---

From: William McMahon [mailto:x2nebula@earthlink.net]
Sent: Friday, December 06, 2002 6:27 PM
To: martinr@mta.net
Subject: North south busway

While you are on this plan, I am wondering why a full size bus is needed between Ventura Blvd. and Roscoe, traveling north and south. It passes my house at Hart, while the bus has only a few passengers everytime. Almost, I count 12. It is just a big waste of MTA funds. The bus also speeds by in excess of 40 mph often, causing the soft road of White Oak, designed for 35 mph traffic, to set up vibrations on the houses that are on White Oak. My house shakes like an earthquake, windows rattling and floor shaking. This also happens when large trucks speed by, but the buses are a sure thing and causes the most shaking on a regular basis. White Oak has just been resurfaced, and the road surface is still very uneven, and the houses still shake.
Reseda Blvd to Slymar should be the main route, with only a smaller, lighter connector bus on White Oak, if any. Thank you
Bill McMahon, 7003 White Oak Ave , Reseda, CA 91335 818-757-0349

---Original Message---

From: David Goldstein [mailto:digoldst@earthlink.net]
Sent: Saturday, December 07, 2002 10:45 AM
To: martinr@mta.net
Subject: North South MTA Transit Route

12/08/02

Roger Martin
MTA Project Manager

Roger,

In my mind, the greatest need for public transportation is the NORTH-SOUTH corridor along the San Diego Freeway between the Sherman Oaks Galleria and Westwood.

The 405-101 intersection is the most congested highway intersection in the US, and would be the best option to serve the MOST people in the Valley. I have long been an advocate of public transportation, and I applaud the newly established route along Chandler from North Hollywood to Canoga Park. It was long overdue ! Now its time to take the next step.

Of all the options listed, the San Diego Freeway makes the most sense. Instead of widening the freeway again, what we should do is create a lane in the 405 center divider, like what was done along the 210 freeway for the Pasadena light rail route. A parking lot should be created around the S.O. Galleria for commuters and a bus or light rail route should run in the middle of the San Diego Freeway all the way to the LAX (or if not possible, Westwood). There should be equivalent parking near Westwood and LAX. This would solve the problem of N-S transportation for a tremendous amount of commuters ! It would reduce smog and accidents, as well as commuter time.

I applaud your public forum and will try to make it to San Fernando on the 12th. However, due to family commitments, I may not make it.

Please continue your transportation efforts ! LA desperately needs some transportation fixes. If you build it, they will come ! Just like the Red Line.

Thanks,

David Goldstein
Chatsworth, CA
digoldst@earthlink.net
818-709-3731

-----Original Message-----

From: davidshluker@aol.com [mailto:davidshluker@aol.com]
Sent: Saturday, December 07, 2002 8:16 PM
To: martinr@mta.net
Subject: San Fernando Valley North-South Transit Corridor

To whom it may concern,

We are strongly in favor of constructing the North-South Transit Corridor on Sepulveda Boulevard. This route would serve the most amount of people. However, we believe it should be extended North into Sherman and South through the Sepulveda pass into West L.A.

Respectfully,

The Shluker Family
11739 Addison St
Valley Village, CA 91607

-----Original Message-----

From: Barry Seybert [mailto:barryseybert@usa.net]
Sent: Sunday, December 08, 2002 1:52 AM
To: martinr@mta.net
Subject: Canoga AvenueCorridor

I would like to support the busway project on the adjacent railroad right-of-way between Victory Blvd and the Chatsworth Station. I would furthermore like to see a bikeway along with the busway or allow bicycles to share these lanes with busses.

As the former Co-Chairman of the East West Rail Corridor Study under former Councilwoman Laura Chick (within the CD-3 area), I recommended several years ago that this rail corridor be used. My original plan had a western terminus at the Chatsworth Metrorail station with a leg off to Warner Center. Not the current proposal to Terminus at Warner Center.

I firmly believe that using the rail right-of-way along Canoga will allow an easy connection from Metrolink to Warner Center, Pierce College, and the West Valley Occupation Center. It could also reduce automobile trips daily between the above mentioned locations as well as other locations east along the East West Busway with those arriving from Simi Valley and points west into Ventura County.

Sincerely,

Barry Seybert

member Los Angeles Bicycle Advisory Council
board member West Hills Neighborhood Council

-----Original Message-----

From: vivian alonso pine [mailto:vivian_pine@yahoo.com]
Sent: Sunday, December 08, 2002 8:29 PM
To: martinr@mta.net
Subject: Aesthetics

hi,

I live in Melody Acres, and would like to continue to receive information about AESTHETICS. I would like to be involved in any community input solicited by the MTA.

Thanks,
Vivian Pine

-----Original Message-----

From: Paul Deibel [mailto:PDeibel@ci.san-fernando.ca.us]
Sent: Friday, December 13, 2002 11:05 PM
To: 'martinr@mta.net'
Cc: Jose Pulido; Michael Drake; Edwin Galvez
Subject: Comments on S.F.Valley North-South Transit Corridor Alternatives

To: Roger Martin, MTA Project Manager
From: Paul Deibel, City of San Fernando Community Development Director
Copy: Jose Pulido, City of San Fernando City Administrator; Mike Drake, City
of S.F. Public Works Director; Edwin Galvez, City of S.F. City
Engineer

Subject: Comments on San Fernando Valley North-South Transit Corridor Alternatives

Roger: Thanks for the opportunity to briefly review the remaining five alternative North-South Rapid Bus corridor routes that were on display at the MTA's Community Open House held yesterday evening in San Fernando.

As you know from our prior input, the City of San Fernando strongly supports improving transit links from this community to the region. With respect to the Rapid Bus Corridor Alternatives, the City of San Fernando considers it of critical importance that the residents of this area be served by a corridor connecting to the Sylmar/San Fernando Metrolink Station.

It was good to hear that funding for the project will allow for multiple corridors. As you have heard from members of the San Fernando City Council who have participated in the public comments process, there is demand not only for Rapid Bus access from San Fernando to the south, such as to downtown via the Red Line and to West Los Angeles via the Sepulveda Pass, but also to Valley locations to the west, such as to the CSUN campus in Northridge.

Since it appears that more than a single Rapid Bus corridor is feasible, a combination of corridor alternatives to provide a loop in conjunction with the existing Ventura Avenue Rapid Bus line and the programmed East-West Valley Rapid Bus Transitway would be most advantageous. A combination of the Reseda Boulevard Corridor Alternative and the Lankershim Boulevard Corridor Alternative would provide such a loop covering the greatest area, with the significant advantage of a direct connection to the Metro Red Line.

A combination of the Reseda Boulevard Corridor and either the Sepulveda Corridor or the Van Nuys Corridor would also provide a functional connection to the south with the advantage of linkage to West Los Angeles via the Sepulveda Pass. However, I understand that Rapid Bus service is already programmed for the Van Nuys Boulevard Corridor to begin in only six months or so from now. In light of this, I think that the Reseda-Lankershim Corridors loop in conjunction with the soon to be existing Van Nuys Rapid Bus Corridor would together provide the most beneficial and cost-effective set of transit linkages from this area to the region.

However, with respect to the routing of the Van Nuys Boulevard Corridor, I would take issue with the alignment along Van Nuys northeast of San Fernando Road to Foothill Boulevard and along Foothill and Hubbard Avenue to the Metrolink Station. This "Foothill loop" is on the periphery of prime service area as compared to a more direct route to the Metrolink Station from Van Nuys Boulevard via San Fernando Road through downtown San

Fernando.

While this "Foothill loop" is a little closer to L.A. Mission College and to Olive View-UCLA Medical Center, it is still too far away from either of these destinations to walk conveniently. Specifically, it is a three-quarters of a mile walk from Foothill Boulevard to the corner of Mission College at Hubbard and Eldridge Avenues, and thus perhaps a mile walk to many destinations beyond that on the campus. Likewise, it is over a 1.5 mile walk from the "Foothill loop" to the Olive View Medical Center entrance gate.

A regionally oriented Rapid Bus line would have greater benefit if routed more directly to the regional intermodal transit facility at the Metrolink station, with good feeder bus service or shuttles to destinations such as Mission College and Olive View. The City of San Fernando is currently engaged in preparing a Commercial Corridors Specific Plan. It is anticipated that this plan will promote revitalization of the community's downtown area with more intensive commercial, residential and mixed-use development. Routing the Van Nuys Rapid Bus Corridor through downtown San Fernando would reinforce regional land use and transportation planning objectives to promote such "smart-growth" and transit-oriented development patterns. It would also be more consistent with the MTA's stated objectives for this project to improve connectivity, accessibility, efficiency and aesthetics.

Thanks for the opportunity to make these comments as part of the public participation process for the Major Investment Study on the Rapid Bus Corridor Alternatives. While these are my own brief comments in response to the alternatives on view at the Community Open House yesterday, I think they are consistent with the perspective of City staff and City Council members in general, and I wanted to pass them on today while this phase of the public comments period is still open. However, I would anticipate that the City of San Fernando will be making more formal comments as the MTA's process proceeds. Please call me at (818) 898-1232 with any questions or for further discussion. -Paul Deibel, AICP

fullName: Denise Barnes
Email: ddillon@chla.usc.edu
Subject: Other (please describe)
Other: Suggested route
Date: Friday, February 21, 2003
Time: 11:21 AM

Comments:

I suggest a Rapid Bus route from the north SFValley using a North-South street such as Reseda, Tampa, Winnetka that would connect w/Line 750 and ultimately w/Red line at Universal City. I live near Porter Ranch/western end of Granada Hills and though there are local north-south lines (243 and 239) which are convenient they are too time-consuming to be my regular commuter route. I would then be able to ride MTA for my entire commute instead of driving to North Hollywood subway station. Thank you. Denise Barnes

Fact Sheet/Project Update

Project Update

San Fernando Valley North-South Transit Corridor

November 2002

> Through community input, MTA has narrowed the corridor alternatives for review at upcoming Open Houses. Three service alternatives and five corridor alternatives were identified for final consideration.

Service Alternatives

Baseline/No Project

No change to current and future service plans.

Transportation Systems Management

Low capital cost improvement such as increased bus service on existing routes.

Metro Rapid

Limited stop service with signal priority.

Corridor Alternatives

Canoga Avenue

In the adjacent railroad right-of-way between Victory Boulevard and the Chatsworth Metrolink station.

Lankershim Boulevard

Between the Universal City Metro Red Line station and the Sylmar/San Fernando Metrolink station.

Reseda Boulevard

Between Ventura Boulevard and the Sylmar/San Fernando Metrolink station.

Sepulveda Boulevard

Between Ventura Boulevard and the Sylmar/San Fernando Metrolink station.

Van Nuys Boulevard

Between Ventura Boulevard and the Sylmar/San Fernando Metrolink station.

> To hear more about the route alternatives for the San Fernando Valley transit corridor and provide feedback, mark your calendar for one of the following Community Open Houses:

Tuesday, December 10 Sherman Oaks

Sherman Oaks Women's Club
4808 Kester Avenue
5 to 8pm

Wednesday, December 11 Woodland Hills

Pierce College, Campus Center
6201 Winnetka Avenue
5 to 8pm

Thursday, December 12 San Fernando

City of San Fernando Recreation Park, Multipurpose Room
208 Park Avenue
5 to 8pm



Project History

> In May 2002, the Los Angeles County MTA began work on the San Fernando Valley Transit Corridor Study. The primary purpose of this study is to identify one or more preferred north-south bus corridor(s). In order to meet state funding requirements, the corridor(s) must connect with the existing Ventura Boulevard Metro Rapid Line and the San Fernando Valley East-West Metro Rapid Transitway that will begin operation in 2005.

The study examines how to provide complementary north-south bus improvements that will create a system of higher-capacity transit corridors in the San Fernando Valley. It began with a nine-month Major Investment Study to identify and examine a wide range of north-south streets that best connect with both Metro Rapid services. After the study has narrowed the alternatives to project recommendations, the MTA Board may authorize preparation of an Environmental Impact Statement and Report to assess the project's benefits and impacts.

> Project recommendations can benefit you and others by providing improved:

Connectivity

Faster and better connections to other transit routes and regional services including Metro Rail and Metrolink

Accessibility

Faster travel times and better connections to destinations within the San Fernando Valley and improved access to downtown Los Angeles, the Westside and destinations throughout the Los Angeles Basin.

Efficiency

Simplified routes with fewer stops and higher capacity vehicles with on-board advanced technology that allows the vehicles to travel faster and reduce waiting time at stops.

Aesthetics

Landscape and urban design features designed to complement the transit features and connect the system to the surrounding communities.

> If you would like to receive more information regarding the study, notifications about public meetings to be held in your community or to schedule a briefing for your organization, call 418.701.2855 or email marlinr@mta.net. We look forward to hearing from you and appreciate your continued interest in this project.

Information about all MTA projects is available at www.mta.net.

Actualización del proyecto

Corredor de tránsito entre norte-sur del Valle de San Fernando

Noviembre del 2002

> Basada en las opiniones de la comunidad, MTA ha reducido las alternativas del corredor de tránsito para que sean revisadas en las próximas reuniones. Para su consideración final, se identificaron tres alternativas de servicio y cinco alternativas para el corredor.

Alternativas para el servicio

Línea de fondo/Sin proyecto
Sin cambio en los planes de servicio actuales y del futuro.

Administración de sistemas de transporte
Bajo costo de capital y mejoras que incluyen incremento en el servicio de autobús en las rutas ya existentes.

Metro Rapid
Servicio de paradas limitadas y con prioridad en las señales de tránsito.

Alternativas para el corredor

Canoga Avenue
En el derecho de vía de tren adyacente, entre Victory Boulevard y la estación de Metrolink en Chatsworth.

Tottenham Boulevard
Entre la estación Universal City de Metro Red Line y la estación Sylmar/San Fernando de Metrolink.

Reseda Boulevard
Entre Ventura Boulevard y la estación Sylmar/San Fernando de Metrolink.

Sepulveda Boulevard
Entre Ventura Boulevard y la estación Sylmar/San Fernando de Metrolink.

Van Nuys Boulevard
Entre Ventura Boulevard y la estación Sylmar/San Fernando de Metrolink.

> Para saber más acerca de las alternativas de rutas para el corredor de tránsito del Valle de San Fernando y expresar sus comentarios, marque en su calendario una de las siguientes reuniones comunitarias:

Martes 10 de diciembre de 2002
Sherman Oaks
Sherman Oaks Women's Club
4808 Kester Avenue
5 a 8 pm

Miércoles 11 de diciembre de 2002
Woodland Hills
Pierce College, Campus Center
6201 Winnetka Avenue
5 a 8 pm

Jueves 12 de diciembre de 2002
San Fernando
City of San Fernando Recreation Park,
Multipurpose Room
208 Park Avenue
5 a 8 pm

Historia del proyecto

> En mayo de 2002, MTA del condado de Los Angeles comenzó a trabajar en el Estudio para el Corredor de Tránsito de San Fernando Valley. El propósito primordial de este estudio era identificar uno o más corredores de autobús preferidos para la ruta entre el norte y sur. Para cumplir con los requerimientos estatales para el financiamiento, los corredores deben conectarse con la línea ya existente de Metro Rapid de Ventura Boulevard y con la ruta fija de Metro Rapid que va de este a oeste en el Valle de San Fernando, y que entrará en operación en 2005.

El estudio examina cómo ofrecer mejoras complementarias a la ruta norte-sur de autobús que permitan crear un sistema de corredores de tránsito de más alta capacidad en el Valle de San Fernando. Empezó con un Estudio de Inversión Mayor de nueve meses para identificar y examinar una gama extensa de calles de norte a sur que ofrecieran la mejor conexión de ambos servicios de Metro Rapid. Una vez que el estudio haya reducido las alternativas a recomendaciones del proyecto, la Junta Directiva de MTA puede autorizar la Preparación de una Declaración y Reporte de Impacto Ambiental para evaluar los beneficios e impactos del proyecto.

> Las recomendaciones del proyecto pueden beneficiarlo a usted y a otras personas ofreciendo las siguientes mejoras:

Conectividad

Conexiones más rápidas y mejores hacia otras rutas de tránsito y servicios regionales, incluyendo Metro Rail y Metrolink.

Accesibilidad

Conexiones más rápidas y mejores a destinos dentro del valle de San Fernando y mejor acceso al centro de Los Angeles, el oeste y destinos por todas de Los Angeles.

Eficiencia

Rutas simplificadas con menos paradas y vehículos con mayor capacidad y equipados con tecnología avanzada que permite que viajen más rápido y reduzcan su tiempo de espera en las paradas.


Estética

Jardines y elementos de diseño urbano creados para complementar los elementos de transporte y conectar el sistema con las comunidades cercanas.



> Si usted desea recibir más información sobre este estudio, notificaciones acerca de las reuniones públicas que se llevarán a cabo en su comunidad o programar una junta para su organización, llame al 818-701-2855 o envíe un correo electrónico a martinr@mta.net. Esperamos tener noticias de usted y apreciamos su continuo interés en este proyecto.

Información de todos los proyectos de MTA está disponible en www.mta.net.

San Fernando Valley North-South Transit Corridor Major Investment Study

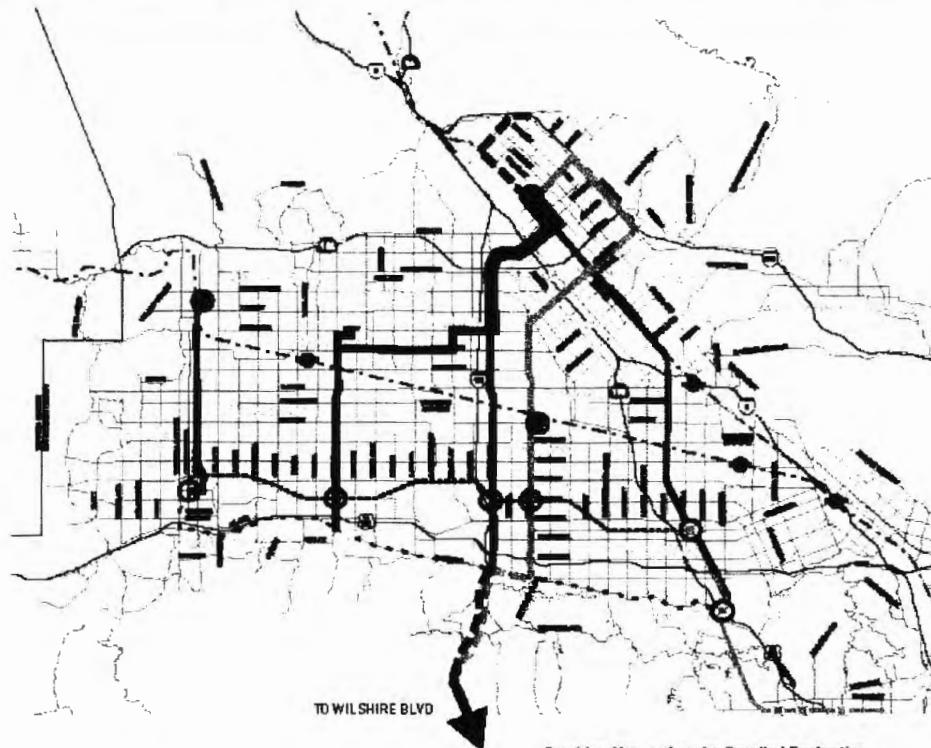

Corridor Alternatives for Detailed Evaluation

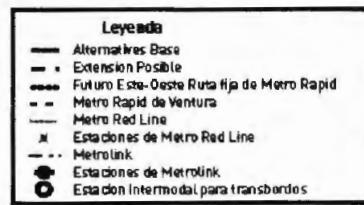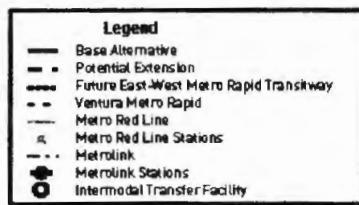

MTA is Working on Transit Solutions for the San Fernando Valley

MTA está estudiando soluciones de tránsito para el valle de San Fernando

> MTA is responsible for overseeing and improving all forms of transportation in Los Angeles County. Anyone who drives, uses public transit, bicycles or walks on any street or freeway in the county is an MTA customer.

MTA plans and operates its own bus and rail service and provides funding and coordination for 12 municipal transit operators. In addition, MTA works to combat traffic congestion by helping to plan and fund freeway and carpool lanes, soundwalls, street widening projects and traffic signal enhancements. MTA also oversees the Metro Freeway Service Patrol which helps stranded motorists.

> This is an update on one of the MTA projects coming to your area.

> MTA es responsable de supervisar y mejorar todas las formas de transporte en el condado de Los Angeles. Cualquier persona que maneje, use transporte público, su bicicleta o los caminos de cualquier calle o autopista en el condado es un cliente de MTA.

MTA planifica y opera sus propios servicios de autobús y trenes y ofrece financiamiento y coordinación para 12 operadores municipales de tránsito. Además, MTA trabaja para combatir la congestión del tráfico ayudando a planificar y a financiar carriles de viajes compartidos en las autopistas, así como barreras contra el sonido, proyectos de ampliación de calles y mejoras en las señales de tráfico. MTA también supervisa el Metro Freeway Service Patrol (Servicio de Patrullas del Metro en las Autopistas) que ayuda a los conductores varados.

> Esta es una actualización de uno de los proyectos de MTA que serán implementados en su área.



Metropolitan Transportation Authority
One Gateway Plaza
Los Angeles, CA 90012



“Take One” Notices & Advertisements

Come to a Community Meeting

San Fernando Valley North-South Corridor Study

> MTA invites you to provide input into the route alternatives for the San Fernando Valley north-south transit corridor. Eight alternatives will be on display for your review and comment.

Tuesday, December 10

Sherman Oaks

Sherman Oaks Women's Club

4808 Kester Avenue

5 to 8 pm

Wednesday, December 11

Woodland Hills

Pierce College, Campus Center

6201 Winnetka Avenue

5 to 8 pm

Thursday, December 12

San Fernando

City of San Fernando

Recreation Park

Multipurpose Room

208 Park Avenue

5 to 8 pm

For more information:

818.701.2855 or

www.mta.net



For more information about the San Fernando Valley North-South Corridor Study, contact the MTA at 818.701.2855 or visit www.mta.net.
This meeting is part of the MTA's public outreach process.
For more information about the MTA, visit www.mta.org.

Venga a una junta de la comunidad

Estudio del Corredor Entre el Norte y Sur del Valle de

> MTA lo invita expresar su pensamientos acerca de las alternativas para la ruta fija entre el norte y sur en San Fernando Valley de Metro Rapid. Se presentarán ocho opciones para que usted pueda revisarlas y hacer comentarios.

Martes 10 de diciembre

Sherman Oaks

Sherman Oaks Women's Club

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5 a 8 pm

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Multipurpose Room

208 Park Avenue

5 a 8 pm

Para más información:

818.701.2855 o

www.mta.net

Para más información sobre el Estudio del Corredor Entre el Norte y Sur del Valle de, contacte al MTA al 818.701.2855 o visite www.mta.net.
Este es parte del proceso de consulta pública del MTA.
Para más información sobre el MTA, visite www.mta.org.

MTA Wants to Hear From You!

San Fernando Valley North-South Corridor Study

> MTA invites you to provide input into the route alternatives for the San Fernando Valley north-south transit corridor. Eight alternatives will be on display for your review and comment.

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Recreation Park
Multipurpose Room
208 Park Avenue
5 to 8 pm

For more information:
818.701.2855 or
www.mta.net



If you are not able to attend but would like to comment, write to martinr@mta.net or MTA, SFV North-South MIS Study 99-22-9, One Gateway Plaza, Los Angeles, CA 90012.

Comments must be received by December 20, 2002 to be considered.

NSV120902

Press Release



December 4, 2002

CONTACT:

Rick Jager/Marc Litman
MTA MEDIA RELATIONS
(213) 922-3707/922-2700
www.mta.ca.gov/relationspress.com
e-mail: mediarelations@mta.ca

FOR IMMEDIATE RELEASE

MTA Moves Closer to Selection of North-South Bus Transit Corridor in San Fernando Valley, Narrows Candidate List to Five

Following a series of community meetings and analysis, an MTA project team has narrowed the list of alternatives for a north-south high capacity bus transit corridor in the San Fernando Valley from 13 to five. The ongoing San Fernando Valley North-South Transit Corridor Study, which will be completed in early 2003, will result in the recommendation of a corridor(s) that would connect the north San Fernando Valley with both the San Fernando Valley East-West Metro Rapid Transitway and with Metro Rapid bus service on Ventura Boulevard.

The five potential north-south corridors that remain under study include (in alphabetical order): the rail right-of-way adjacent to Canoga Avenue, Lankershim Boulevard, Reseda Boulevard, Sepulveda Boulevard, and Van Nuys Boulevard.

"High capacity north-south bus service will be a vital piece of the transportation system in the San Fernando Valley," said Jim de la Loza, MTA executive officer for countywide planning. "Metro Rapid service on Ventura Boulevard is hugely successful and we expect the east-west Metro Rapid transitway to draw large numbers of passengers, as well. A north-south corridor will be the right complement for these two lines."

In addition to public input, the study is factoring in employment density, population density, areas of high transit usage, land use condition and population under 15 and over 64.

To improve bus speeds at congestion points, the corridor may include dedicated bus lanes, either all day or during peak hours only. This may also include service beyond the limits of the corridor, such as enhanced transit service over the Sepulveda Pass to Wilshire Boulevard.

The recommended project also may incorporate the following list of potential enhancements: enhanced bus stops with canopies, lighting, ticket machines, maps, "next trip" displays, transit signal priority, park and ride facilities, landscaping, and pedestrian and bike access improvements.

Upon approval of a project by the MTA Board in early 2003, funding for implementation would include \$100 million earmarked in Governor Gray Davis' Transportation Congestion Relief Program, approved by the state legislature two years ago, supplemented by local sales tax dollars.

In addition to meeting with the community stakeholders on an ongoing basis, the study's project team will conduct another series of open houses in December at the following times and locations:

- **Tuesday, December 10, 2002, 5 p.m. – 8 p.m.**
Sherman Oaks Women's Club
4809 Kester Avenue
Sherman Oaks
- **Wednesday, December 11, 2002, 5 p.m. – 8 p.m.**
Pierce College Campus Center
6201 Winnetka Avenue
Woodland Hills
- **Thursday, December 12, 2002, 5 p.m. – 8 p.m.**
Recreation Park
200 Park Avenue
City of San Fernando

Additional information on the San Fernando Valley North-South Transit Corridor Study and on upcoming meetings can be obtained by calling the study's information line at (818)701-2955 or by visiting MTA's website at www.mta.net and clicking on "Programs and Projects."

Anyone who is unable to attend any of the public meetings and wishes to comment can send an e-mail to martin@mta.net or submit their comments by mail to:

- **Countywide Planning & Development**
M/S 99-22-9
Attention: SFV North/South MIS Study
One Gateway Plaza
Los Angeles, CA 90012-2952

Newspaper Articles

Los Angeles Daily News

Bus way options narrowed

North-south choices cut from 13 to 5

By Lisa Mascaro
Staff Writer

Wednesday, December 04, 2002 - The Metropolitan Transportation Authority has narrowed the choices for a north-south high-capacity bus way through the San Fernando Valley from 13 to five, following a series of public meetings with local residents, officials said.

The MTA will focus on five routes -- Reseda, Sepulveda, Van Nuys and Lankershim boulevards and Canoga Avenue -- as it moves ahead with plans for the \$100 million bus way.

As a requirement for receiving state money, the north-south system must hook up with the East-West Busway, whose construction will begin next year, as well as the Metro Rapid bus service now on Ventura Boulevard.

"High-capacity north-south bus service will be a vital piece of the transportation system in the San Fernando Valley," Jim de la Loza, MTA's executive officer for countywide planning, said in a printed statement. "A north-south corridor will be the right complement for these two lines."

When the MTA narrowed options from 13 to five for a north-south route, among the corridors eliminated from consideration were Topanga Canyon Boulevard, Vineland Avenue-San Fernando Road, and bus service from Sylmar and San Fernando to Westwood via the San Diego Freeway.

The bus way would have its own dedicated lane in some areas -- as the East-West Busway will have between North Hollywood and Warner Center -- so it won't have to fight traffic. The bus stops would likely have ticket machines, terminal displays showing when the next bus arrives, lighting, canopies and other amenities.

While already crowded East Valley bus routes -- along Van Nuys and Lankershim boulevards -- had initially won interest for the possible new system, officials have since said they would consider building up to three north-south routes to connect with the east-west line.


The Canoga Avenue corridor emerged as a popular idea supported by MTA board Chairman Hal Bernson because the agency already owns the old rail right of way and the new line could run between Warner Center and the Chatsworth Metrolink station.

North Valley transit users have been pushing the MTA to include Sylmar as a northern end, rather than having the line stop at the Sylmar-San Fernando Metrolink station as was first planned.

The study team hopes to present the final options to the MTA board early next year. Among factors the team is considering are public input, employment and population density, as well as which areas have high transit usage.

<http://www.dailyn.com/cda/article/print/0,1674,200%7E20954%7E1030089,00.html>

12/12/2002

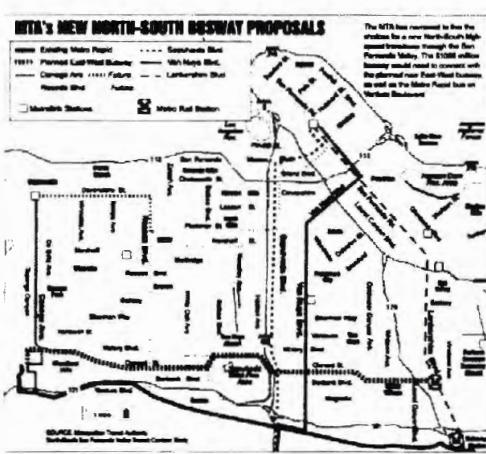


http://media.mnginteractive.com/media/paper200/120502_busways.jpg

Appendix B

Plan Sheets of Alternatives



**San Fernando Valley
North-South Transit Corridor
Regionally Significant Transportation Investment Study**

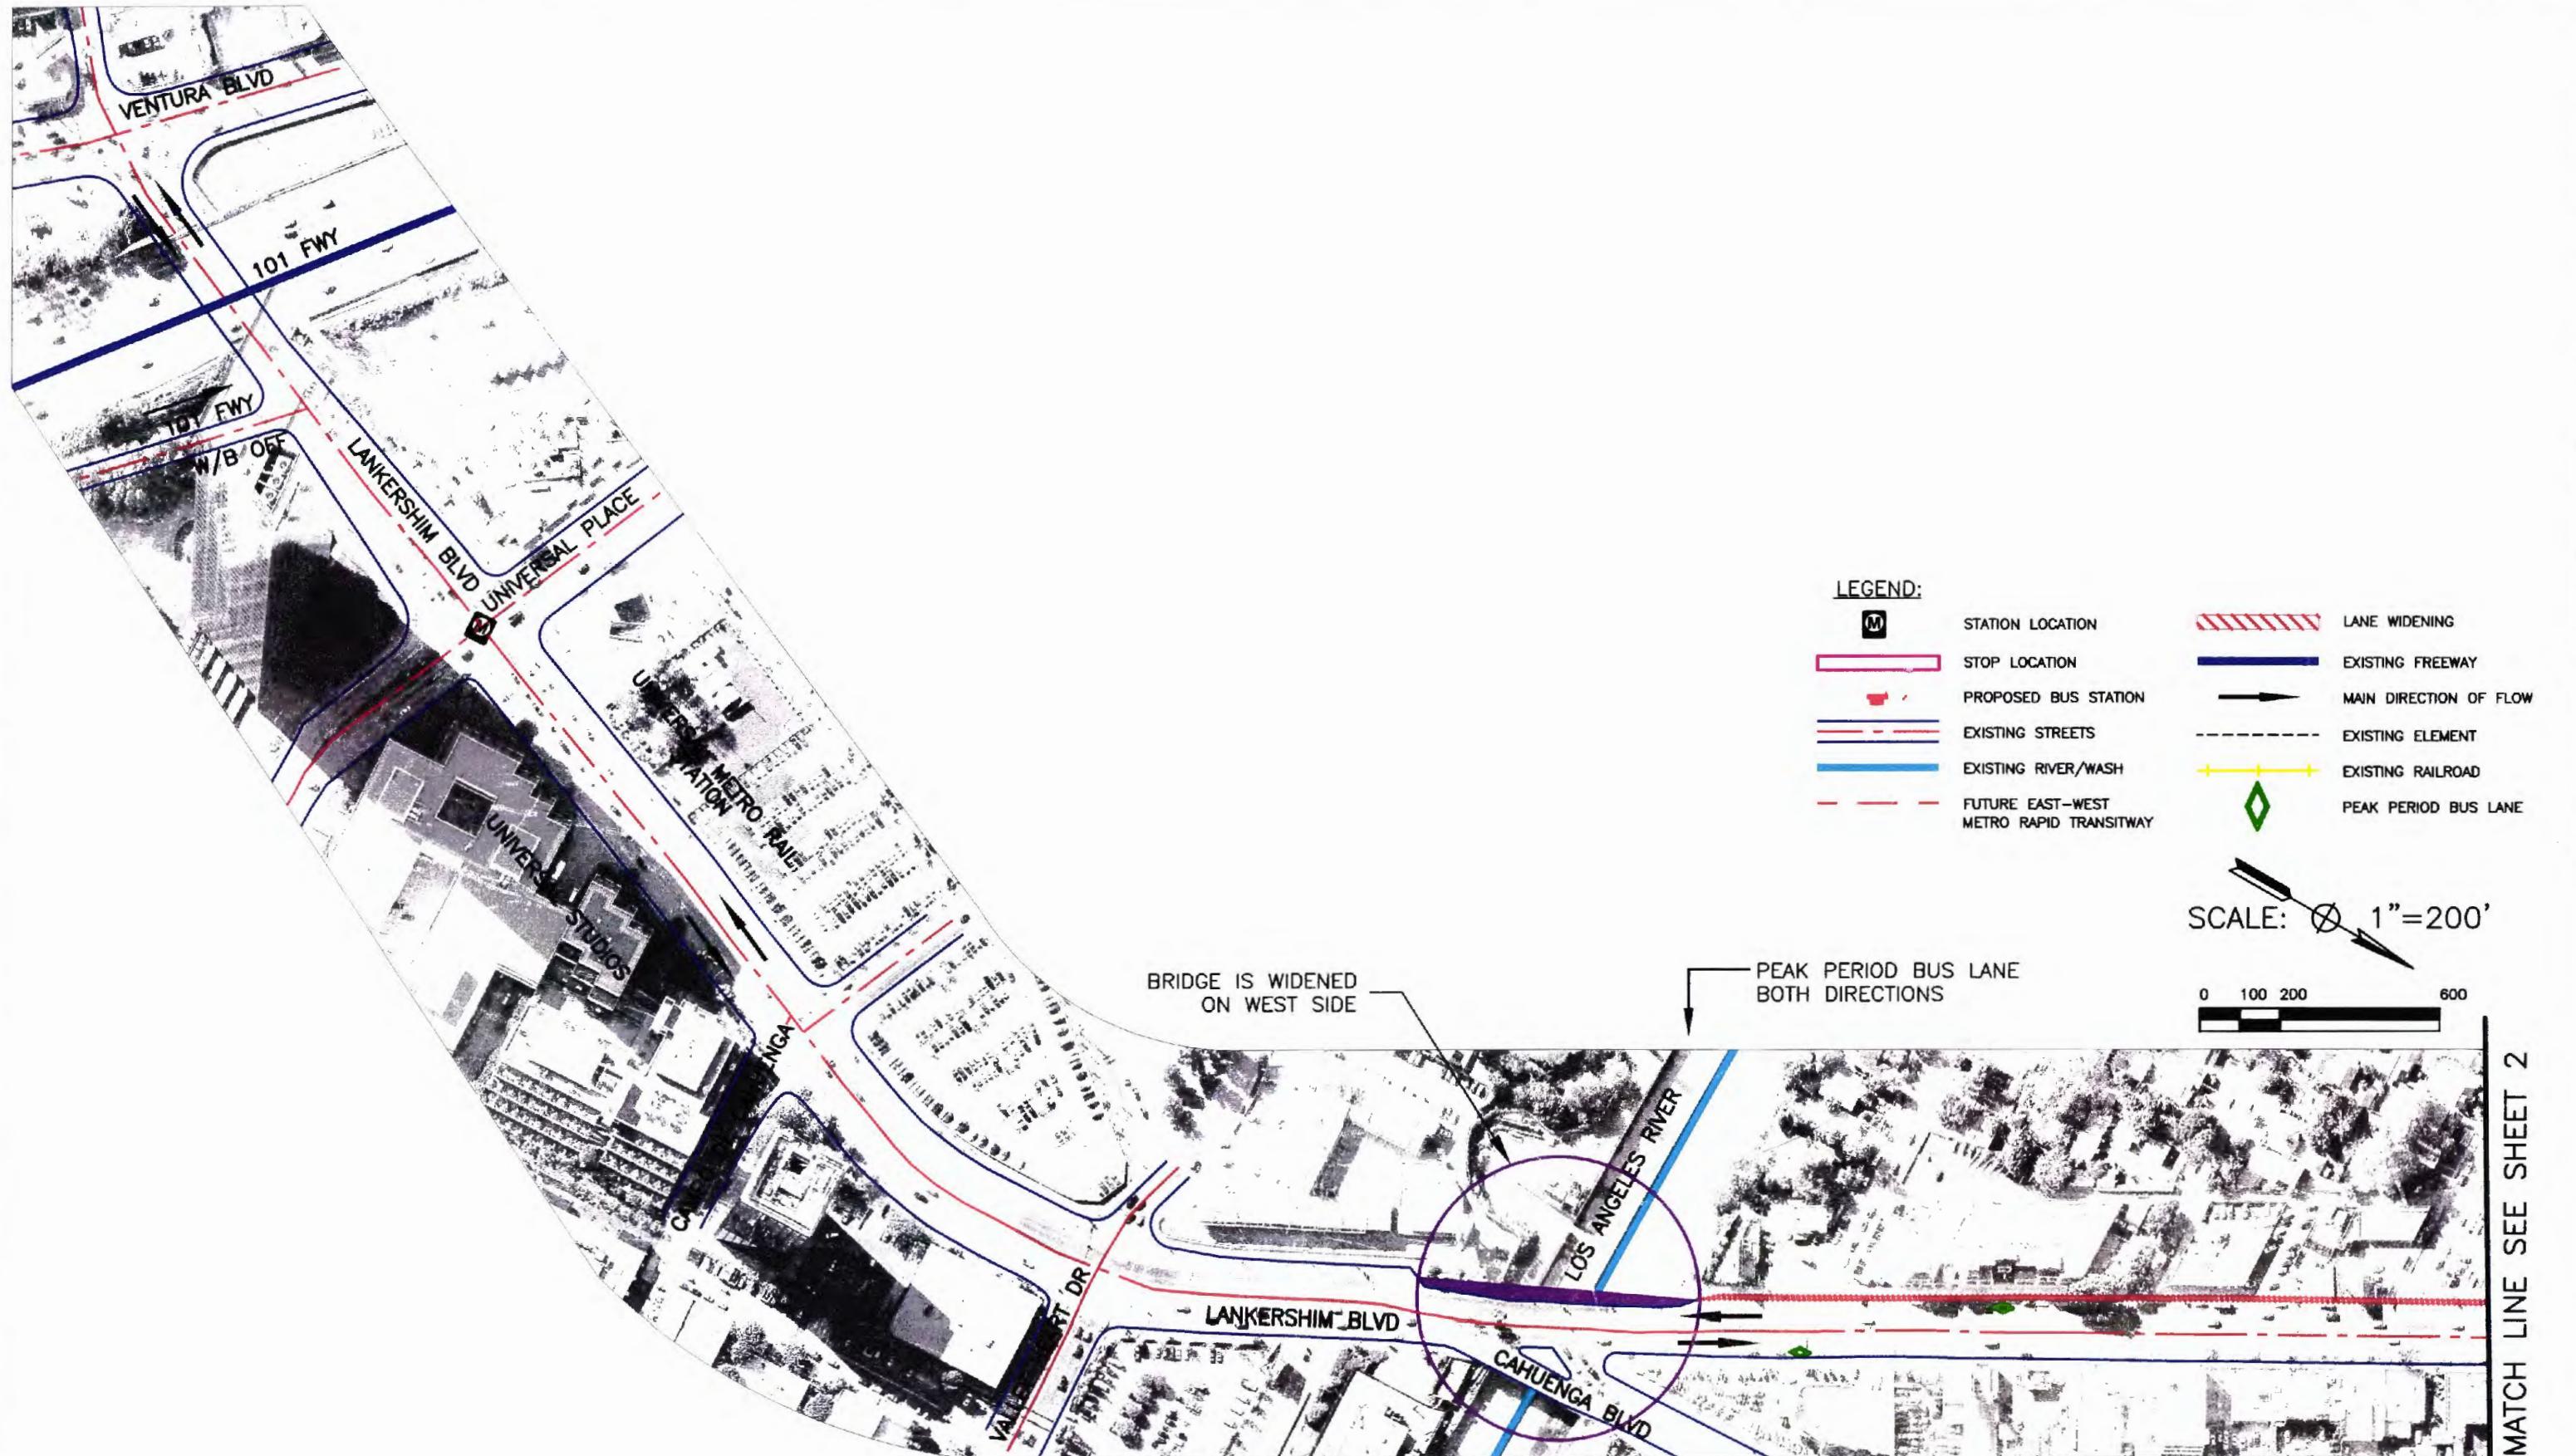

NOT FOR CONSTRUCTION

										DESIGNED BY JAF	DRAWN BY JAF	CHECKED BY MT.	IN CHARGE RRH	CONTRACT NO PS4350-1018			
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										SCALE 1"=200'							
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										LANKERSHIM BLVD CORRIDOR VENTURA BLVD TO SAN FERNANDO RD							
LOS ANGELES COUNTY METROPOLITAN TRANSPORTATION AUTHORITY SAN FERNANDO VALLEY NORTH-SOUTH TRANSITWAY CORRIDOR M.I.S. MEYER, MOHADDES ASSOCIATES, INC 707 WILSHIRE BLVD., SUITE 4810 LOS ANGELES, CA 90017										H K A Hernandez, Kroone & Associates, Inc. CONSULTING ENGINEERS — PLANNING — DESIGN — SURVEYING 234 DRAKE DRIVE SAN BERNARDINO, CA 92406 (909) 884-3222 FAX (909) 383-1577							

MATCH LINE SEE SHEET 1

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MATCH LINE SEE BELOW LEFT

MATCH LINE SEE SHEET 3



SCALE: 1" = 200'




SCALE: 1"=200'

LEGEND:

- This legend identifies various map symbols used in the study area:

 - M**: Station Location
 - Stop Location**
 - Proposed Bus Station**
 - Existing Streets**
 - Existing River/Wash**
 - Future East-West Metro Rapid Transitway**
 - Lane Widening**
 - Existing Freeway**
 - Main Direction of Flow**
 - Existing Element**
 - Existing Railroad**
 - Peak Period Bus Lane**

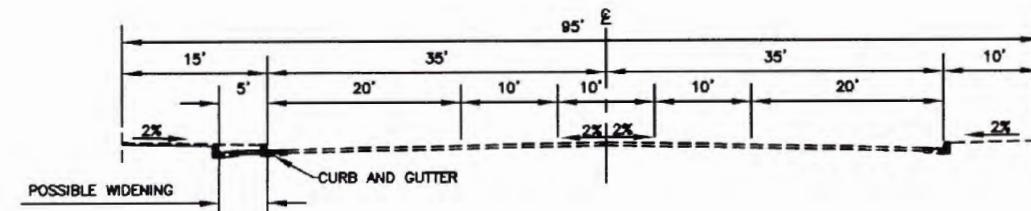

CROSS SECTION A-A

A horizontal scale bar with numerical markings at 0, 100, 200, and 600.


NOT FOR CONSTRUCTION

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0	1/03						SOLICITATION LEVEL	DATE 1/03
REV	DATE	BY	APP	REQ NO	EXPIRES	SEAL HOLDER	DESCRIPTION	



LOS ANGELES COUNTY METROPOLITAN TRANSPORTATION AUTHORITY
SAN FERNANDO VALLEY NORTH-SOUTH TRANSITWAY CORRIDOR M.I.S.

YER, MOHADDES ASSOCIATES, P.
WILSHIRE BLVD., SUITE 4810
ANGELES, CA 90017

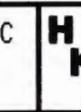


Hernandez, Kroone
& Associates, Inc.
— CONSULTING ENGINEERS —
PLANNING - DESIGN - SURVEYING
234 DRAKE DRIVE
SAN BERNARDINO, CA 92408
(909) 884-3222 FAX (909) 383-1577

LANKERSHIM BLVD CORRIDOR
VENTURA BLVD TO SAN FERNANDO RD

CONSTRUCTION
TRACT NO
PS4350-1018
MING NO REV
0
LE
1"-=200'
ET NO
2 OF 12

MATCH LINE SEE SHEET 2

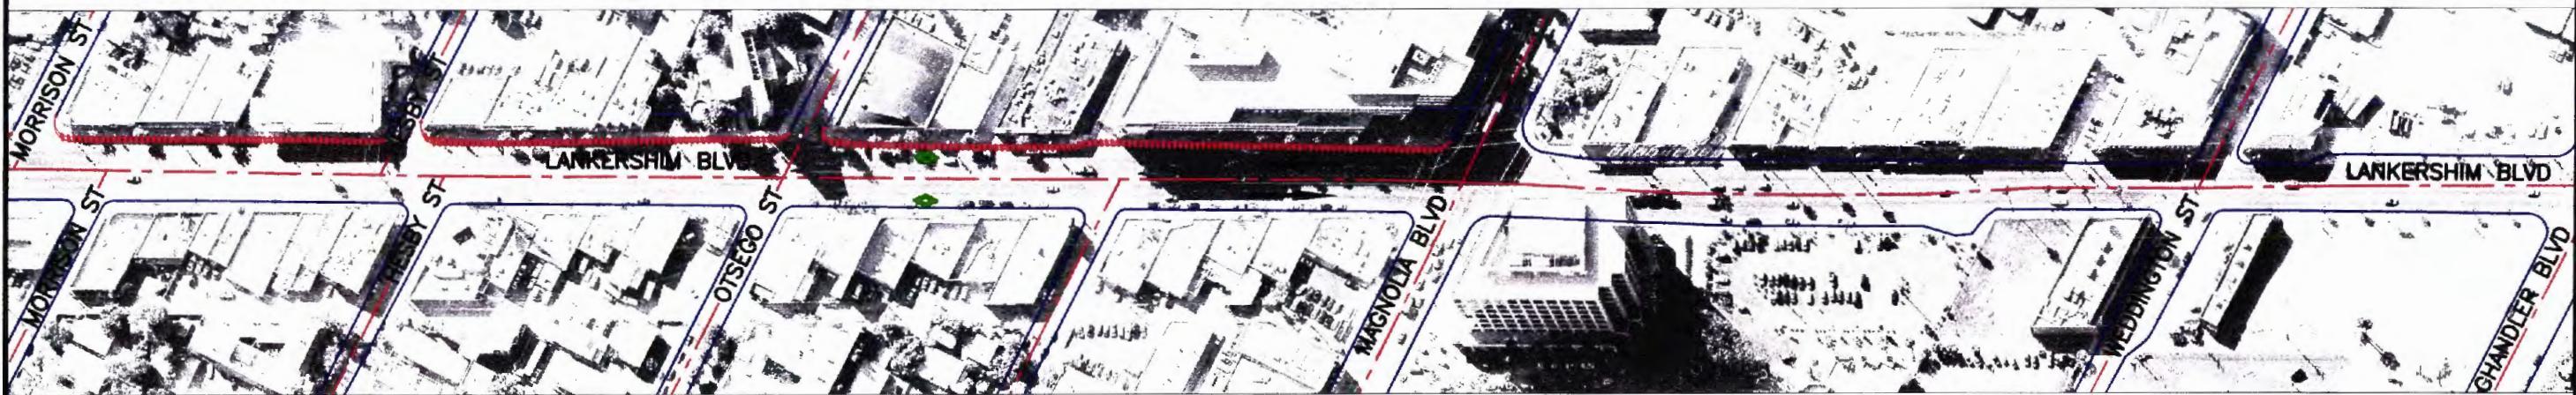

MATCH LINE SEE BELOW LEFT

PORTAL ON
WEST SIDE

FUTURE EAST-WEST METRO RAPID TRANSITWAY

SCALE: 1"=200'

MATCH LINE SEE ABOVE RIGHT



MATCH LINE SEE SHEET 4

LEGEND:

	STATION LOCATION		LANE WIDENING
	STOP LOCATION		EXISTING FREEWAY
	PROPOSED BUS STATION		MAIN DIRECTION OF FLOW
	EXISTING STREETS		EXISTING ELEMENT
	EXISTING RIVER/WASH		EXISTING RAILROAD
	FUTURE EAST-WEST METRO RAPID TRANSITWAY		PEAK PERIOD BUS LANE

0 100 200 600

NOT FOR CONSTRUCTION

0	1/03											
REV	DATE	BY	APP	REG NO	EXPIRES	SEAL HOLDER	SOLICITATION LEVEL					

DESIGNED BY JAF	
DRAWN BY JAF	
CHECKED BY MT.	
IN CHARGE RRH	
DATE 1/03	


LOS ANGELES COUNTY METROPOLITAN TRANSPORTATION AUTHORITY
SAN FERNANDO VALLEY NORTH-SOUTH TRANSITWAY CORRIDOR M.I.S.
MEYER, MOHADDES ASSOCIATES, INC. 707 WILSHIRE BLVD., SUITE 4810
707 WILSHIRE BLVD., SUITE 4810
LOS ANGELES, CA 90017

HKA CONSULTING ENGINEERS — PLANNING — DESIGN — SURVEYING
234 DRAKE DRIVE SAN BERNARDINO, CA 92408
(909) 864-3222 FAX (909) 363-1577

LANKERSHIM BLVD CORRIDOR
VENTURA BLVD TO SAN FERNANDO RD

CONTRACT NO
PS4350-1018
DRAWING NO
REV
0
SCALE
1"-200'
SHEET NO
3 OF 12

MATCH LINE SEE SHEET 3

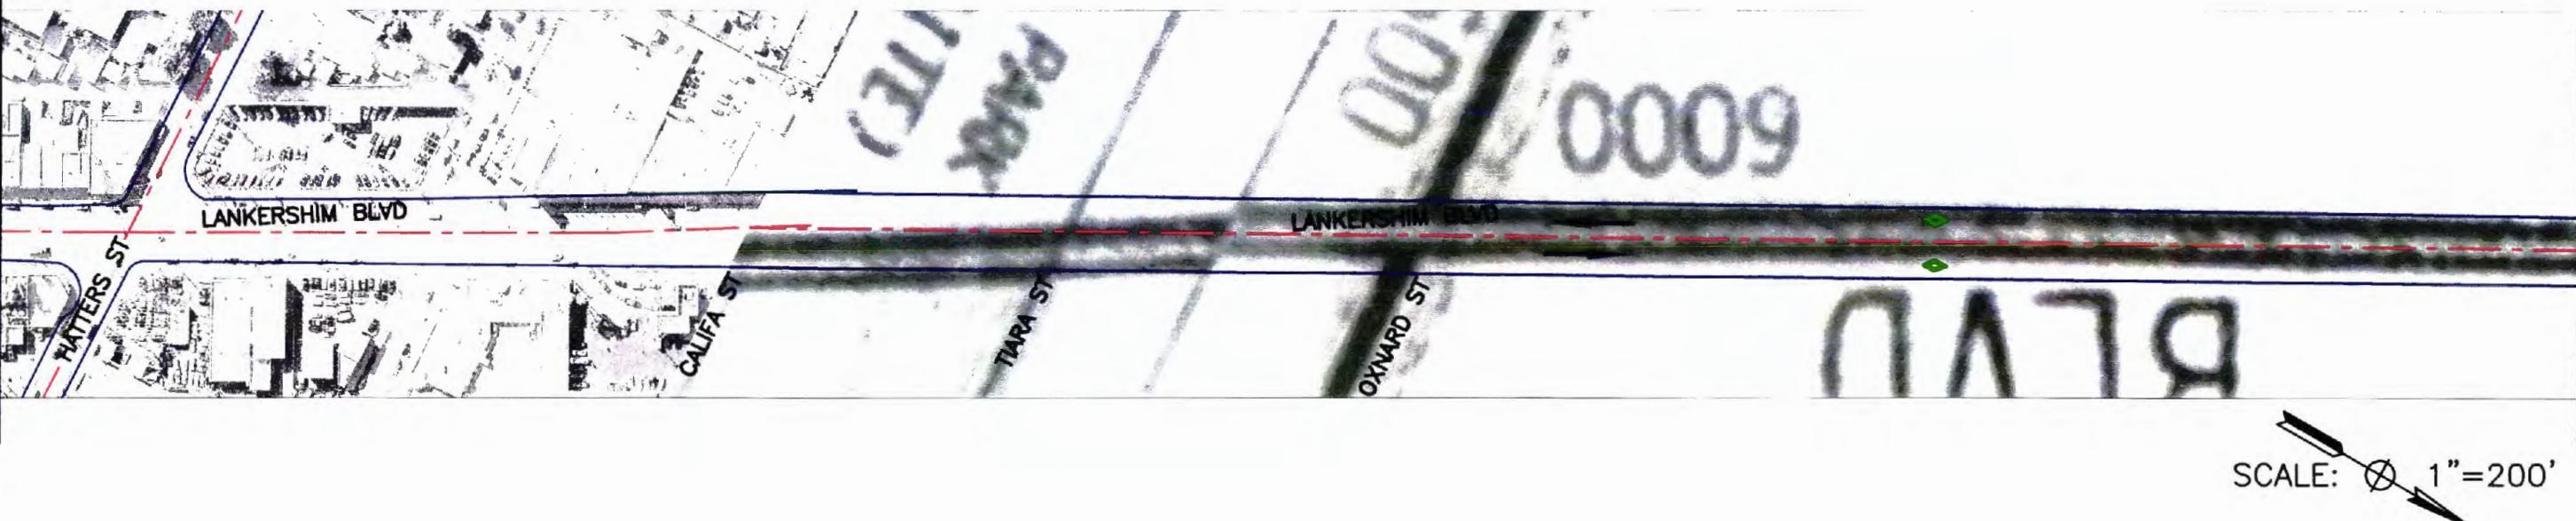

MATCH LINE SEE BELOW LEFT

MATCH LINE SEE ABOVE RIGHT



MATCH LINE SEE SHEET 5

LEGEND:

	STATION LOCATION		LANE WIDENING
	STOP LOCATION		EXISTING FREEWAY
	PROPOSED BUS STATION		MAIN DIRECTION OF FLOW
	EXISTING STREETS		EXISTING ELEMENT
	EXISTING RIVER/WASH		EXISTING RAILROAD
	FUTURE EAST-WEST METRO RAPID TRANSITWAY		PEAK PERIOD BUS LANE

SCALE: 1"=200'

0 100 200 600

NOT FOR CONSTRUCTION

0	1/03												
REV	DATE	BY	APP	REG NO	EXPIRES	SEAL HOLDER	SOLICITATION LEVEL						

DESIGNED BY JAF	DRAWN BY JAF
CHECKED BY MT.	IN CHARGE RRH
DATE 1/03	



LOS ANGELES COUNTY METROPOLITAN TRANSPORTATION AUTHORITY
SAN FERNANDO VALLEY NORTH-SOUTH TRANSITWAY CORRIDOR M.I.S.


MEYER, MOHADDES ASSOCIATES, INC.
707 WILSHIRE BLVD., SUITE 4810
LOS ANGELES, CA 90017

HKA
Hernandez, Kroone
& Associates, Inc.
CONSULTING ENGINEERS
PLANNING - DESIGN - SURVEYING
234 DRAKE DRIVE
SAN BERNARDINO, CA 92408
(909) 884-3222 FAX (909) 383-1577

LANKERSHIM BLVD CORRIDOR
VENTURA BLVD TO SAN FERNANDO RD

CONTRACT NO PS4350-1018	DRAWING NO	REV 0
SCALE 1"=200'		
SHEET NO 4 OF 12		

MATCH LINE SEE SHEET 4

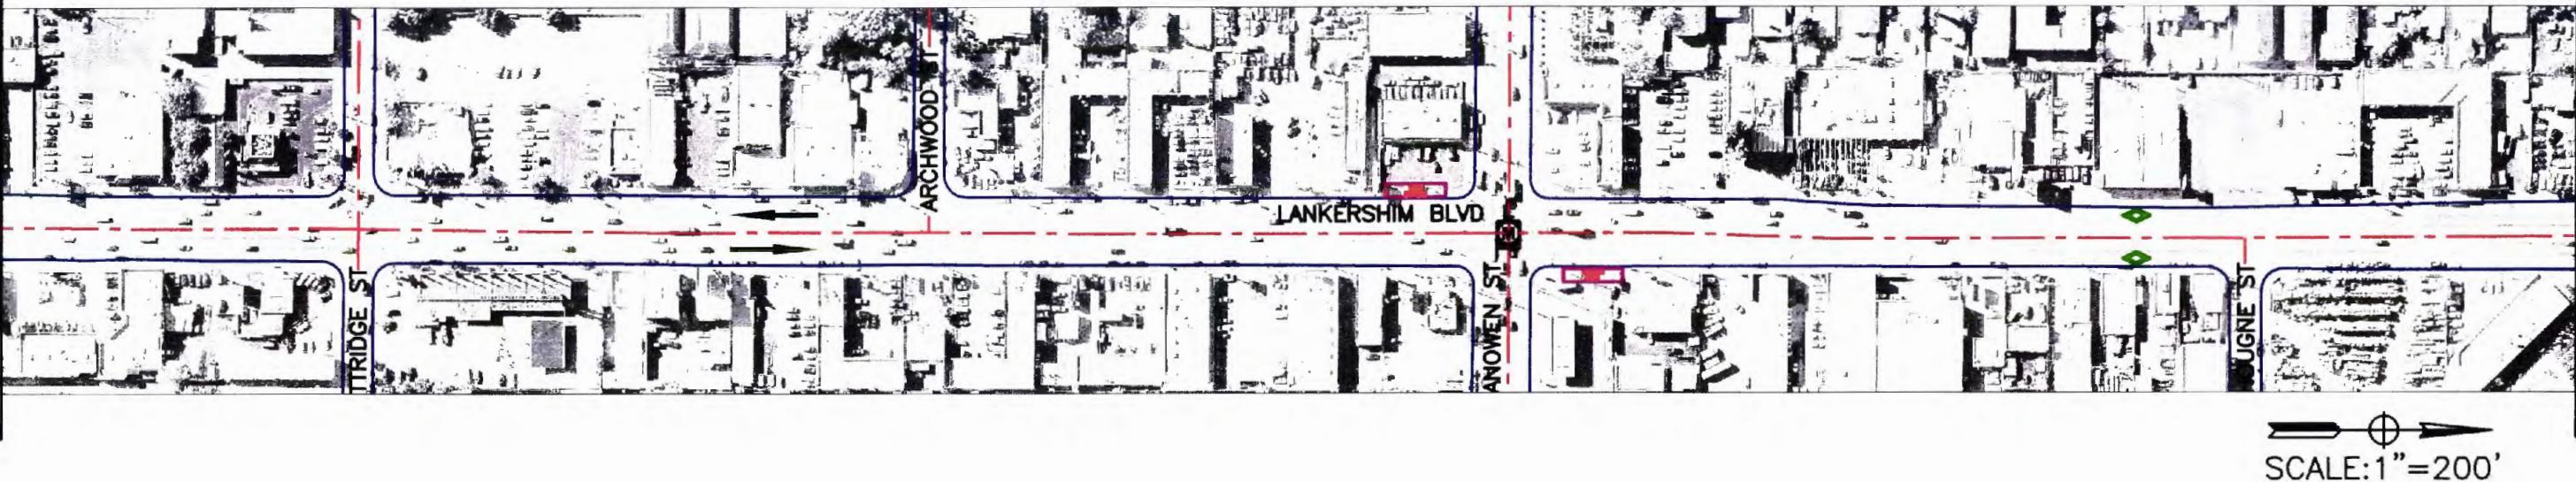

MATCH LINE SEE ABOVE RIGHT



LEGEND:

- | | | | |
|--|-----------------------------------------|--|------------------------|
| | STATION LOCATION | | LANE WIDENING |
| | STOP LOCATION | | EXISTING FREEWAY |
| | PROPOSED BUS STATION | | MAIN DIRECTION OF FLOW |
| | EXISTING STREETS | | EXISTING ELEMENT |
| | EXISTING RIVER/WASH | | EXISTING RAILROAD |
| | FUTURE EAST-WEST METRO RAPID TRANSITWAY | | PEAK PERIOD BUS LANE |

0 100 200 600

NOT FOR CONSTRUCTION

REV	DATE	BY	APP	REG NO.	EXPIRES	SEAL HOLDER	SOLICITATION LEVEL	DESIGNED BY	DRAWN BY	CHECKED BY	IN CHARGE	DATE
								JAF	JAF	MT.	RRH	1/03
0	1/03											
REV	DATE	BY	APP	REG NO.	EXPIRES	SEAL HOLDER	SOLICITATION LEVEL	DESCRIPTION	DATE	REV	SCALE	5 OF 12

0 100 200 600

0 100 200 600

0 100 200 600

DESIGNED BY JAF
DRAWN BY JAF
CHECKED BY MT.
IN CHARGE RRH
DATE 1/03

MEYER, MOHADDES ASSOCIATES, INC
707 WILSHIRE BLVD., SUITE 4810
LOS ANGELES, CA 90017

L LOS ANGELES COUNTY METROPOLITAN TRANSPORTATION AUTHORITY
SAN FERNANDO VALLEY NORTH-SOUTH TRANSITWAY CORRIDOR M.I.S.

H K A Hernandez, Kroone & Associates, Inc.
CONSULTING ENGINEERS —
PLANNING - DESIGN - SURVEYING
234 DRAKE DRIVE
SAN BERNARDINO, CA 92408
(909) 884-3222 FAX (909) 383-1577


LANKERSHIM BLVD CORRIDOR
VENTURA BLVD TO SAN FERNANDO RD

CONTRACT NO
PS4350-1018
DRAWING NO
REV
0
SCALE
1"=200'
SHEET NO
5 OF 12

MATCH LINE SEE SHEET 5



MATCH LINE SEE ABOVE RIGHT

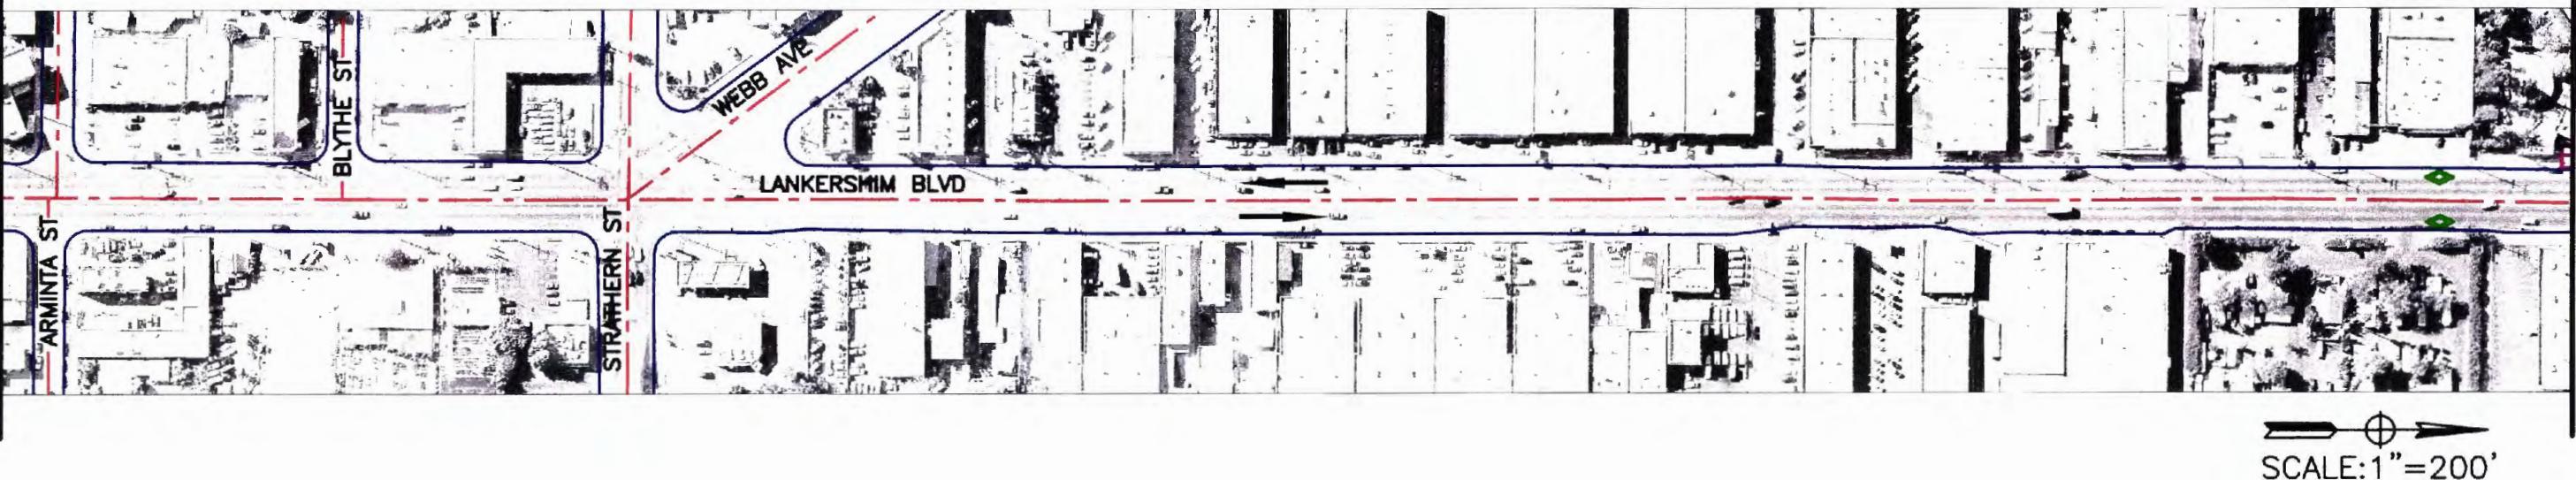

LEGEND:

	STATION LOCATION		LANE WIDENING
	STOP LOCATION		EXISTING FREEWAY
	PROPOSED BUS STATION		MAIN DIRECTION OF FLOW
	EXISTING STREETS		EXISTING ELEMENT
	EXISTING RIVER/WASH		EXISTING RAILROAD
	FUTURE EAST-WEST METRO RAPID TRANSITWAY		PEAK PERIOD BUS LANE

0 100 200 600

NOT FOR CONSTRUCTION

DESIGNED BY	JAF
DRAWN BY	JAF
CHECKED BY	MT.
IN CHARGE	RRH
DATE	1/03
REV	



LOS ANGELES COUNTY METROPOLITAN TRANSPORTATION AUTHORITY
SAN FERNANDO VALLEY NORTH-SOUTH TRANSITWAY CORRIDOR M.I.S.

MEYER, MOHADDES ASSOCIATES, INC.
707 WILSHIRE BLVD., SUITE 4810
LOS ANGELES, CA 90017

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CONSULTING ENGINEERS —
PLANNING - DESIGN - SURVEYING
234 DRAKE DRIVE
SAN BERNARDINO, CA 92408
(909) 884-3222 FAX (909) 383-1577

LANKERSHIM BLVD CORRIDOR
VENTURA BLVD TO SAN FERNANDO RD


CONTRACT NO	PS4350-1018
DRAWING NO	
REV	0
SCALE	1"=200'
SHEET NO	6 OF 12

MATCH LINE SEE SHEET 6



MATCH LINE SEE BELOW LEFT

MATCH LINE SEE ABOVE RIGHT

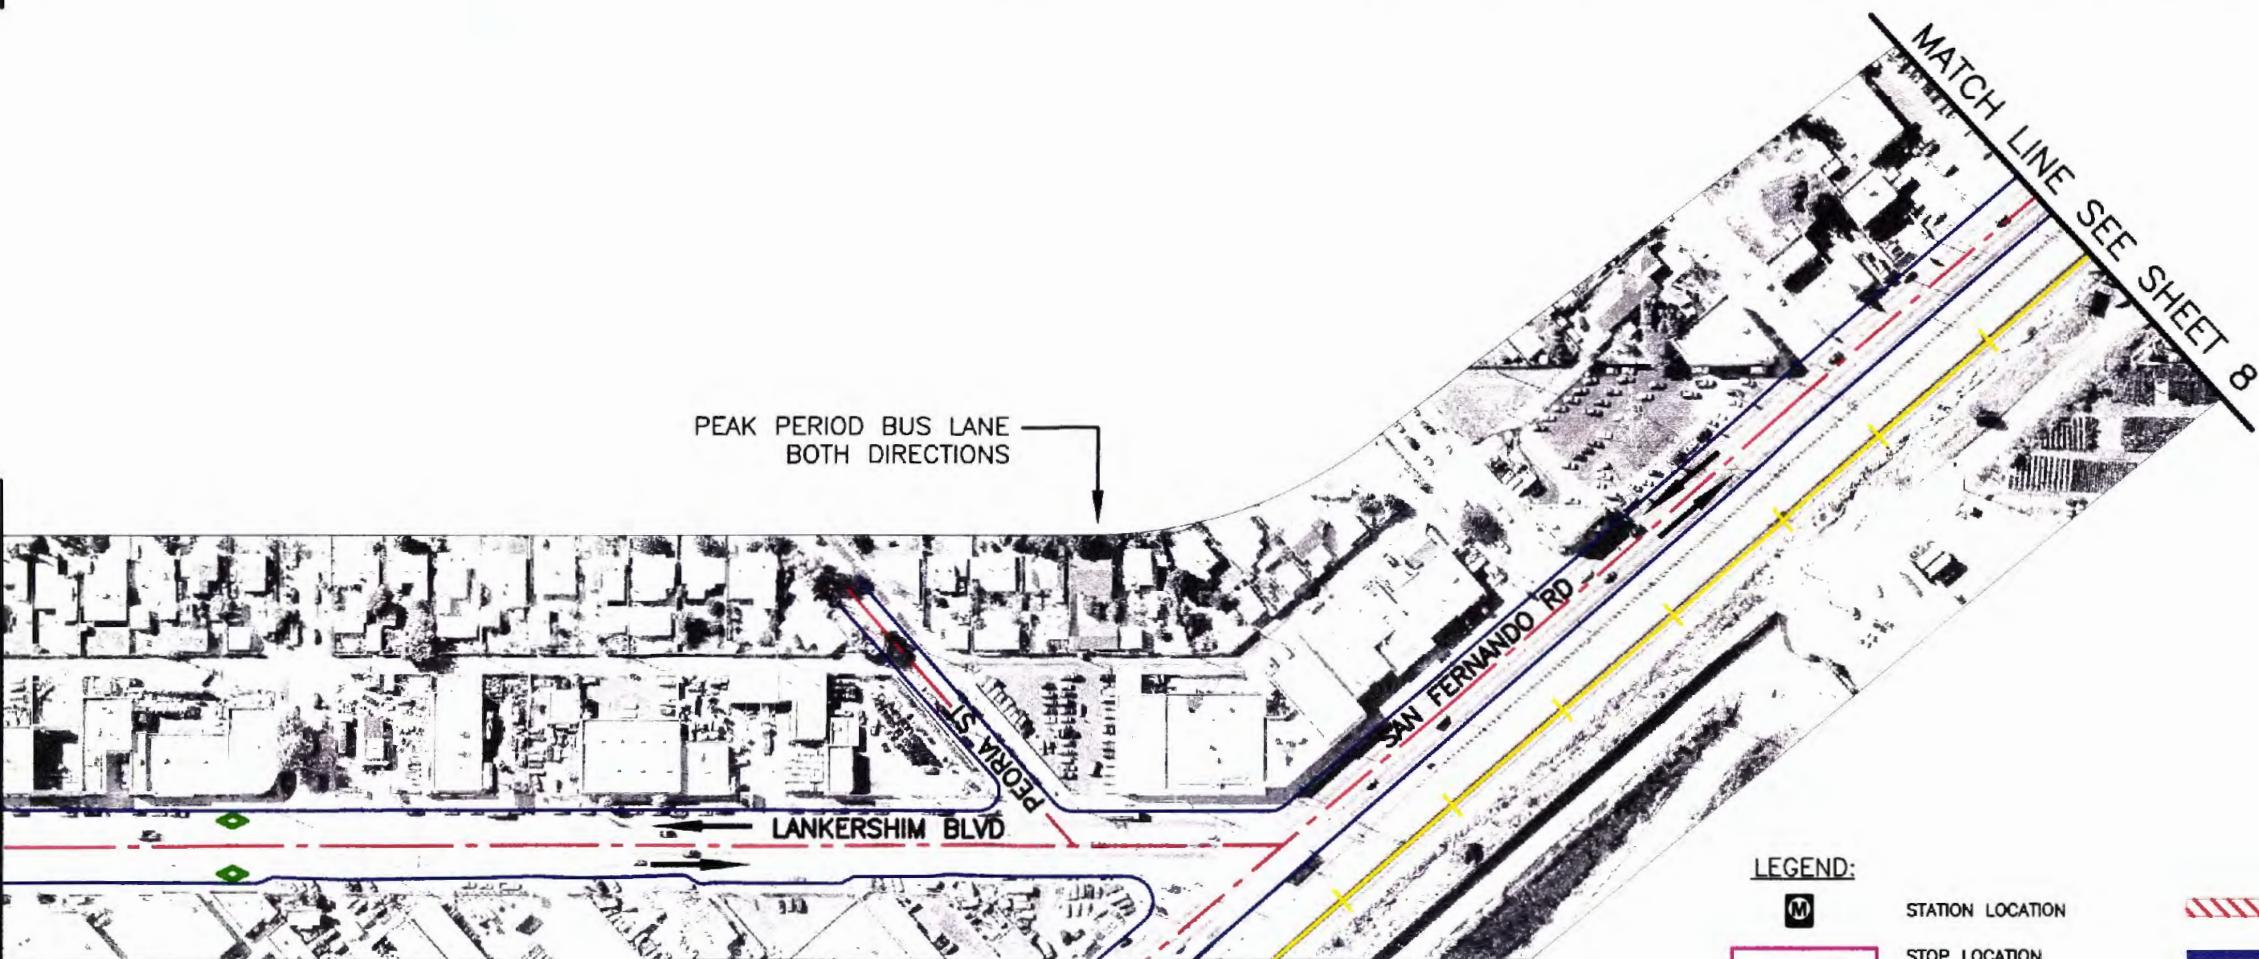

SCALE: 1"=200'

LEGEND:

- STATION LOCATION
- LANE WIDENING
- STOP LOCATION
- EXISTING FREEWAY
- PROPOSED BUS STATION
- MAIN DIRECTION OF FLOW
- EXISTING STREETS
- EXISTING ELEMENT
- EXISTING RIVER/WASH
- EXISTING RAILROAD
- FUTURE EAST-WEST METRO RAPID TRANSITWAY
- PEAK PERIOD BUS LANE

0 100 200 600

NOT FOR CONSTRUCTION

DESIGNED BY JAF	DRAWN BY JAF	CHECKED BY MT.	IN CHARGE RRH	SOLICITATION LEVEL 1/03	DESCRIPTION 1/03				
0 1/03									
REV DATE BY APP REG NO EXPIRES	SEAL HOLDER								


LOS ANGELES COUNTY METROPOLITAN TRANSPORTATION AUTHORITY
SAN FERNANDO VALLEY NORTH-SOUTH TRANSITWAY CORRIDOR M.I.S.
MEYER, MOHADDES ASSOCIATES, INC
707 WILSHIRE BLVD., SUITE 4810
LOS ANGELES, CA 90017

Hernandez, Kroone & Associates, Inc.
CONSULTING ENGINEERS —
PLANNING — DESIGN — SURVEYING
234 DRAKE DRIVE
SAN BERNARDINO, CA 92408
(909) 884-3222 FAX (909) 383-1577

LANKERSHIM BLVD CORRIDOR
VENTURA BLVD TO SAN FERNANDO RD


CONTRACT NO PS4350-1018	DRAWING NO	REV
		0
SCALE 1"=200'		
SHEET NO 7 OF 12		

MATCH LINE SEE SHEET 7

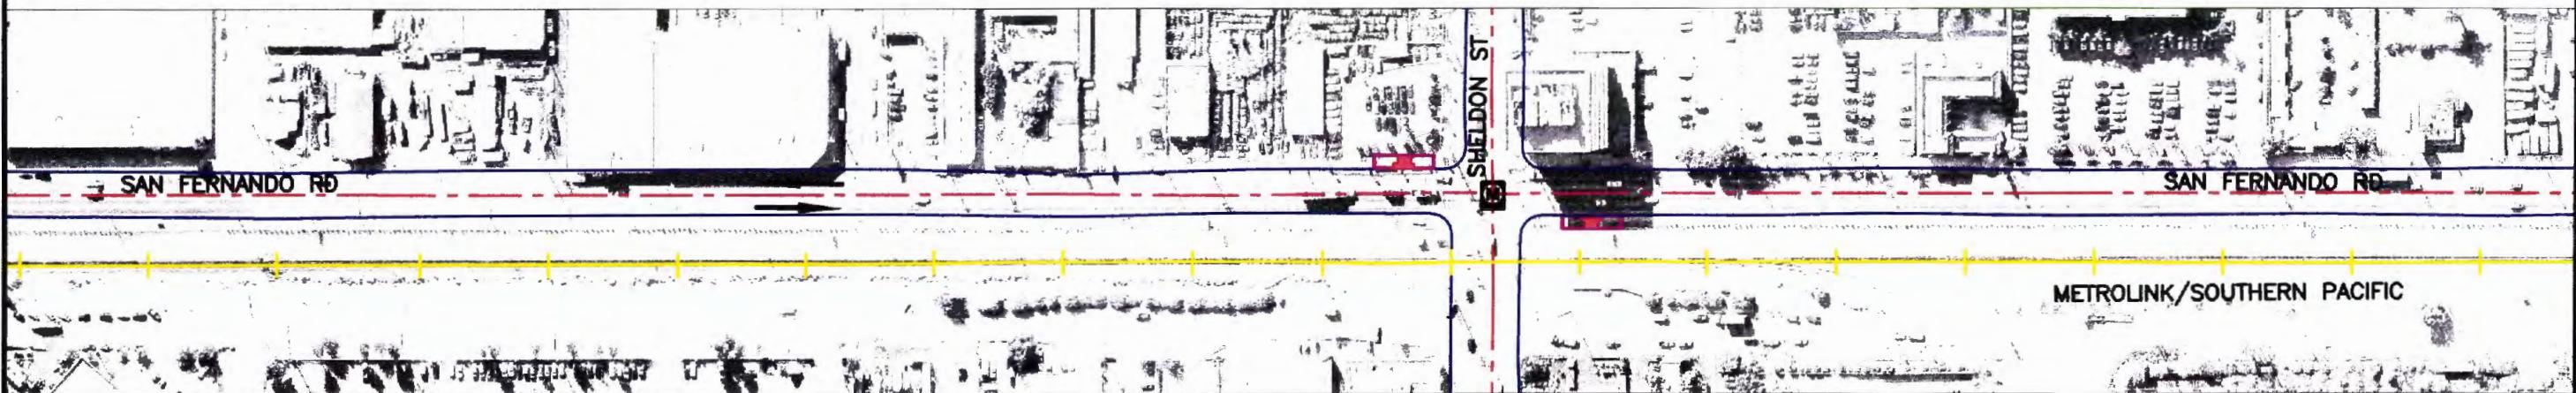

MATCH LINE SEE BELOW LEFT

MATCH LINE SEE ABOVE RIGHT

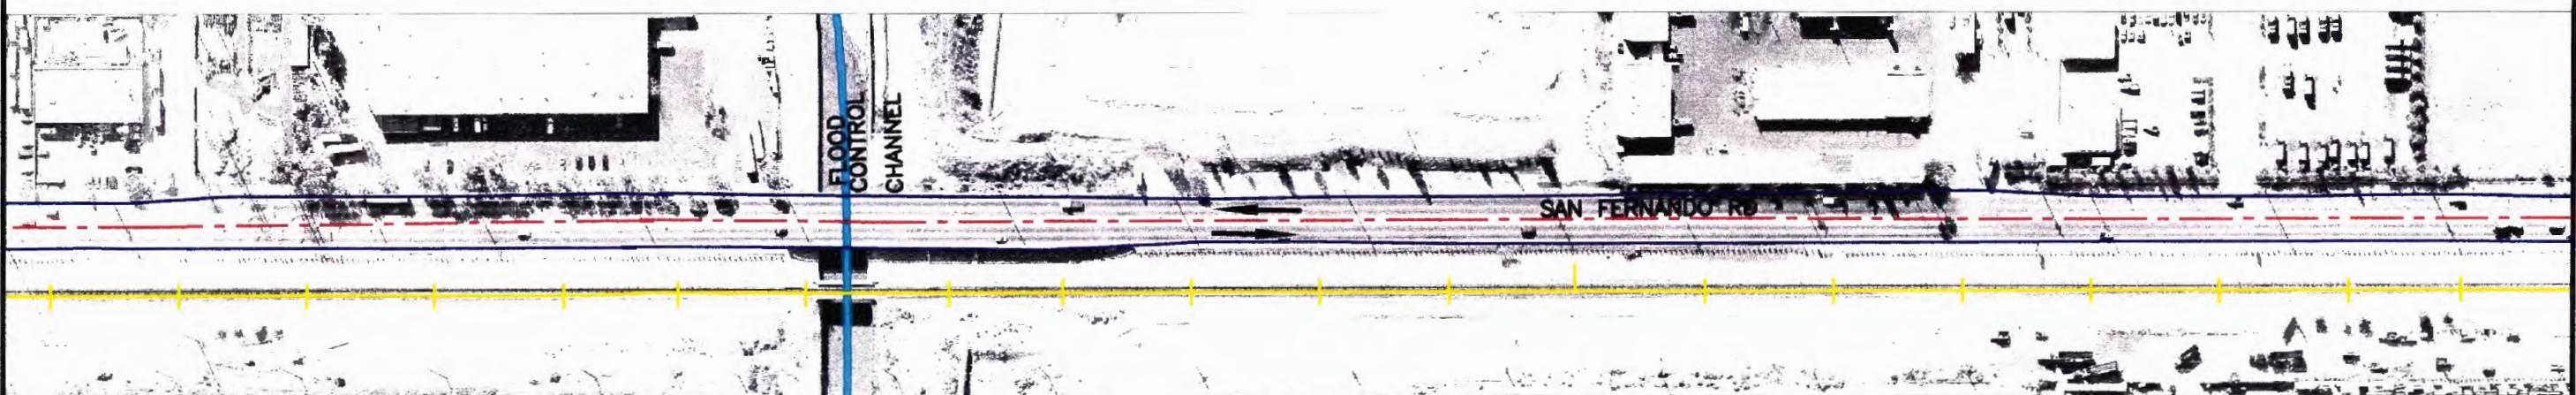

MATCH LINE SEE SHEET 9

LEGEND:

- | | | | |
|--|-----------------------------------------|--|------------------------|
| | STATION LOCATION | | LANE WIDENING |
| | STOP LOCATION | | EXISTING FREEWAY |
| | PROPOSED BUS STATION | | MAIN DIRECTION OF FLOW |
| | EXISTING STREETS | | EXISTING ELEMENT |
| | EXISTING RIVER/WASH | | EXISTING RAILROAD |
| | FUTURE EAST-WEST METRO RAPID TRANSITWAY | | PEAK PERIOD BUS LANE |

0 100 200 600
[Scale bar]

NOT FOR CONSTRUCTION

SOLICITATION LEVEL									
0	1/03								
REV	DATE	BY	APP	REG NO	EXPIRES	SEAL HOLDER			
							DESCRIPTION		

DESIGNED BY JAF
DRAWN BY JAF
CHECKED BY MT.
IN CHARGE RRH
DATE 1/03



LOS ANGELES COUNTY METROPOLITAN TRANSPORTATION AUTHORITY
SAN FERNANDO VALLEY NORTH-SOUTH TRANSITWAY CORRIDOR M.I.S.


MEYER, MOHADDES ASSOCIATES, INC.
707 WILSHIRE BLVD., SUITE 4810
LOS ANGELES, CA 90017

HKA
Hernandez, Kroone & Associates, Inc.
CONSULTING ENGINEERS
PLANNING - DESIGN - SURVEYING
234 DRAKE DRIVE
SAN BERNARDINO, CA 92408
(909) 884-3222 FAX (909) 383-1577

LANKERSHIM BLVD CORRIDOR
SAN FERNANDO RD
LANKERSHIM BLVD TO HUBBARD ST


CONTRACT NO PS4350-1018	DRAWING NO	REV 0
SCALE 1"-200'	SHEET NO	
		B OF 12

MATCH LINE SEE SHEET 8

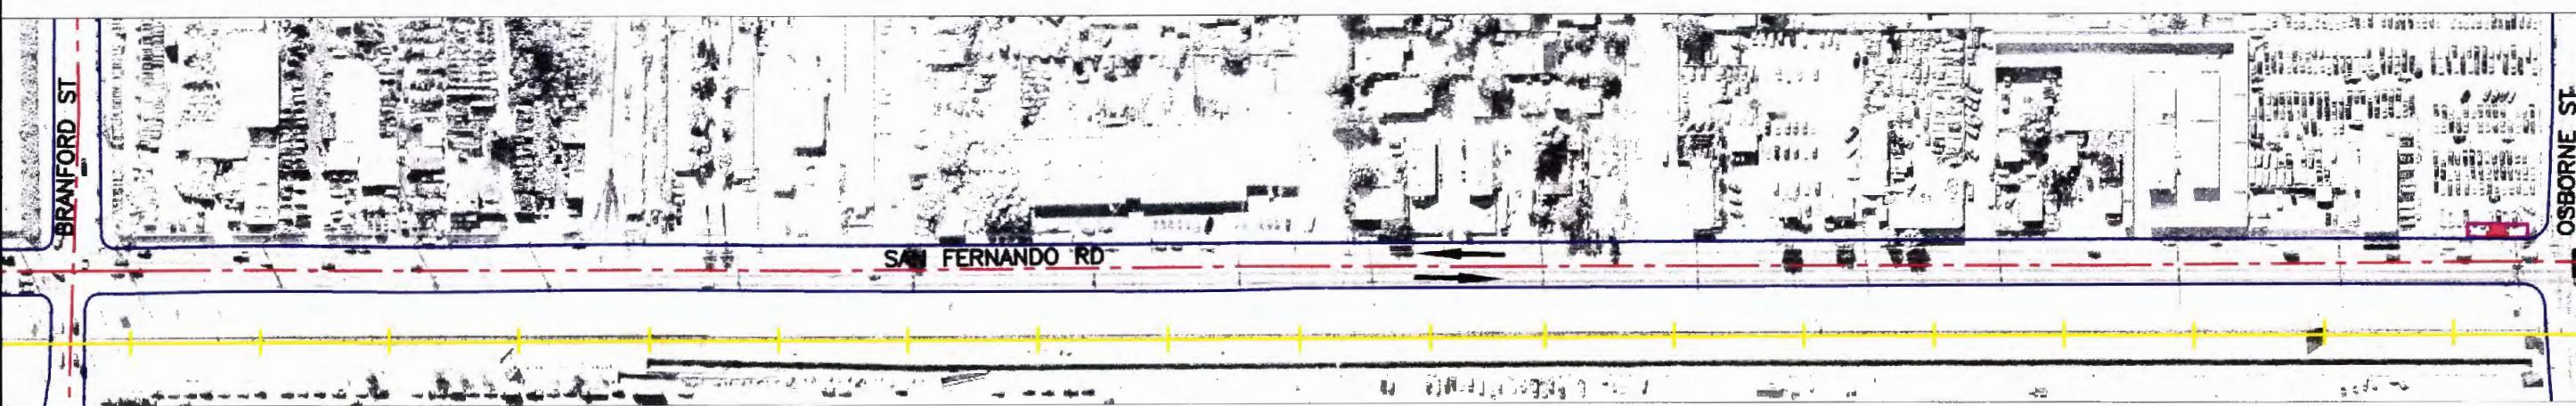

SCALE: 1"=200'

MATCH LINE SEE ABOVE RIGHT

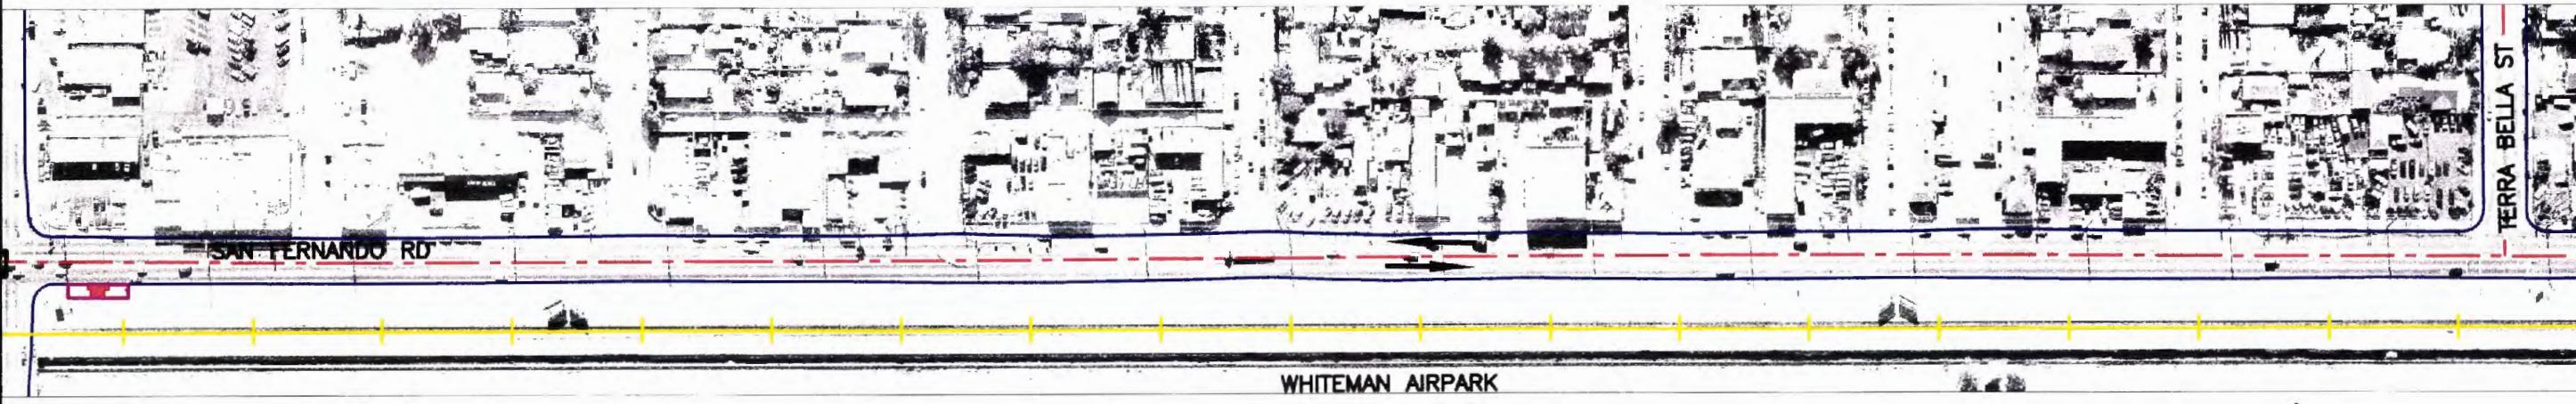

SCALE: 1"=200'

MATCH LINE SEE BELOW LEFT

MATCH LINE SEE SHEET 10

LEGEND:

- | | | | |
|--|-----------------------------------------|--|------------------------|
| | STATION LOCATION | | LANE WIDENING |
| | STOP LOCATION | | EXISTING FREEWAY |
| | PROPOSED BUS STATION | | MAIN DIRECTION OF FLOW |
| | EXISTING STREETS | | EXISTING ELEMENT |
| | EXISTING RIVER/WASH | | EXISTING RAILROAD |
| | FUTURE EAST-WEST METRO RAPID TRANSITWAY | | PEAK PERIOD BUS LANE |

0 100 200 600
[Scale bar]

NOT FOR CONSTRUCTION

REV	DATE	BY	APP	REG NO	EXPIRES	SEAL HOLDER	SOUCLITATION LEVEL
0	1/03						

DESIGNED BY JAF
DRAWN BY JAF
CHECKED BY MT.
IN CHARGE RRH
DATE 1/03



LOS ANGELES COUNTY METROPOLITAN TRANSPORTATION AUTHORITY
SAN FERNANDO VALLEY NORTH-SOUTH TRANSITWAY CORRIDOR M.I.S.


MEYER, MOHADDES ASSOCIATES, INC
707 WILSHIRE BLVD., SUITE 4810
LOS ANGELES, CA 90017

Hernandez, Kroone & Associates, Inc.
CONSULTING ENGINEERS
PLANNING - DESIGN - SURVEYING
234 DRAKE DRIVE
SAN BERNARDINO, CA 92408
(909) 884-3222 FAX (909) 383-1577

LANKERSHIM BLVD CORRIDOR
VENTURA BLVD TO SAN FERNANDO RD
LANKERSHIM BLVD TO HUBBARD ST


CONTRACT NO PS4350-1018
DRAWING NO
REV 0
SCALE 1"=200'
SHEET NO 9 OF 12

MATCH LINE SEE SHEET 9

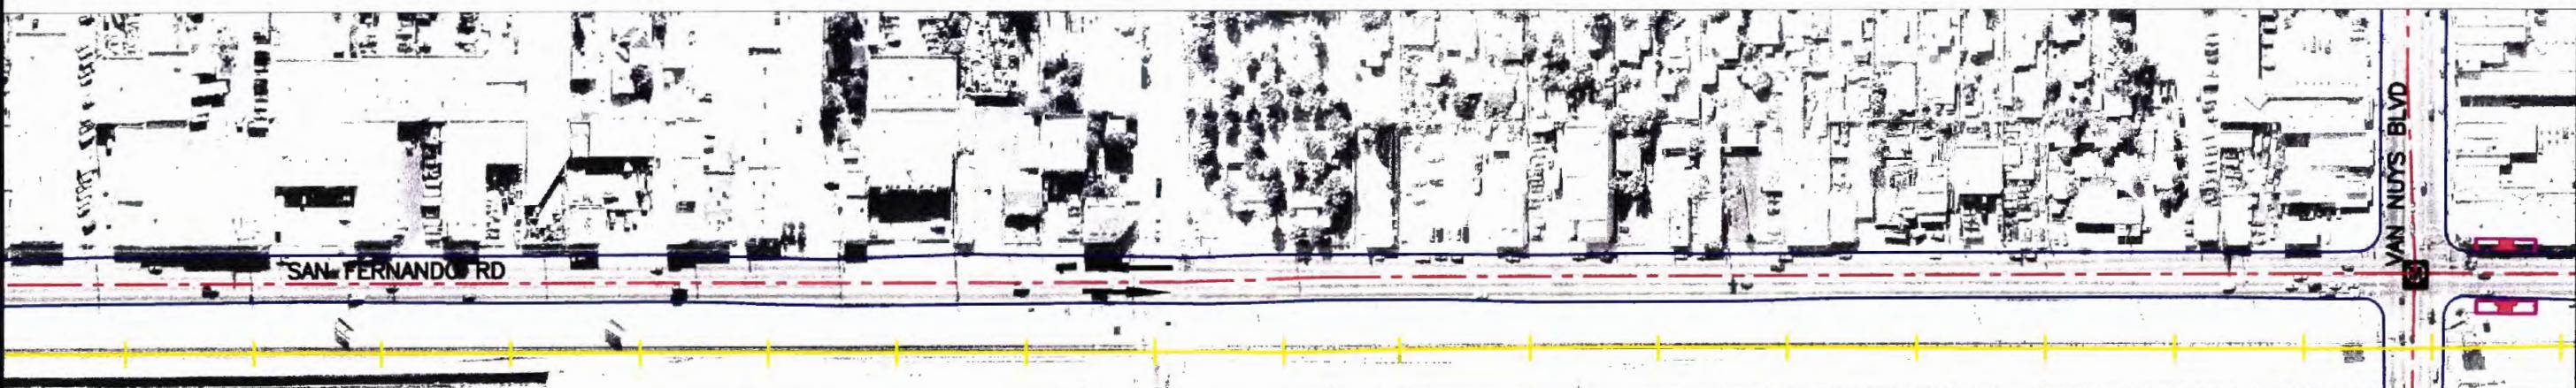

SCALE: 1"=200'

MATCH LINE SEE ABOVE RIGHT

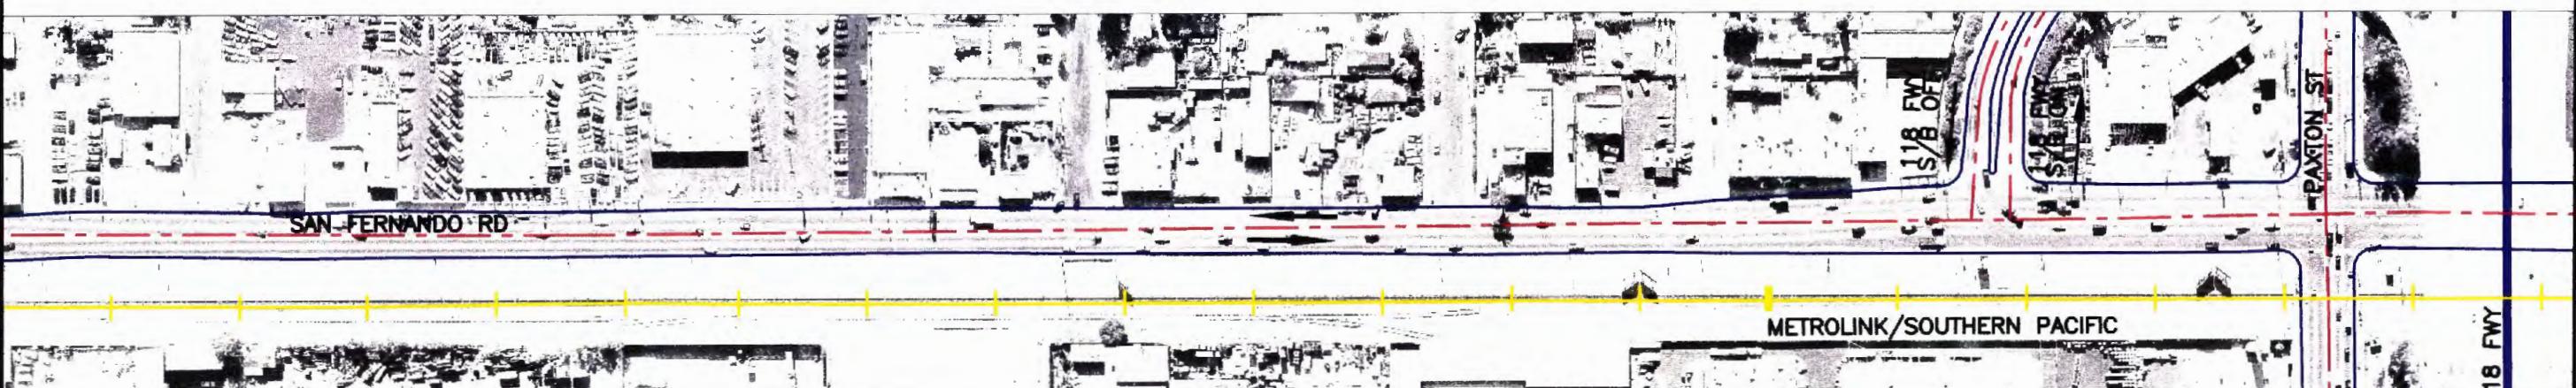

SCALE: 1"=200'

MATCH LINE SEE BELOW LEFT

MATCH LINE SEE SHEET 11

LEGEND:

- | | | | |
|--|-----------------------------------------|--|------------------------|
| | STATION LOCATION | | LANE WIDENING |
| | STOP LOCATION | | EXISTING FREEWAY |
| | PROPOSED BUS STATION | | MAIN DIRECTION OF FLOW |
| | EXISTING STREETS | | EXISTING ELEMENT |
| | EXISTING RIVER/WASH | | EXISTING RAILROAD |
| | FUTURE EAST-WEST METRO RAPID TRANSITWAY | | PEAK PERIOD BUS LANE |

0 100 200 600

NOT FOR CONSTRUCTION

SOLICITATION LEVEL									
0	1/03								
REV	DATE	BY	APP	REG NO	EXPIRES	SEAL HOLDER			

DESIGNED BY JAF
DRAWN BY JAF
CHECKED BY MT.
IN CHARGE RRH
DATE 1/03



LOS ANGELES COUNTY METROPOLITAN TRANSPORTATION AUTHORITY
SAN FERNANDO VALLEY NORTH-SOUTH TRANSITWAY CORRIDOR M.I.S.


MEYER, MOHADDES ASSOCIATES, INC
707 WILSHIRE BLVD., SUITE 4810
LOS ANGELES, CA 90017

Hernandez, Kroone & Associates, Inc.
CONSULTING ENGINEERS
PLANNING - DESIGN - SURVEYING
234 DRAKE DRIVE
SAN BERNARDINO, CA 92408
(909) 884-3222 FAX (909) 383-1577

LANKERSHIM BLVD CORRIDOR
VENTURA BLVD TO SAN FERNANDO RD
LANKERSHIM BLVD TO HUBBARD ST

CONTRACT NO
PS4350-101B
DRAWING NO
REV 0
SCALE
1"=200'
SHEET NO
10 OF 12

MATCH LINE SEE SHEET 10

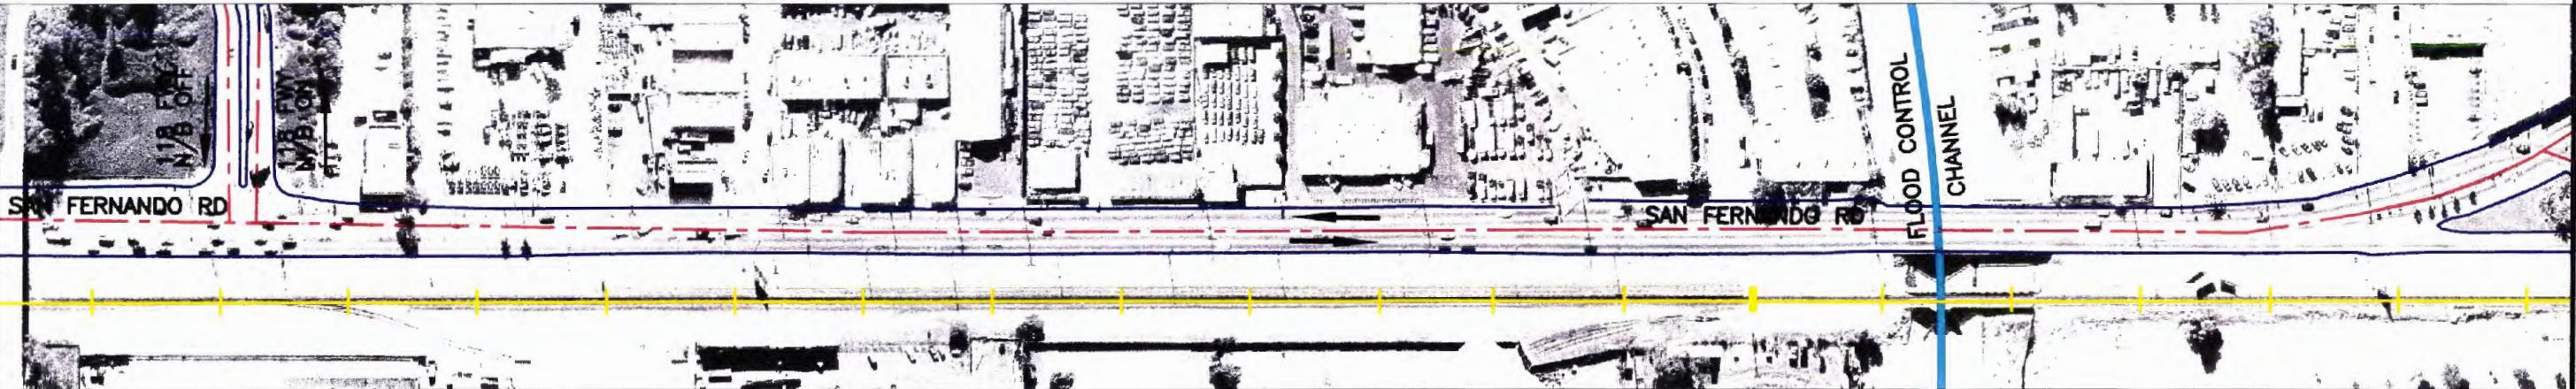

MATCH LINE SEE ABOVE RIGHT



LEGEND:

- | | | | |
|--|-----------------------------------------|--|------------------------|
| | STATION LOCATION | | LANE WIDENING |
| | STOP LOCATION | | EXISTING FREEWAY |
| | PROPOSED BUS STATION | | MAIN DIRECTION OF FLOW |
| | EXISTING STREETS | | EXISTING ELEMENT |
| | EXISTING RIVER/WASH | | EXISTING RAILROAD |
| | FUTURE EAST-WEST METRO RAPID TRANSITWAY | | PEAK PERIOD BUS LANE |

0 100 200 600

NOT FOR CONSTRUCTION

						DESIGNED BY JAF	MEYER, MOHADDES ASSOCIATES, INC. 707 WILSHIRE BLVD., SUITE 4810 LOS ANGELES, CA 90017	LOS ANGELES COUNTY METROPOLITAN TRANSPORTATION AUTHORITY SAN FERNANDO VALLEY NORTH-SOUTH TRANSITWAY CORRIDOR M.I.S.	
						DRAWN BY JAF			
						CHECKED BY MT.			
						IN CHARGE RRH			
						DATE 1/03			
0	1/03	BY	APP	REG NO	EXPIRES	SEAL HOLDER		SOLICITATION LEVEL	
REV								DESCRIPTION	

DESIGNED BY
JAF
DRAWN BY
JAF
CHECKED BY
MT.
IN CHARGE
RRH
DATE
1/03

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Hernandez, Kroone & Associates, Inc.
CONSULTING ENGINEERS —
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SAN BERNARDINO, CA 92408
(909) 864-3222 FAX (909) 383-1577

LANKERSHIM BLVD CORRIDOR
VENTURA BLVD TO SAN FERNANDO RD
LANKERSHIM BLVD TO HUBBARD ST


CONTRACT NO
PS4350-1018
DRAWING NO
REV
SCALE
1"=200'
SHEET NO
11 OF 12

MATCH LINE SEE ABOVE RIGHT

MATCH LINE SEE SHEET 11



SCALE: $1''=200'$

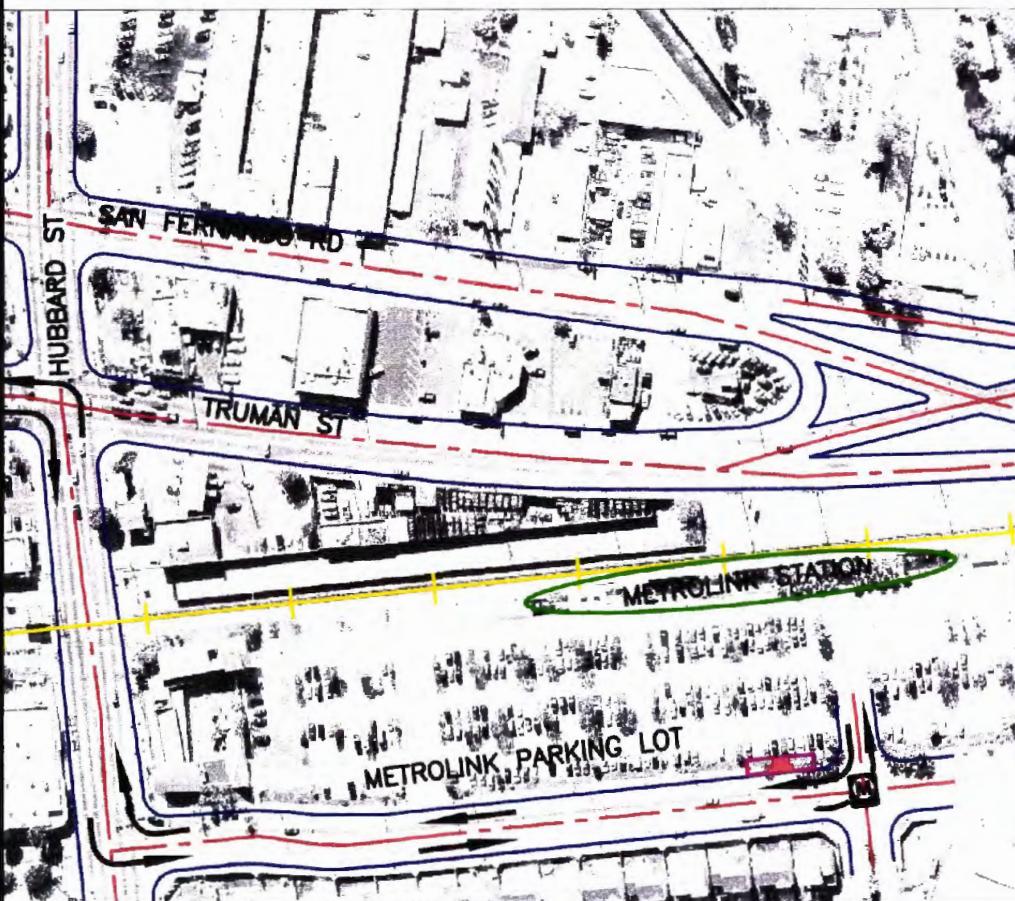

SCALE: $1''=200'$

LEGEND:

- M** STATION LOCATION
- LANE WIDENING
- STOP LOCATION
- EXISTING FREEWAY
- PROPOSED BUS STATION
- MAIN DIRECTION OF FLOW
- EXISTING STREETS
- - -** EXISTING ELEMENT
- EXISTING RIVER/WASH
- EXISTING RAILROAD
- FUTURE EAST-WEST METRO RAPID TRANSITWAY
- ◆** PEAK PERIOD BUS LANE

0 100 200 600

NOT FOR CONSTRUCTION

							DESIGNED BY JAF
							DRAWN BY JAF
							CHECKED BY MT.
							IN CHARGE RRH
0	1/03						SOLICITATION LEVEL
REV	DATE	BY	APP	REG NO	EXPIRES	SEAL HOLDER	DESCRIPTION

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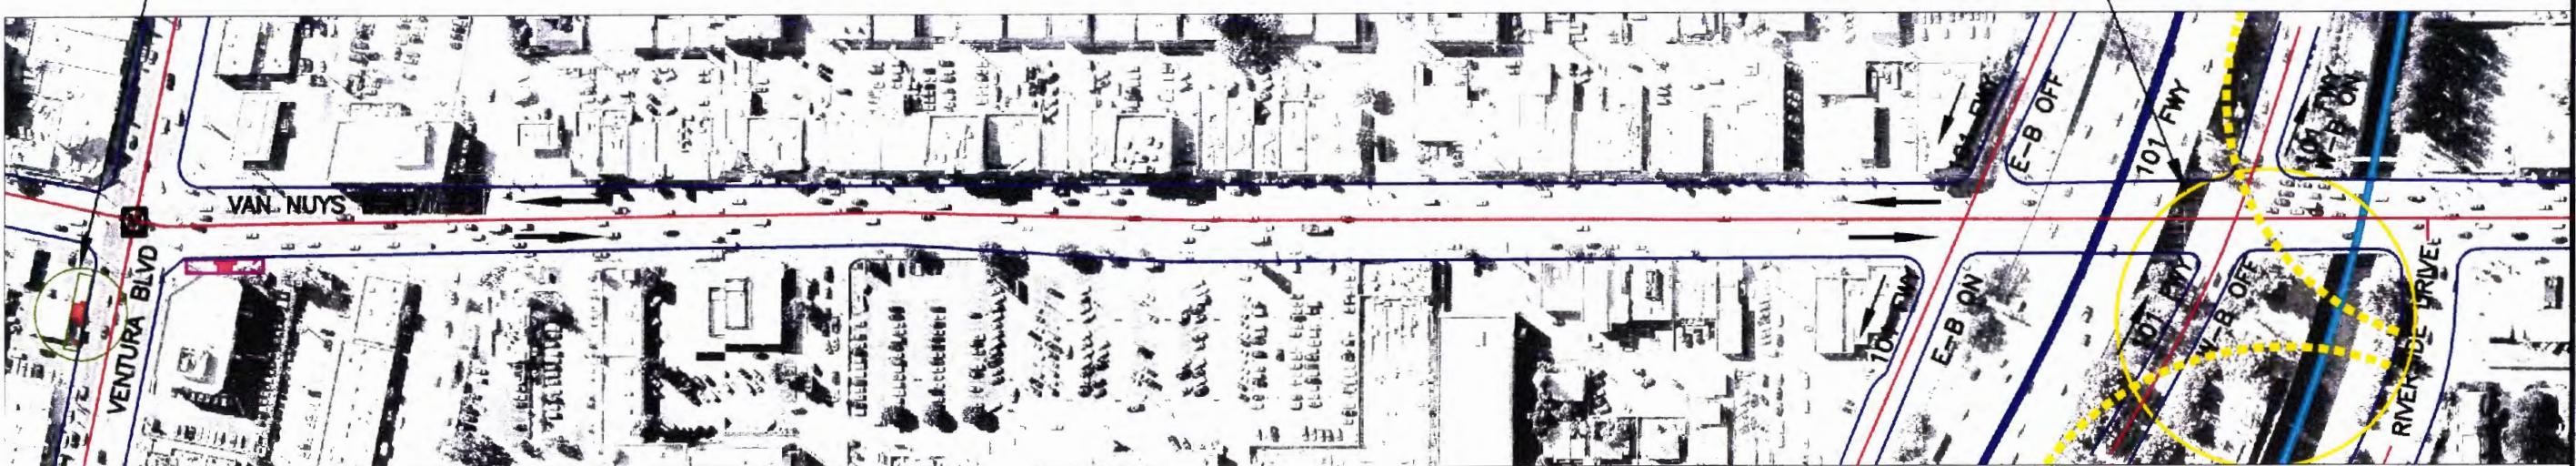
1/03

1/03

1/03

1/03


RECONSTRUCTION
OF INTERCHANGE
PROJECT



SCALE: 1"=200'

MATCH LINE SEE BELOW LEFT

MATCH LINE SEE ABOVE RIGHT

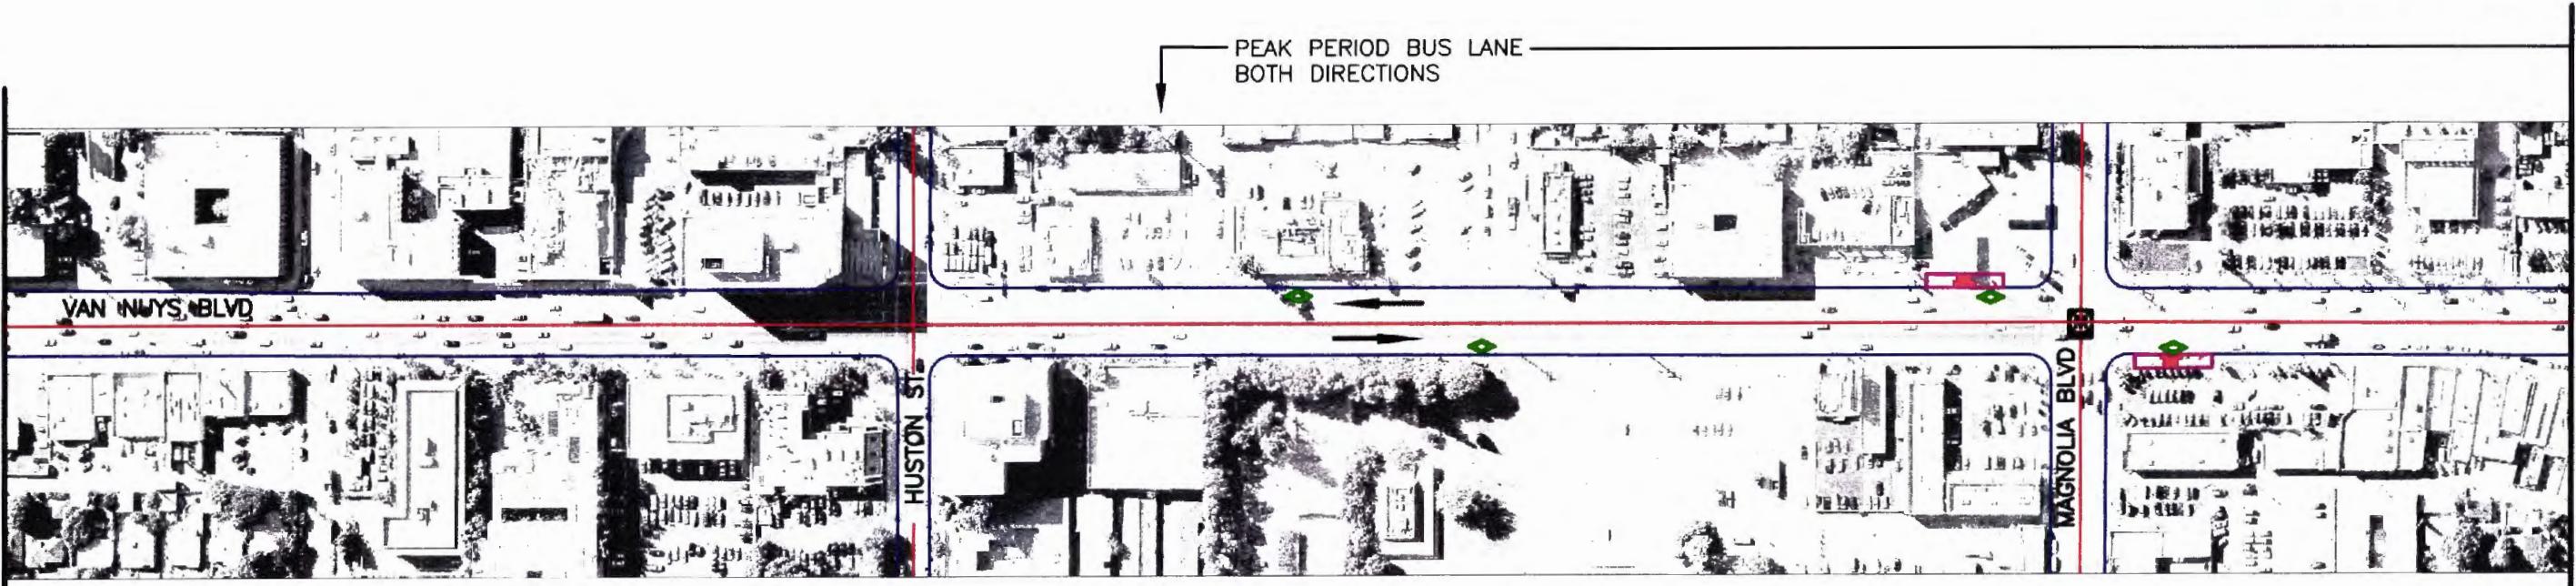

MATCH LINE SEE SHEET 2

LEGEND:

- STATION LOCATION
- MAIN DIRECTION OF FLOW
- STOP LOCATION
- EXISTING ELEMENT
- PROPOSED BUS STATION
- INDICATES POP-OUT
- EXISTING STREETS
- EXISTING RIVER/WASH
- FUTURE EAST-WEST METRO RAPID TRANSITWAY
- EXISTING FREEWAY
- SIGNAL MODIFICATION
- BRIDGE WIDENING
- PEAK PERIOD BUS LANE

SCALE: 1"=200'

0 100 200 600

NOT FOR CONSTRUCTION

DESIGNED BY	JAF	DRAWN BY	JAF	CHECKED BY	MT.	IN CHARGE	RRH	SOLICITATION LEVEL					
REV	0 1/03	DATE	BY APP	REQ NO	EXPIRES	SEAL HOLDER	DESCRIPTION						

DESIGNED BY JAF
DRAWN BY JAF
CHECKED BY MT.
IN CHARGE RRH
DATE 1/03

M LOS ANGELES COUNTY METROPOLITAN TRANSPORTATION AUTHORITY
SAN FERNANDO VALLEY NORTH-SOUTH TRANSITWAY CORRIDOR M.I.S.
MEYER, MOHADDES ASSOCIATES, INC. 707 WILSHIRE BLVD., SUITE 4810
LOS ANGELES, CA 90017


H K Hernandez, Kroone & Associates, Inc.
CONSULTING ENGINEERS — PLANNING DESIGN SURVEYING
234 DRAKE DRIVE SAN BERNARDINO, CA 92408
(909) 884-3222 FAX (909) 383-1577

VAN NUYS BLVD CORRIDOR
VENTURA BLVD TO FOOTHILL BLVD

CONTRACT NO.
PS4350-1018
DRAWING NO. REV 0
SCALE 1"-200'
SHEET NO. 1 OF 14

MATCH LINE SEE ABOVE RIGHT

MATCH LINE SEE SHEET 1

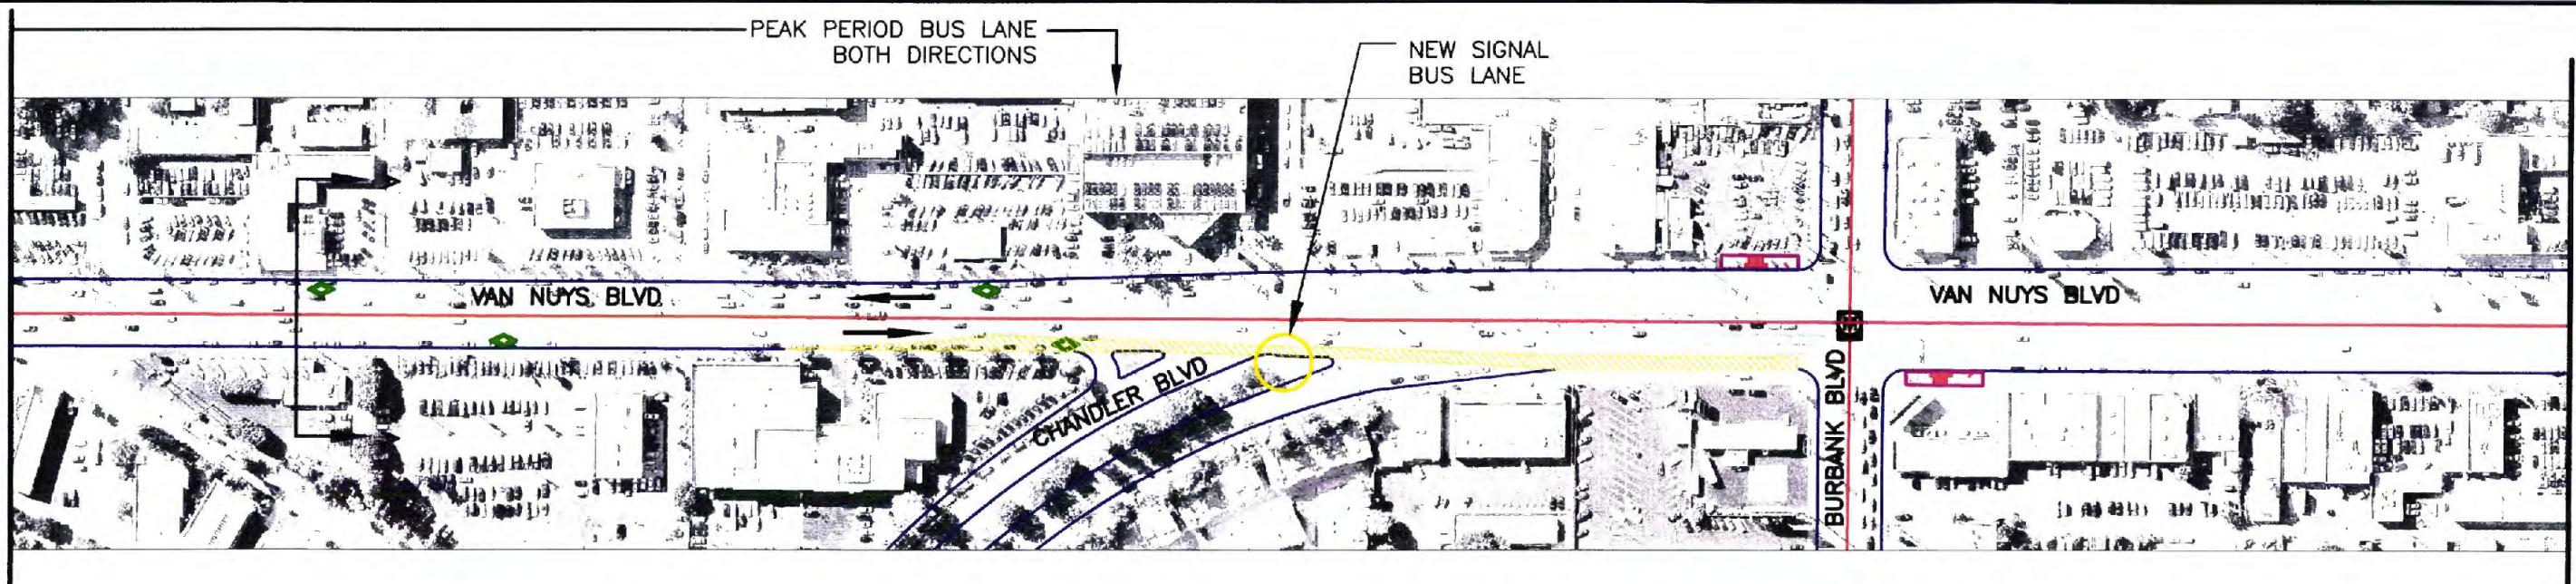


MATCH LINE SEE BELOW LEFT

SCALE: 1"=200'

LEGEND:

- M** STATION LOCATION
- MAIN DIRECTION OF FLOW
- STOP LOCATION
- EXISTING ELEMENT
- PROPOSED BUS STATION
- SPECIAL BY PASS BUS LANE CONFIGURATION
- EXISTING STREETS
- SM** SIGNAL MODIFICATION
- EXISTING RIVER/WASH
- BRIDGE WIDENING
- FUTURE EAST-WEST METRO RAPID TRANSITWAY
- PEAK PERIOD BUS LANE
- EXISTING FREEWAY

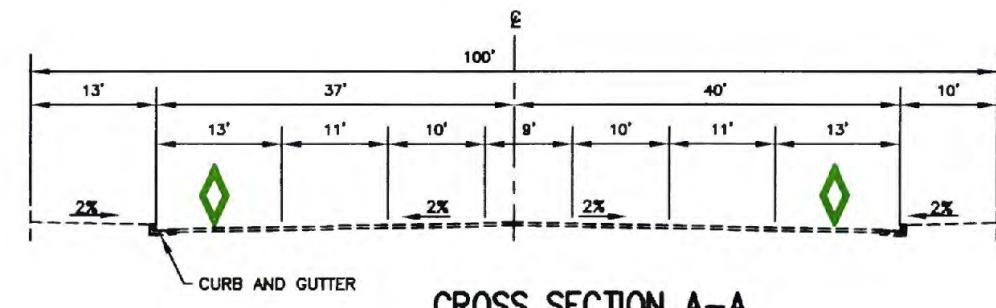

FUTURE EAST-WEST METRO RAPID TRANSITWAY

SCALE: 1"=200'

0 100 200 600

NOT FOR CONSTRUCTION

0	1/03								
REV	DATE	BY	APP	REG NO	EXPIRES	SEAL HOLDER	SOLICITATION LEVEL	DESCRIPTION	

DESIGNED BY
DRAWN BY
CHECKED BY
IN CHARGE
DATE

JAF
JAF
MT.
RRH
1/03

M
MEYER, MOHADDES ASSOCIATES, INC.

707 WILSHIRE BLVD., SUITE 4810
LOS ANGELES, CA 90017

DRAWN BY
CHECKED BY
IN CHARGE
DATE

JAF
MT.
RRH
1/03

HKA
Hernandez, Kroone & Associates, Inc.
CONSULTING ENGINEERS —
PLANNING - DESIGN - SURVEYING
234 DRAKE DRIVE
SAN BERNARDINO, CA 92408
(909) 884-3222 FAX (909) 383-1577

VAN NUYS BLVD CORRIDOR
VENTURA BLVD TO FOOTHILL BLVD


CONTRACT NO
PS4350-1018
DRAWING NO
REV
SCALE
1"=200'
SHEET NO
2 OF 14

MATCH LINE SEE SHEET 2



MATCH LINE SEE BELOW LEFT


MATCH LINE SEE ABOVE RIGHT

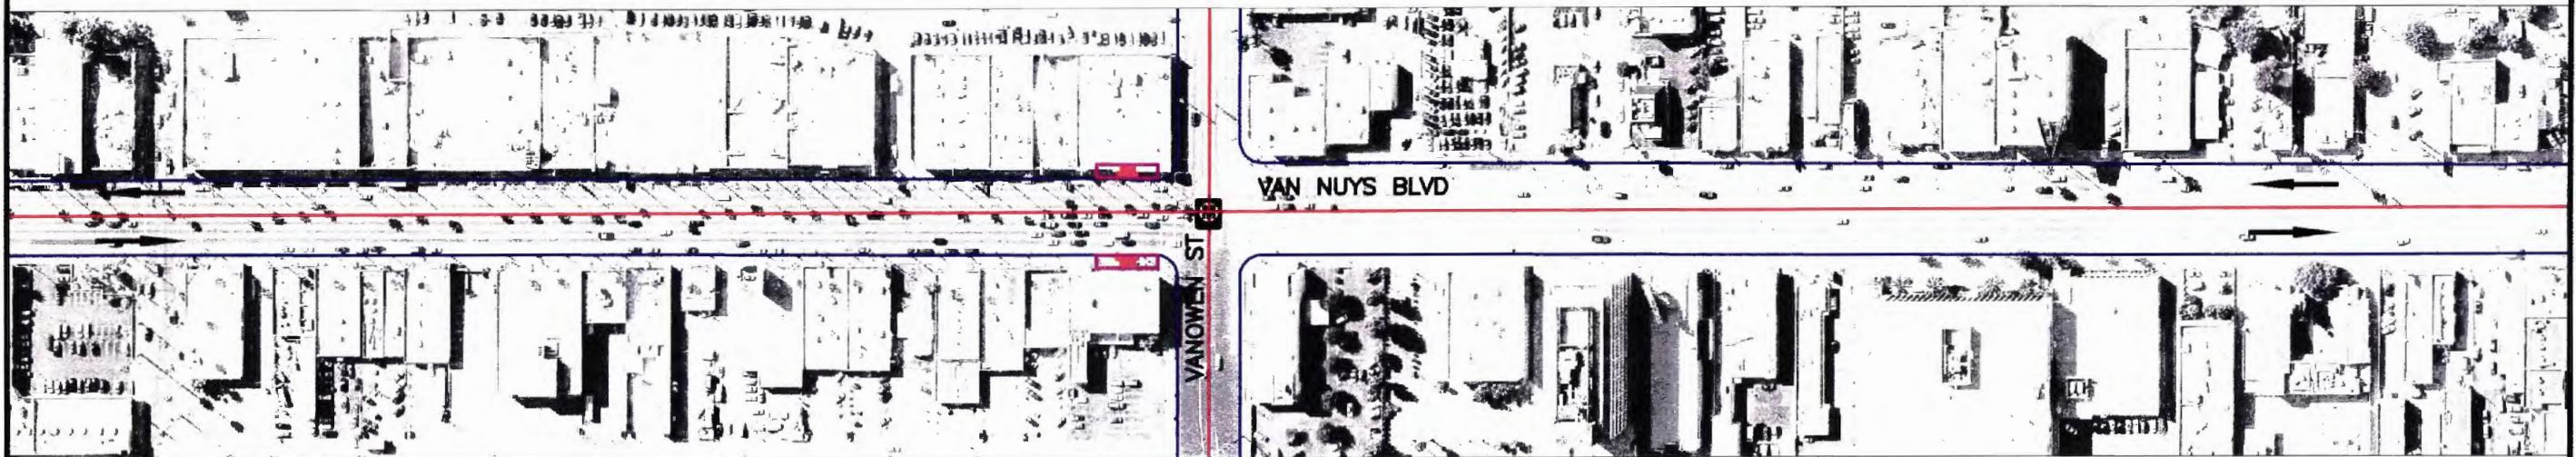

MATCH LINE SEE SHEET 4

LEGEND:

- STATION LOCATION
- MAIN DIRECTION OF FLOW
- STOP LOCATION
- EXISTING ELEMENT
- PROPOSED BUS STATION
- INDICATES POP-OUT
- EXISTING STREETS
- EXISTING RIVER/WASH
- FUTURE EAST-WEST METRO RAPID TRANSITWAY
- EXISTING FREEWAY
- SIGNAL MODIFICATION
- BRIDGE WIDENING
- 60' BUS

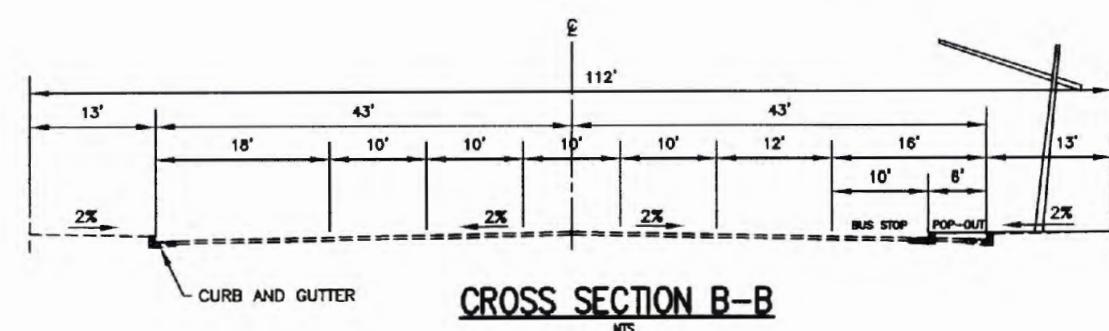

SCALE: 1"=200'

SCALE: 1"=200'

0 100 200 600

NOT FOR CONSTRUCTION

SOLICITATION LEVEL									
DESIGNED BY	JAF	DRAWN BY	JAF	CHECKED BY	MT.	IN CHARGE	RRH	DATE	1/03
REV	DATE	BY	APP	REQ NO	EXPIRES	SEAL HOLDER	DESCRIPTION	1/03	

LOS ANGELES COUNTY METROPOLITAN TRANSPORTATION AUTHORITY
SAN FERNANDO VALLEY NORTH-SOUTH TRANSITWAY CORRIDOR M.I.S.

MEYER, MOHADDES ASSOCIATES, INC.
707 WILSHIRE BLVD., SUITE 4810
LOS ANGELES, CA 90017


HKA
Hernandez, Kroone & Associates, Inc.
CONSULTING ENGINEERS
PLANNING - DESIGN - SURVEYING
234 DRAKE DRIVE
SAN BERNARDINO, CA 92408
(909) 884-3222 FAX (909) 383-1577

VAN NUYS BLVD CORRIDOR
VENTURA BLVD TO FOOTHILL BLVD

CONTRACT NO
PS4350-1018
DRAWING NO
REV
0
SCALE
1"-200'
SHEET NO
3 OF 14


MATCH LINE SEE ABOVE RIGHT

MATCH LINE SEE SHEET 3

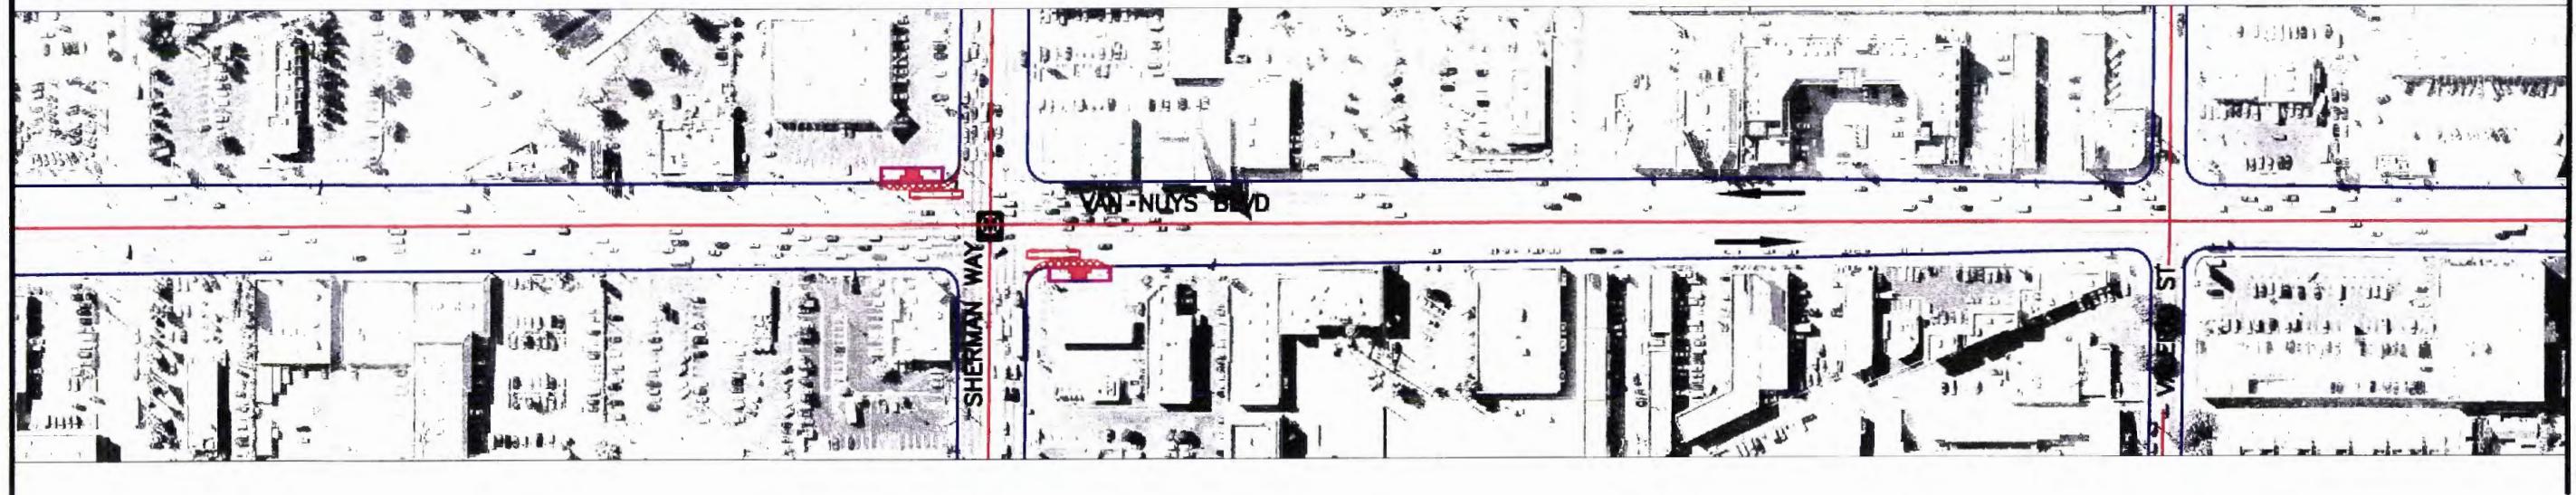

MATCH LINE SEE BELOW LEFT

SCALE: 1"=200'

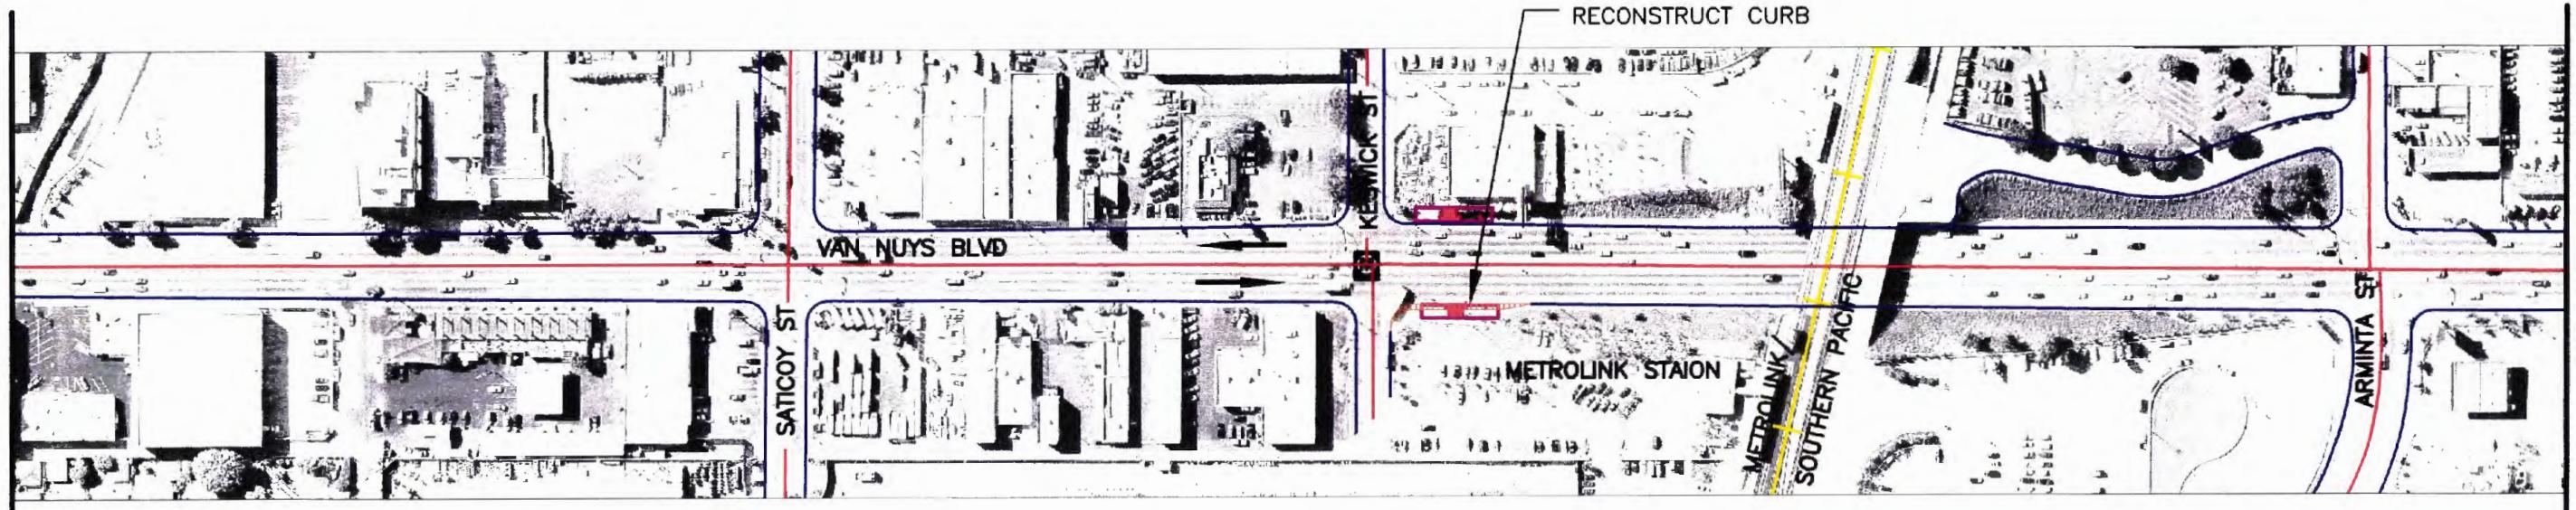

MATCH LINE SEE SHEET 5

LEGEND:

- STATION LOCATION
- MAIN DIRECTION OF FLOW
- STOP LOCATION
- EXISTING ELEMENT
- PROPOSED BUS STATION
- INDICATES POP-OUT
- EXISTING STREETS
- SIGNAL MODIFICATION
- EXISTING RIVER/WASH
- CURB RECONSTRUCT
- FUTURE EAST-WEST METRO RAPID TRANSITWAY
- EXISTING RAILROAD
- 60' BUS
- EXISTING FREEWAY

SCALE: 1"=200'

0 100 200 600

NOT FOR CONSTRUCTION

SOLICITATION LEVEL									
0	1/03								
REV	DATE	BY	APP	REQ NO	EXPIRES	SEAL HOLDER			

DESIGNED BY JAF	Hernandez, Kroone & Associates, Inc. CONSULTING ENGINEERS — PLANNING - DESIGN - SURVEYING 234 DRAKE DRIVE SAN BERNARDINO, CA 92408 (909) 884-3222 FAX (909) 383-1577
DRAWN BY JAF	
CHECKED BY MT.	
IN CHARGE RRH	
DATE 1/03	

LOS ANGELES COUNTY METROPOLITAN TRANSPORTATION AUTHORITY
SAN FERNANDO VALLEY NORTH-SOUTH TRANSITWAY CORRIDOR M.I.S.
MEYER, MOHADDES ASSOCIATES, INC.
707 WILSHIRE BLVD., SUITE 4810
LOS ANGELES, CA 90017

HKA
Hernandez, Kroone & Associates, Inc.
CONSULTING ENGINEERS — PLANNING - DESIGN - SURVEYING
234 DRAKE DRIVE
SAN BERNARDINO, CA 92408
(909) 884-3222 FAX (909) 383-1577

VAN NUYS BLVD CORRIDOR
VENTURA BLVD TO FOOTHILL BLVD


CONTRACT NO
PS4350-1018
DRAWING NO
REV
0
SCALE
1"=200'
SHEET NO
4 OF 14

MATCH LINE SEE SHEET 4



בְּרִיאָה בְּרִיאָה בְּרִיאָה

MATCH LINE SEE ABOVE RIGHT

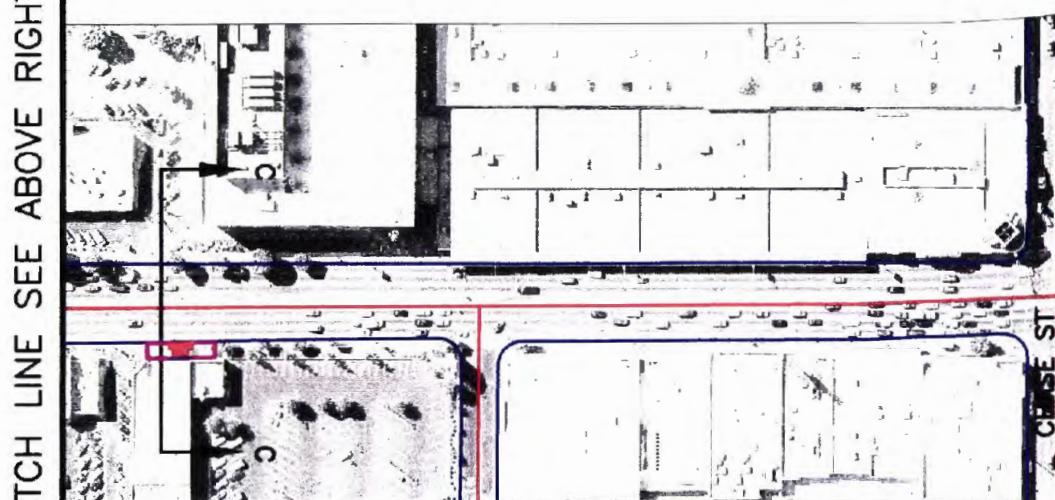


This aerial map illustrates a proposed redesign for an intersection. A red circle highlights the 'REDESIGN INTERSECTION' area, which includes Parthenia Street (labeled 'PARTHENIA ST') and Van Nuys Boulevard (labeled 'VAN NUYS BLVD'). A blue circle indicates a specific point of interest within the redesign area. A red line labeled 'SOUTH BOUND BUS LANE' shows the path of a bus lane. The map also features a legend at the bottom left and a scale bar at the bottom right.

卷之三

LEGEND:

- | | | | |
|----------|-----------------------------------------|--|------------------------|
| M | STATION LOCATION | | MAIN DIRECTION OF FLOW |
| | STOP LOCATION | | EXISTING ELEMENT |
| | PROPOSED BUS STATION | | INDICATES POP-OUT |
| | EXISTING STREETS | | SIGNAL MODIFICATION |
| | EXISTING RIVER/WASH | | BRIDGE WIDENING |
| | FUTURE EAST-WEST METRO RAPID TRANSITWAY | | EXISTING RAILROAD |
| | EXISTING FREEWAY | | 60' BUS |

NOT FOR CONSTRUCTION

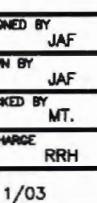

LOS ANGELES COUNTY METROPOLITAN TRANSPORTATION AUTHORITY
SAN FERNANDO VALLEY NORTH-SOUTH TRANSITWAY CORRIDOR M.I.S.

MEYER, MOHADDES ASSOCIATES, INC
707 WILSHIRE BLVD., SUITE 4810
LOS ANGELES, CA 90017



Hernandez, Kroone
& Associates, Inc.
— CONSULTING ENGINEERS —
PLANNING - DESIGN - SURVEYING
234 DRAKE DRIVE
SAN BERNARDINO, CA 92408
(909) 884-3222 FAX (909) 363-1577

VAN NUYS BLVD CORRIDOR
VENTURA BLVD TO FOOTHILL BLVD


CONSTRUCTION
FACT NO
PS4350-1018
IC NO REV
0
1"=200'
NO
5 OF 14

MATCH LINE SEE SHEET 5



MATCH LINE SEE BELOW LEFT

MATCH LINE SEE ABOVE RIGHT

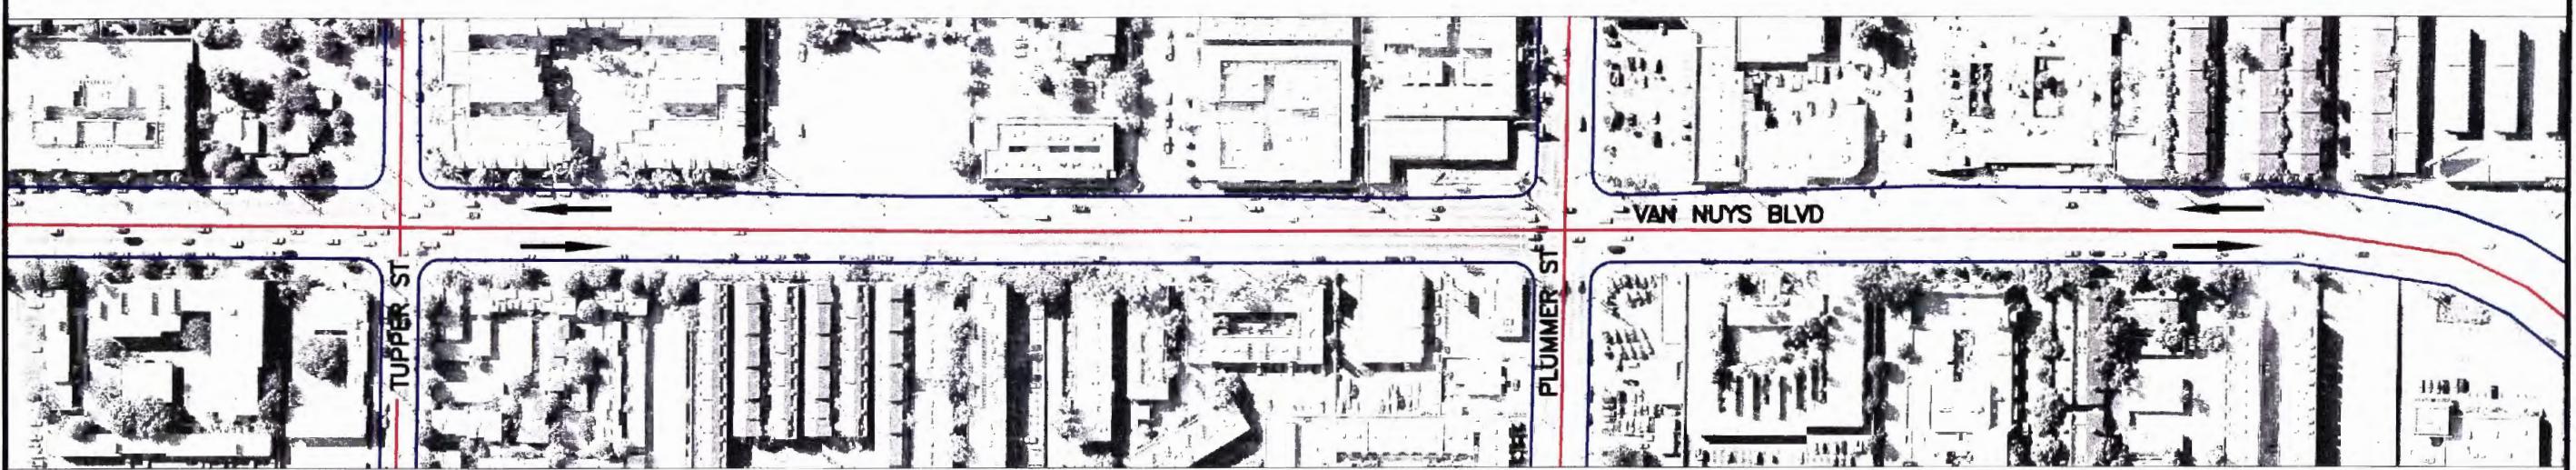

MATCH LINE SEE SHEET 7

LEGEND:

- STATION LOCATION
- MAIN DIRECTION OF FLOW
- STOP LOCATION
- EXISTING ELEMENT
- PROPOSED BUS STATION
- INDICATES POP-OUT
- EXISTING STREETS
- SIGNAL MODIFICATION
- EXISTING RIVER/WASH
- BRIDGE WIDENING
- FUTURE EAST-WEST METRO RAPID TRANSITWAY
- EXISTING RAILROAD
- EXISTING FREEWAY
- 60' BUS

SCALE: 1"=200'

SCALE: 1"=200'

0 100 200
600

NOT FOR CONSTRUCTION

0	1/03				SOLICITATION LEVEL		
REV	DATE	BY	APP	REG NO	EXPIRES	SEAL HOLDER	DESCRIPTION

DESIGNED BY JAF	DRAWN BY JAF
CHECKED BY MT.	IN CHARGE RRH
DATE 1/03	DATE 1/03

LOS ANGELES COUNTY METROPOLITAN TRANSPORTATION AUTHORITY
SAN FERNANDO VALLEY NORTH-SOUTH TRANSITWAY CORRIDOR M.I.S.


MEYER, MOHADDES ASSOCIATES, INC
707 WILSHIRE BLVD., SUITE 4810
LOS ANGELES, CA 90017

 Hernandez, Kroone & Associates, Inc.
CONSULTING ENGINEERS —
PLANNING - DESIGN - SURVEYING
234 DRAKE DRIVE
SAN BERNARDINO, CA 92408
(909) 884-3222 FAX (909) 383-1577

VAN NUYS BLVD CORRIDOR
VENTURA BLVD TO FOOTHILL BLVD

CONTRACT NO
PS4350-1018
DRAWING NO
REV
0
SCALE
1"=200'
SHEET NO
6 OF 14

MATCH LINE SEE SHEET 6

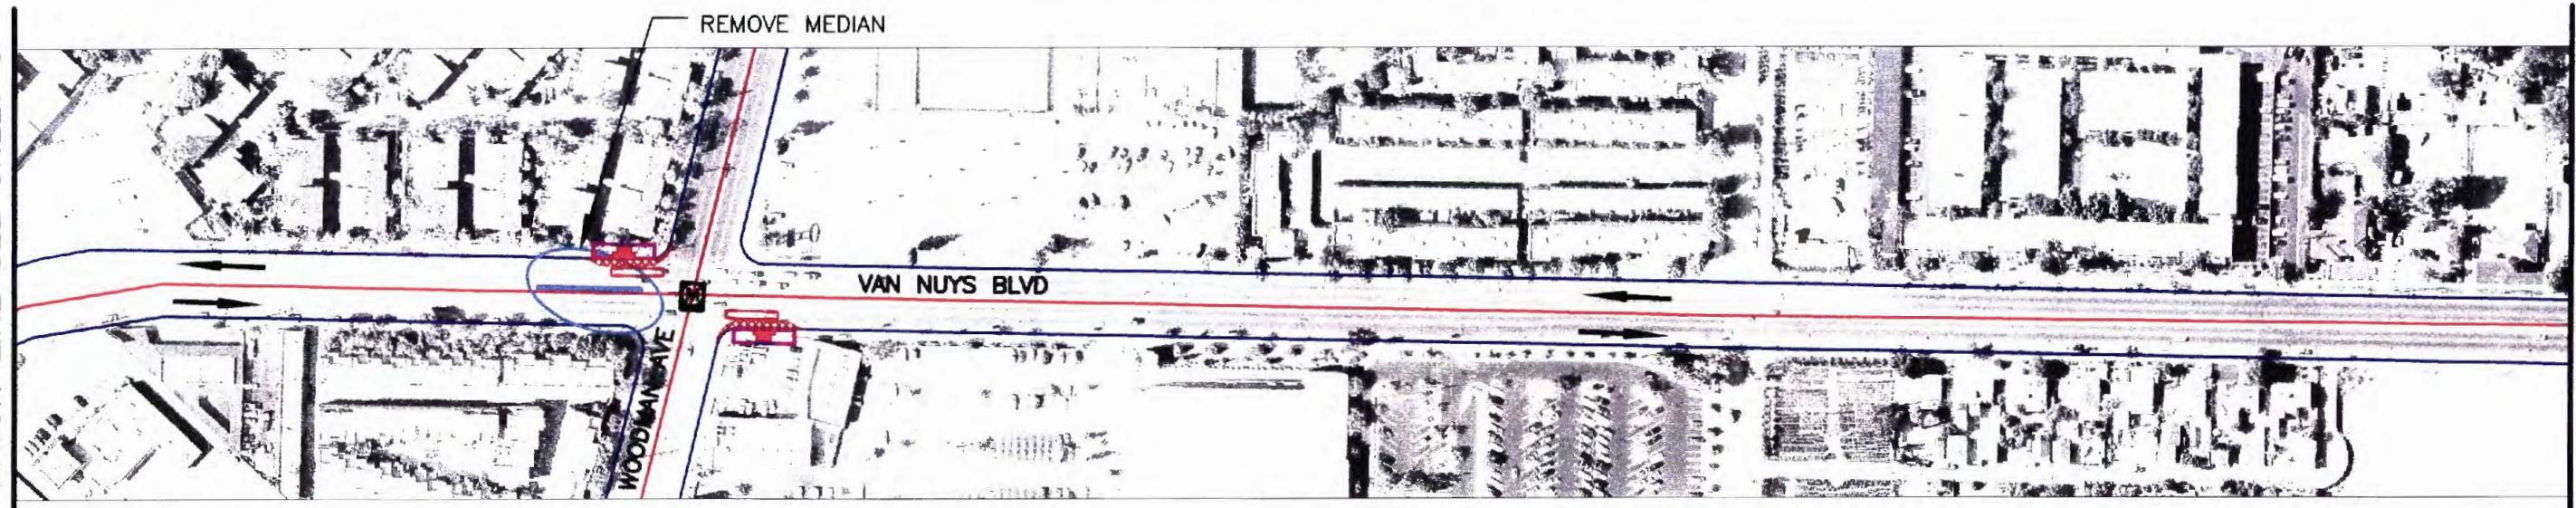


MATCH LINE SEE BELOW LEFT

MATCH LINE SEE ABOVE RIGHT



MATCH LINE SEE SHEET 8

SCALE: 1"=200'

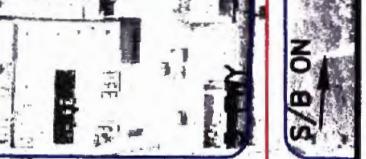

LEGEND:

- STATION LOCATION
- MAIN DIRECTION OF FLOW
- STOP LOCATION
- EXISTING ELEMENT
- PROPOSED BUS STATION
- INDICATES POP-OUT
- EXISTING STREETS
- EXISTING RIVER/WASH
- FUTURE EAST-WEST METRO RAPID TRANSITWAY
- EXISTING FREEWAY
- SIGNAL MODIFICATION
- BRIDGE WIDENING
- EXISTING RAILROAD
- 60' BUS

SCALE: 1"=200'



NOT FOR CONSTRUCTION

0	1/03						
REV	DATE	BY	APP	REG NO	EXPIRES	SEAL HOLDER	SOLICITATION LEVEL
							DESCRIPTION

DESIGNED BY JAF
DRAWN BY JAF
CHECKED BY MT.
IN CHARGE RRH
DATE 1/03



LOS ANGELES COUNTY METROPOLITAN TRANSPORTATION AUTHORITY
SAN FERNANDO VALLEY NORTH-SOUTH TRANSITWAY CORRIDOR M.I.S.

MEYER, MOHADDES ASSOCIATES, INC.
707 WILSHIRE BLVD., SUITE 4810
LOS ANGELES, CA 90017


HKA
Hernandez, Kroene
& Associates, Inc.
CONSULTING ENGINEERS —
PLANNING DESIGN SURVEYING
234 DRAKE DRIVE
SAN BERNARDINO, CA 92408
(909) 864-3222 FAX (909) 383-1577

VAN NUYS BLVD CORRIDOR
VENTURA BLVD TO FOOTHILL BLVD

CONTRACT NO PS4350-1018
DRAWING NO
REV 0
SCALE 1"=200'

SHEET NO
7 OF 14

MATCH LINE SEE SHEET 7

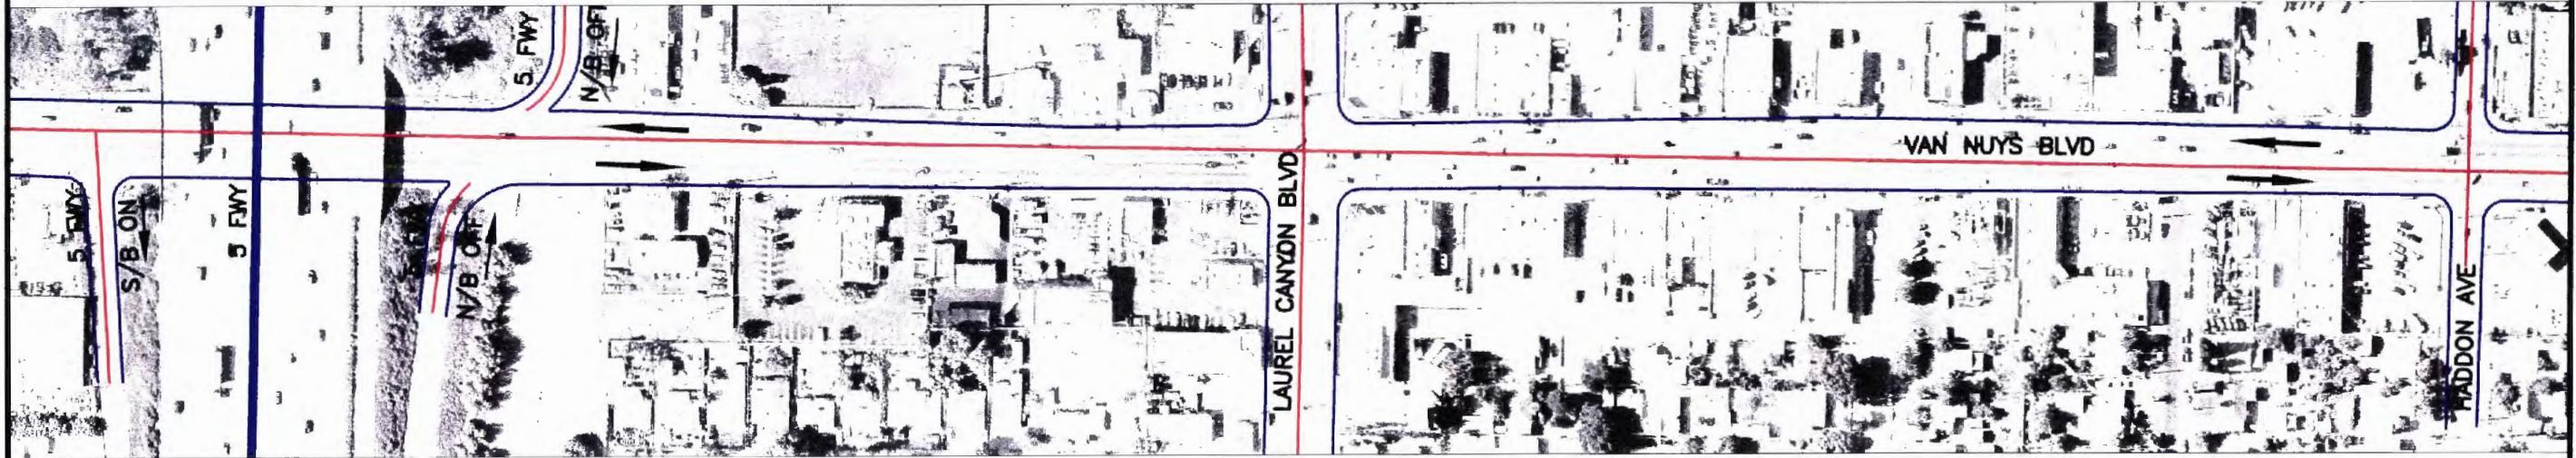

MATCH LINE SEE BELOW LEFT

MATCH LINE SEE ABOVE RIGHT



MATCH LINE SEE SHEET 9


LEGEND:

- STATION LOCATION
- MAIN DIRECTION OF FLOW
- STOP LOCATION
- EXISTING ELEMENT
- PROPOSED BUS STATION
- INDICATES POP-OUT
- EXISTING STREETS
- EXISTING RIVER/WASH
- FUTURE EAST-WEST METRO RAPID TRANSITWAY
- EXISTING FREEWAY
- SIGNAL MODIFICATION
- BRIDGE WIDENING
- EXISTING RAILROAD

SCALE: 1"=200'



SCALE: 1"=200'

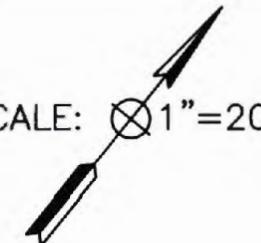

0 100 200 600

NOT FOR CONSTRUCTION

0	1/03				SOLICITATION LEVEL		
REV	DATE	BY	APP	REG NO	EXPIRES	SEAL HOLDER	DESCRIPTION

DESIGNED BY
JAF
DRAWN BY
JAF
CHECKED BY
MT.
IN CHARGE
RRH
DATE
1/03

MEYER, MOHADDES ASSOCIATES, INC
707 WILSHIRE BLVD., SUITE 4810
LOS ANGELES, CA 90017


HKA
Hernandez, Kroone
& Associates, Inc.
— CONSULTING ENGINEERS —
PLANNING - DESIGN - SURVEYING
234 DRAKE DRIVE
SAN BERNARDINO, CA 92408
(909) 884-3222 FAX (909) 383-1577

LOS ANGELES COUNTY METROPOLITAN TRANSPORTATION AUTHORITY
SAN FERNANDO VALLEY NORTH-SOUTH TRANSITWAY CORRIDOR M.I.S.

VAN NUYS BLVD CORRIDOR
VENTURA BLVD TO FOOTHILL BLVD

CONTRACT NO
PS4350-1018
DRAWING NO
REV
0
SCALE
1"=200'
SHEET NO
8 OF 14

MATCH LINE SEE SHEET 8

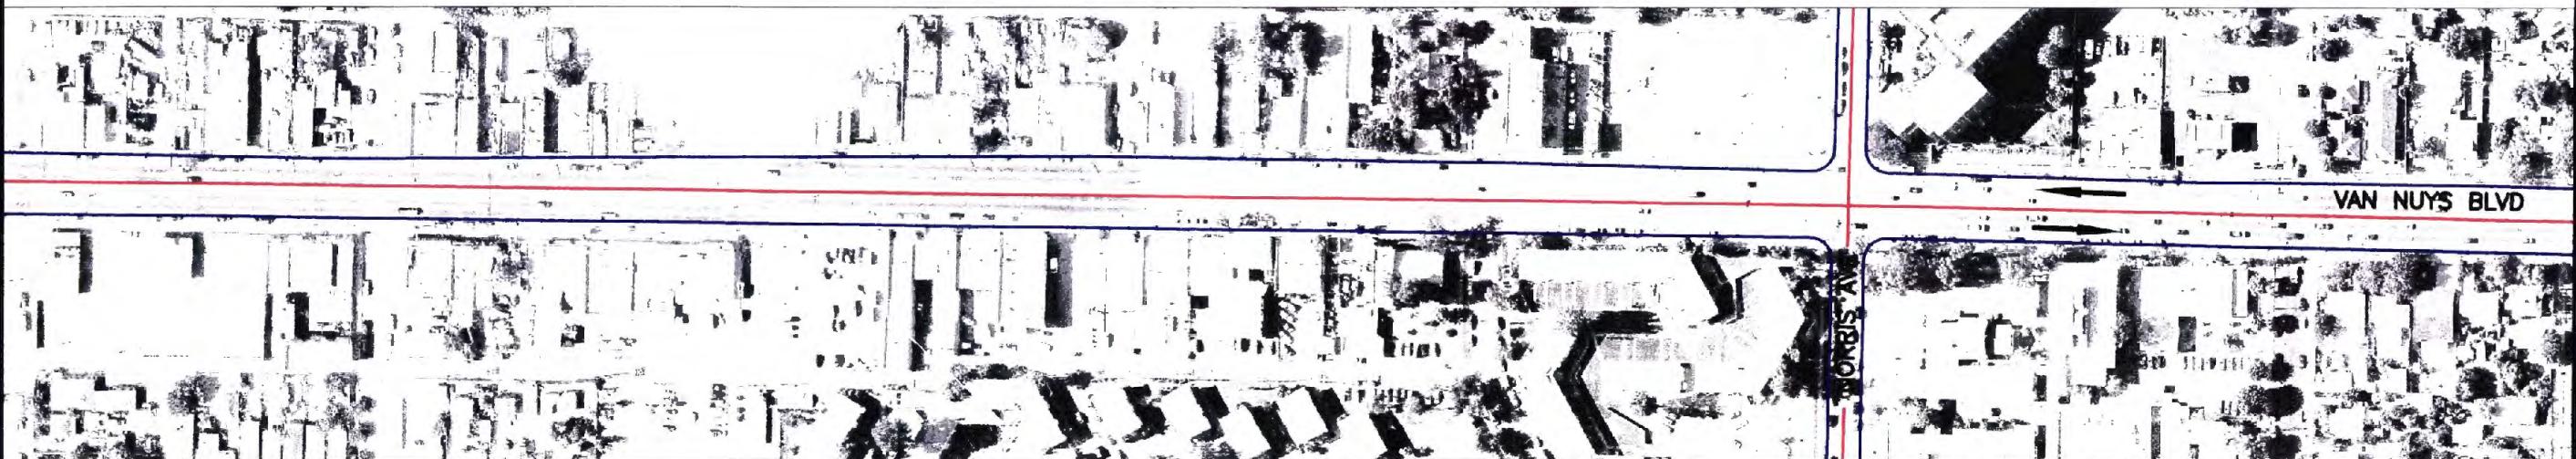

VAN NUYS BLVD

MATCH LINE SEE BELOW LEFT

MATCH LINE SEE ABOVE RIGHT



VAN NUYS BLVD

MATCH LINE SEE SHEET 10

SCALE: 1"=200'

LEGEND:

- STATION LOCATION MAIN DIRECTION OF FLOW
- STOP LOCATION EXISTING ELEMENT
- PROPOSED BUS STATION INDICATES POP-OUT
- EXISTING STREETS SIGNAL MODIFICATION
- EXISTING RIVER/WASH BRIDGE WIDENING
- FUTURE EAST-WEST METRO RAPID TRANSITWAY EXISTING RAILROAD
- EXISTING FREEWAY

SCALE: 1"=200'


0 100 200 600

NOT FOR CONSTRUCTION

0	1/03																							
REV	DATE	BY	APP	REQ NO	EXPIRES	SEAL HOLDER		SOLICITATION LEVEL		DESCRIPTION														

DESIGNED BY
DRAWN BY
CHECKED BY
IN CHARGE
DATE

JAF
JAF
MT.
RRH
1/03

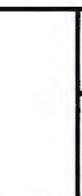


LOS ANGELES COUNTY METROPOLITAN TRANSPORTATION AUTHORITY
SAN FERNANDO VALLEY NORTH-SOUTH TRANSITWAY CORRIDOR M.I.S.
MEYER, MOHADDES ASSOCIATES, INC
707 WILSHIRE BLVD., SUITE 4810
LOS ANGELES, CA 90017

H K & Associates, Inc.
CONSULTING ENGINEERS —
PLANNING — DESIGN — SURVEYING
234 DRAKE DRIVE
SAN BERNARDINO, CA 92408
(909) 884-3222 FAX (909) 383-1577

VAN NUYS BLVD CORRIDOR
VENTURA BLVD TO FOOTHILL BLVD

CONTRACT NO
PS4350-1018
DRAWING NO
REV
0
SCALE
1"=200'
SHEET NO
9 OF 14


MATCH LINE SEE SHEET 11

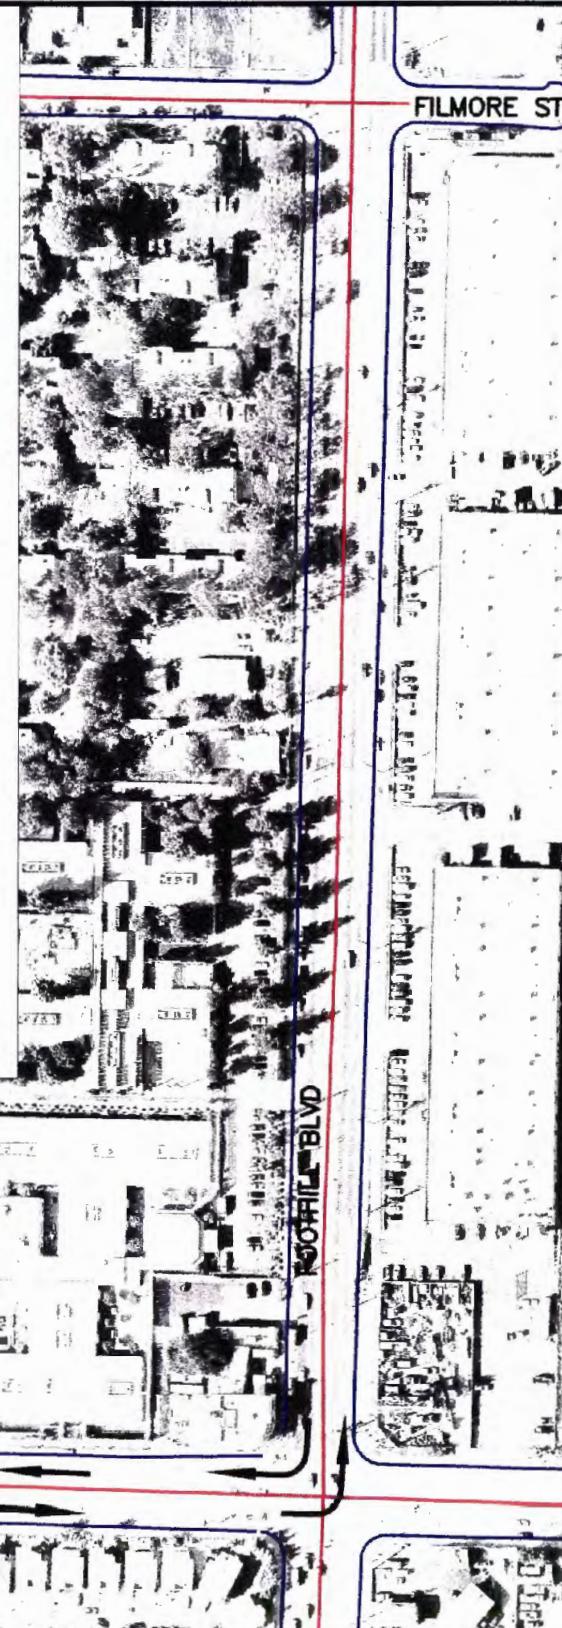

LEGEND:

	STATION LOCATION
	STOP LOCATION
	PROPOSED BUS STATION
	EXISTING STREETS
	EXISTING RIVER/WASH
	FUTURE EAST-WEST METRO RAPID TRANSITWAY
	EXISTING FREEWAY
	MAIN DIRECTION OF FLOW
	EXISTING ELEMENT
	INDICATES POP-OUT
	SIGNAL MODIFICATION
	BRIDGE WIDENING
	EXISTING RAILROAD

MATCH LINE SEE SHEET 9

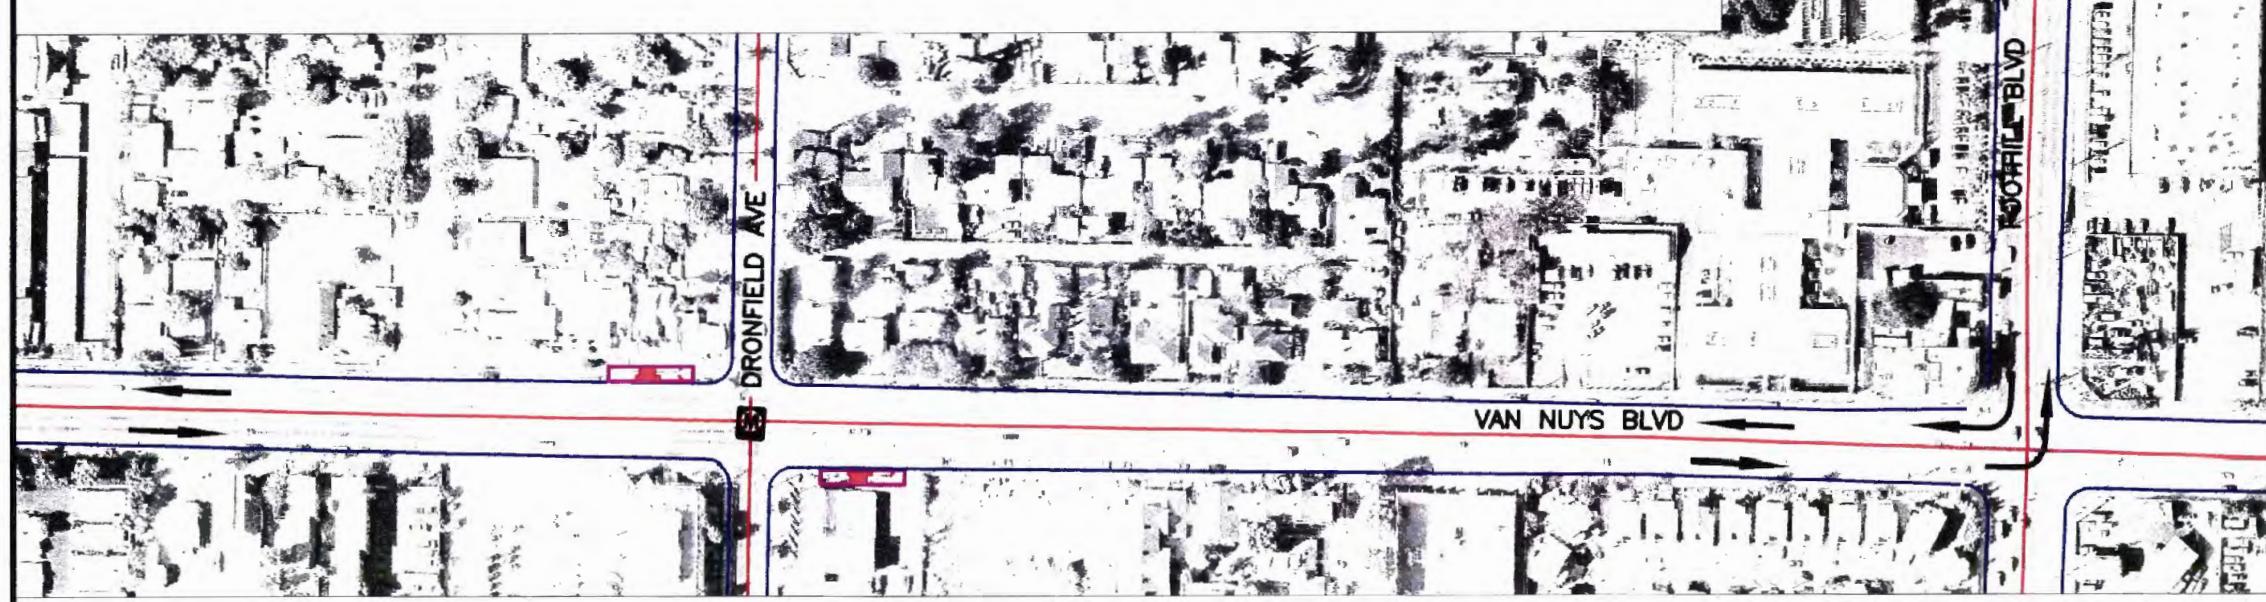

SCALE: 1"=200'


0 100 200 600

NOT FOR CONSTRUCTION

DESIGNED BY JAF	DRAWN BY JAF	CHECKED BY MT.	IN CHARGE RRH	DATE 1/03	REV	DATE	BY	APP	REG NO	EXPIRES	SEAL HOLDER	SOLICITATION LEVEL	DESCRIPTION	LOAN NUMBER	CONTRACT NO PS4350-1018	DRAWING NO	REV	0		
												LOS ANGELES COUNTY METROPOLITAN TRANSPORTATION AUTHORITY SAN FERNANDO VALLEY NORTH-SOUTH TRANSITWAY CORRIDOR M.I.S.			VAN NUYS BLVD CORRIDOR VENTURA BLVD TO FOOTHILL BLVD			PLANNING DESIGN SURVEYING 234 DRAKE DRIVE SAN BERNARDINO, CA 92408 (909) 864-3222 FAX (909) 383-1577		
MEYER, MOHADDES ASSOCIATES, INC. 707 WILSHIRE BLVD., SUITE 4810 LOS ANGELES, CA 90017															Hernandez, Kroone & Associates, Inc. CONSULTING ENGINEERS					
DATE 1/03												DATE 1/03			SCALE 1"=200'			SHEET NO 10 OF 14		


MATCH LINE SEE ABOVE RIGHT

MATCH LINE SEE SHEET 10

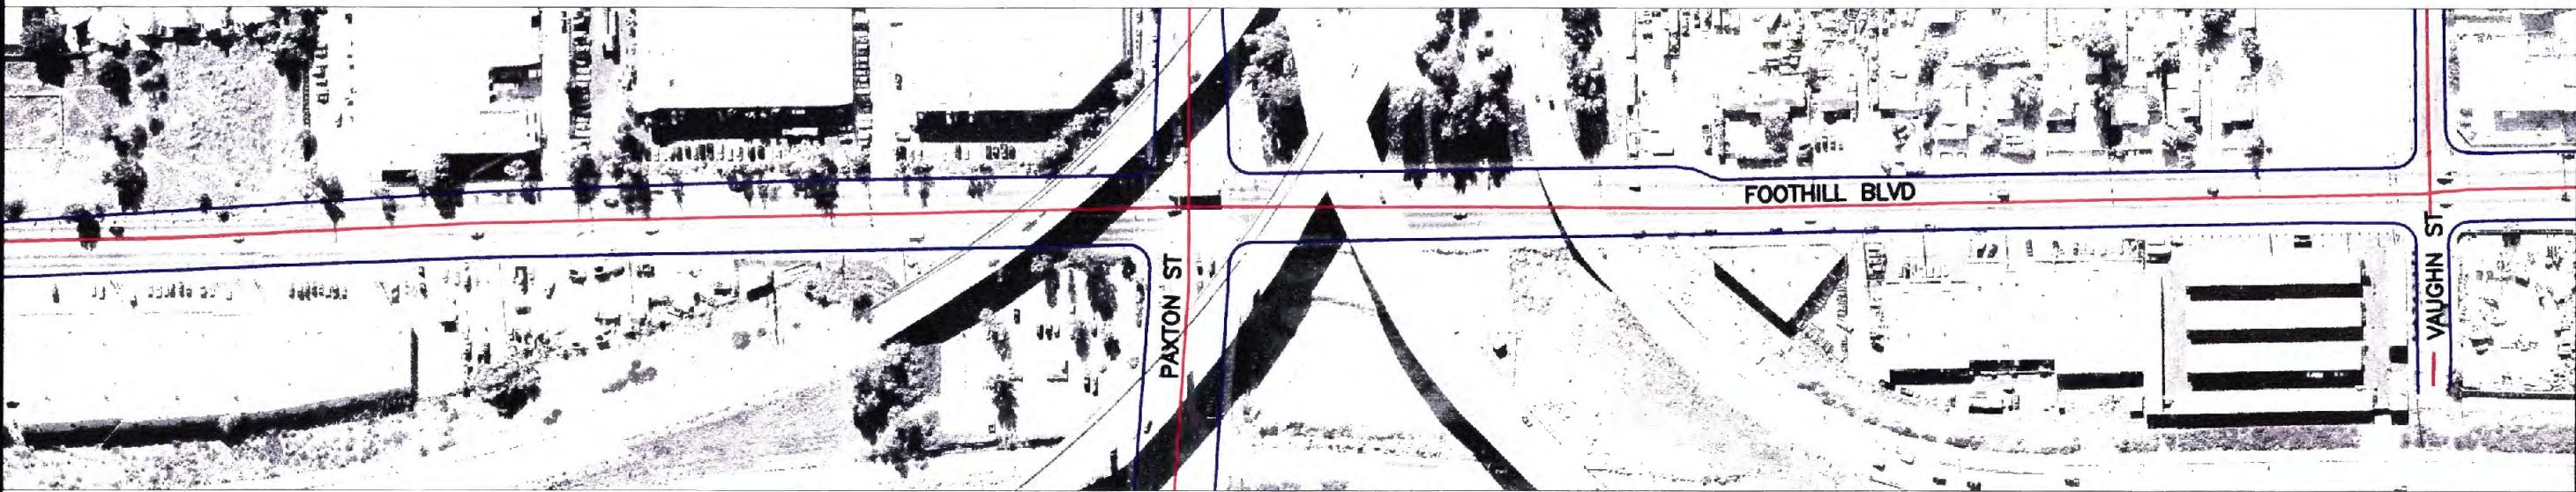

MATCH LINE SEE BELOW LEFT

SCALE: 1"=200'

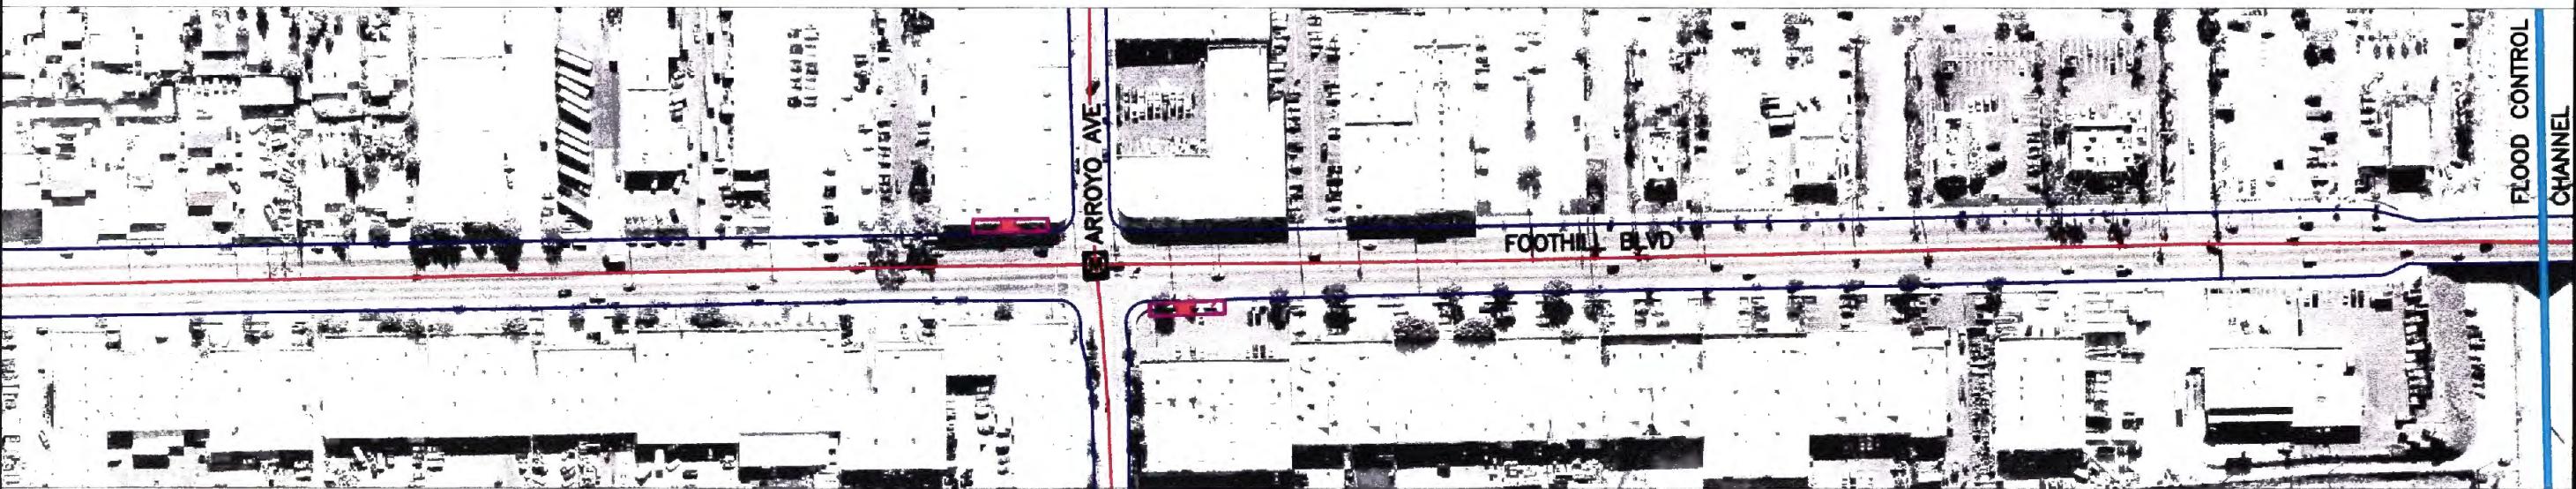

MATCH LINE SEE SHEET 12

SCALE: 1"=200'

LEGEND:

- | | | | |
|--|-----------------------------------------|--|------------------------|
| | STATION LOCATION | | MAIN DIRECTION OF FLOW |
| | STOP LOCATION | | EXISTING ELEMENT |
| | PROPOSED BUS STATION | | INDICATES POP-OUT |
| | EXISTING STREETS | | SIGNAL MODIFICATION |
| | EXISTING RIVER/WASH | | BRIDGE WIDENING |
| | FUTURE EAST-WEST METRO RAPID TRANSITWAY | | EXISTING RAILROAD |
| | EXISTING FREEWAY | | |

0 100 200 600

NOT FOR CONSTRUCTION

0	1/03				SOLICITATION LEVEL		
REV	DATE	BY	APP	REG NO	EXPIRES	SEAL HOLDER	DESCRIPTION

DESIGNED BY
JAF
DRAWN BY
JAF
CHECKED BY
MT.
IN CHARGE
RRH
DATE
1/03

LOS ANGELES COUNTY METROPOLITAN TRANSPORTATION AUTHORITY
SAN FERNANDO VALLEY NORTH-SOUTH TRANSITWAY CORRIDOR M.I.S.
MEYER, MOHADDES ASSOCIATES, INC
707 WILSHIRE BLVD., SUITE 4810
LOS ANGELES, CA 90017

HKA Hernandez, Kroone & Associates, Inc.
CONSULTING ENGINEERS — PLANNING - DESIGN - SURVEYING
234 DRAKE DRIVE SAN BERNARDINO, CA 92408
(909) 864-3222 FAX (909) 383-1577

VAN NUYS BLVD CORRIDOR
FOOTHILL BLVD
VAN NUYS BLVD TO HUBBARD ST

CONTRACT NO
PS4350-1018
DRAWING NO REV
0
SCALE
1"=200'
SHEET NO
11 OF 14

MATCH LINE SEE ABOVE RIGHT

MATCH LINE SEE SHEET 11



SCALE: 1"=200'

MATCH LINE SEE SHEET 13



SCALE: 1"=200'

LEGEND:

- STATION LOCATION
- MAIN DIRECTION OF FLOW
- STOP LOCATION
- EXISTING ELEMENT
- PROPOSED BUS STATION
- INDICATES POP-OUT
- EXISTING STREETS
- SIGNAL MODIFICATION
- EXISTING RIVER/WASH
- BRIDGE WIDENING
- FUTURE EAST-WEST METRO RAPID TRANSITWAY
- EXISTING RAILROAD
- EXISTING FREEWAY

0 100 200
600

NOT FOR CONSTRUCTION

D	1/03						
REV	DATE	BY	APP	REQ NO	EXPIRES	SEAL HOLDER	SOLICITATION LEVEL

DESIGNED BY JAF
DRAWN BY JAF
CHECKED BY MT.
IN CHARGE RRH
DATE 1/03

LOS ANGELES COUNTY METROPOLITAN TRANSPORTATION AUTHORITY
SAN FERNANDO VALLEY NORTH-SOUTH TRANSITWAY CORRIDOR M.I.S.
MEYER, MOHADDES ASSOCIATES, INC. 707 WILSHIRE BLVD., SUITE 4810
LOS ANGELES, CA 90017

H K A
Hernandez, Kroone & Associates, Inc.
CONSULTING ENGINEERS
PLANNING - DESIGN - SURVEYING
234 DRAKE DRIVE
SAN BERNARDINO, CA 92408
(909) 884-3222 FAX (909) 383-1577

VAN NUYS BLVD CORRIDOR
FOOTHILL BLVD
VAN NUYS BLVD TO HUBBARD ST

CONTRACT NO
PS4350-1018
DRAWING NO
REV 0
SCALE
1"=200'
SHEET NO
12 OF 14

MATCH LINE SEE ABOVE RIGHT




MATCH LINE SEE BELOW LEFT

SCALE: 1"=200'

LEGEND:

	STATION LOCATION		LANDSCAPE MEDIAN
	STOP LOCATION		EXISTING FREEWAY
	PROPOSED BUS STATION		MAIN DIRECTION OF FLOW
	EXISTING STREETS		EXISTING ELEMENT
	EXISTING RIVER/WASH		INDICATES POP-OUT
	FUTURE EAST-WEST METRO RAPID TRANSITWAY		

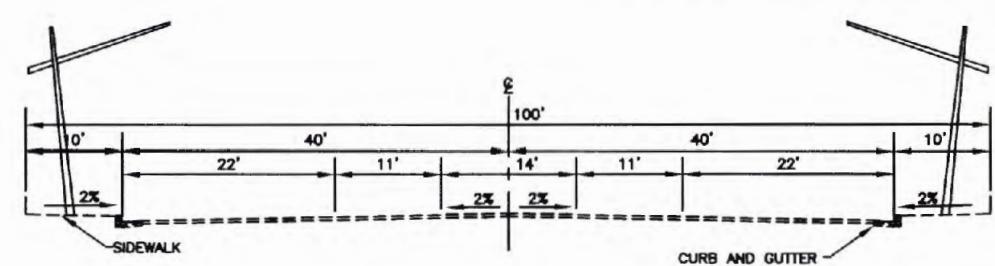

0 100 200 600

NOT FOR CONSTRUCTION

0	1/03				SOLICITATION LEVEL				
REV	DATE	BY	APP	REQ NO	EXPIRES	SEAL HOLDER			

DESIGNED BY JAF	DRAWN BY JAF	CHECKED BY MT.	IN CHARGE RRH	DATE 1/03


LOS ANGELES COUNTY METROPOLITAN TRANSPORTATION AUTHORITY
SAN FERNANDO VALLEY NORTH-SOUTH TRANSITWAY CORRIDOR M.I.S.
MEYER, MOHADDES ASSOCIATES, INC. 707 WILSHIRE BLVD., SUITE 4810
LOS ANGELES, CA 90017 Hernandez, Kroone & Associates, Inc.
CONSULTING ENGINEERS — PLANNING - DESIGN - SURVEYING
234 DRAKE DRIVE SAN BERNARDINO, CA 92408
(909) 884-3222 FAX (909) 383-1577

RESEDA BLVD CORRIDOR
VENTURA BLVD TO NORDHOFF ST

CONTRACT NO PS4350-1018	DRAWING NO	REV
		0
SCALE 1"=200'		
SHEET NO		1 OF 15

MATCH LINE SEE ABOVE RIGHT

MATCH LINE SEE SHEET 1

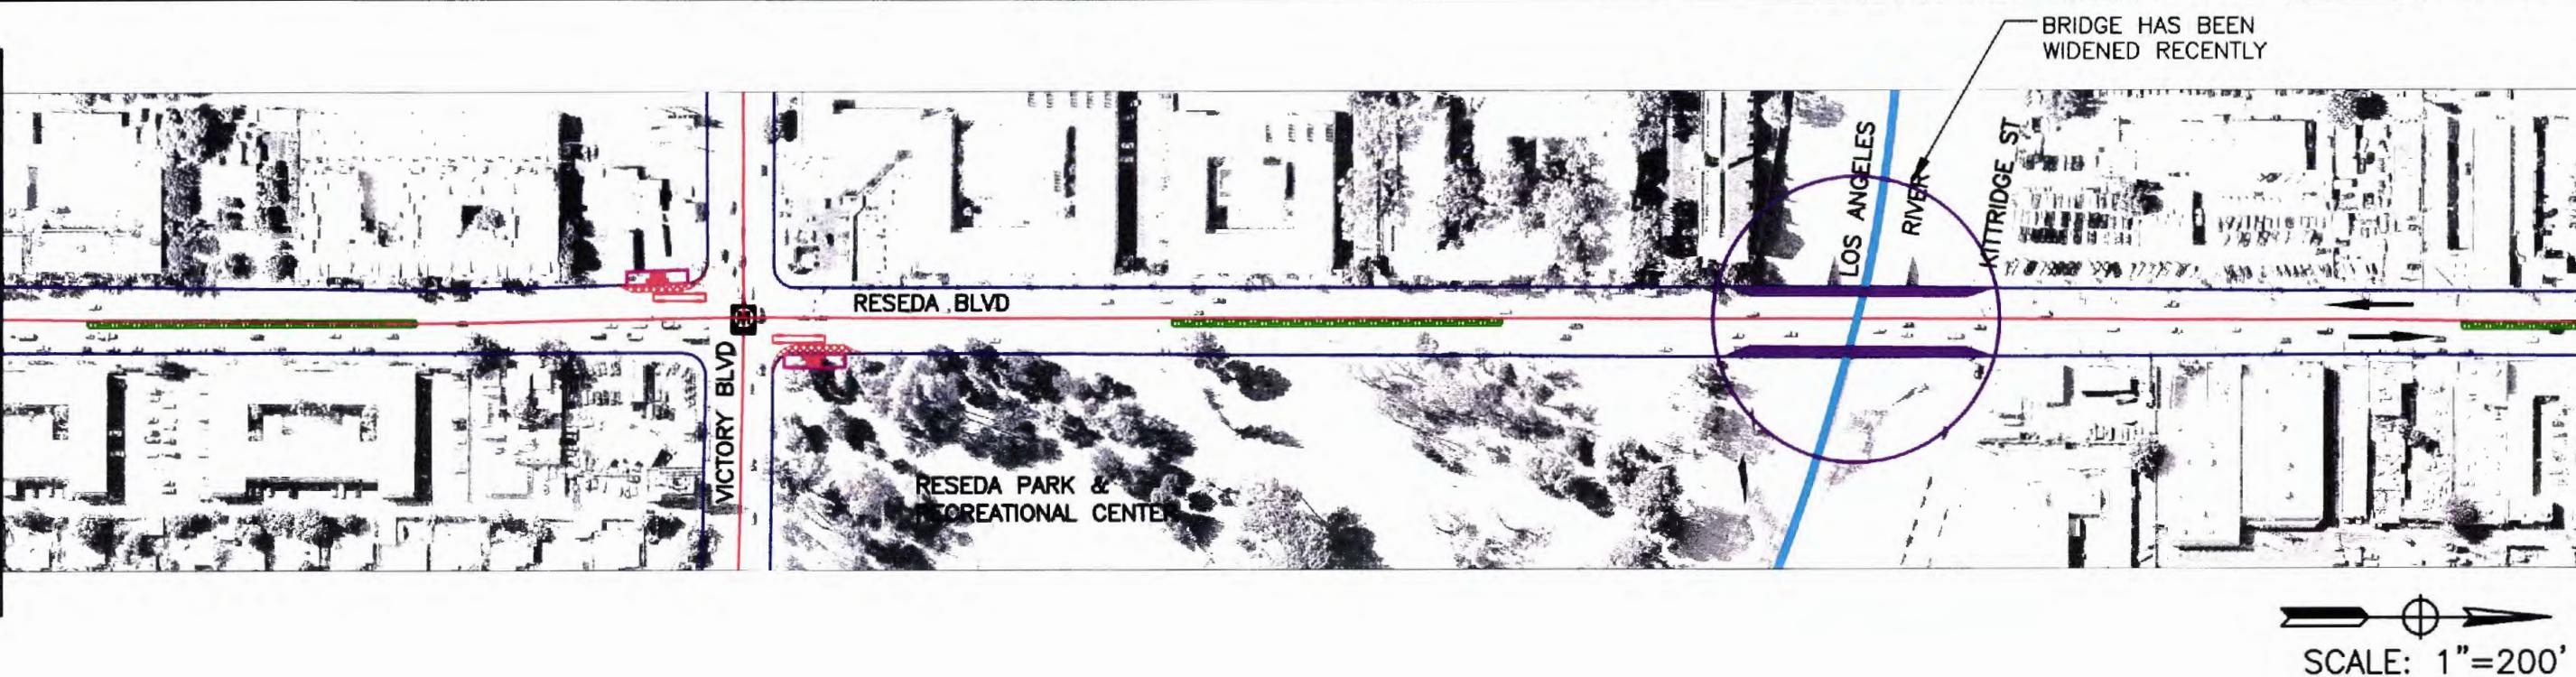

MATCH LINE SEE SHEET 3



LEGEND:

- | | | | |
|--|-----------------------------------------|--|------------------------|
| | STATION LOCATION | | LANDSCAPE MEDIAN |
| | STOP LOCATION | | EXISTING FREEWAY |
| | PROPOSED BUS STATION | | MAIN DIRECTION OF FLOW |
| | EXISTING STREETS | | EXISTING ELEMENT |
| | EXISTING RIVER/WASH | | INDICATES POP-OUT |
| | FUTURE EAST-WEST METRO RAPID TRANSITWAY | | 60' BUS |

0 100 200 600


NOT FOR CONSTRUCTION

										DESIGNED BY JAF	HKA CONSULTING ENGINEERS — PLANNING DESIGN SURVEYING 234 DRAKE DRIVE SAN BERNARDINO, CA 92408 (909) 884-3222 FAX (909) 383-1577	RESEDA BLVD CORRIDOR VENTURA BLVD TO NORDHOFF ST		CONTRACT NO PS4350-1018
										DRAWN BY JAF		LOS ANGELES COUNTY METROPOLITAN TRANSPORTATION AUTHORITY SAN FERNANDO VALLEY NORTH-SOUTH TRANSITWAY CORRIDOR M.I.S.		DRAWING NO
										CHECKED BY MT.		MEYER, MOHADDES ASSOCIATES, INC 707 WILSHIRE BLVD., SUITE 4810 LOS ANGELES, CA 90017		REV
										IN CHARGE RRH		Hernandez, Kroone & Associates, Inc. CONSULTING ENGINEERS — PLANNING DESIGN SURVEYING 234 DRAKE DRIVE SAN BERNARDINO, CA 92408 (909) 884-3222 FAX (909) 383-1577		SCALE 1"=200'
										DATE 1/03				SHEET NO 2 OF 15
REV	DATE	BY	APP	REG NO	EXPIRES	SEAL HOLDER	SOLICITATION LEVEL			DESCRIPTION				
0	1/03													

MATCH LINE SEE ABOVE RIGHT

MATCH LINE SEE SHEET 2

QUEUE JUMP SIGNAL
SOUTH BOUND

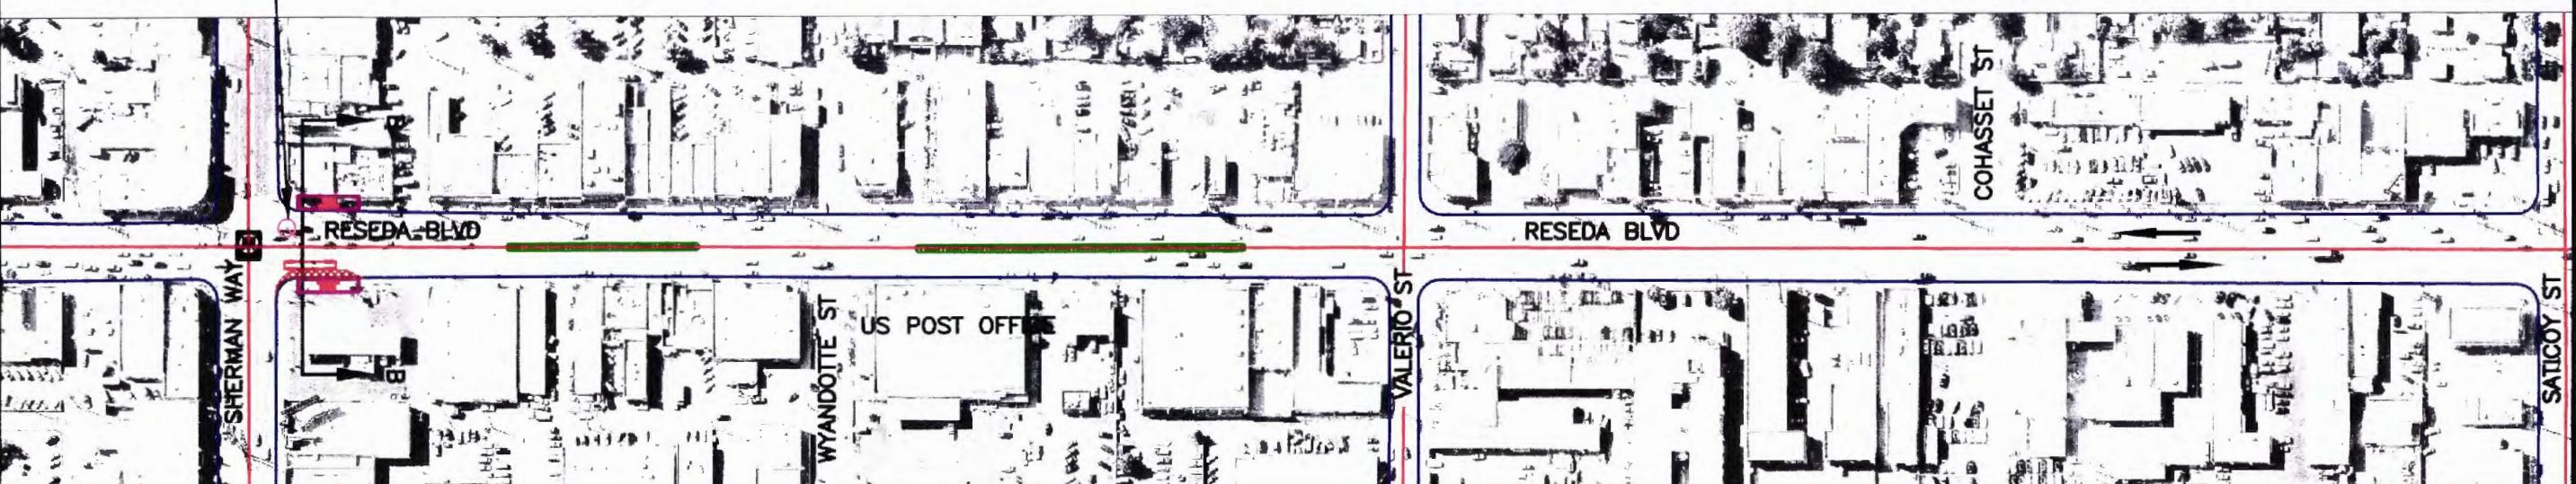

MATCH LINE SEE BELOW LEFT

SCALE: 1"=200'

MATCH LINE SEE ABOVE RIGHT

MATCH LINE SEE SHEET 2

QUEUE JUMP SIGNAL
SOUTH BOUND




MATCH LINE SEE SHEET 4

SCALE: 1"=200'

LEGEND:

- [M] STATION LOCATION
- [Solid pink bar] STOP LOCATION
- [Proposed bus station icon] PROPOSED BUS STATION
- [Red dashed line] EXISTING STREETS
- [Queue jump icon] QUEUE JUMP
- [Future east-west metro rapid transitway icon] FUTURE EAST-WEST METRO RAPID TRANSITWAY
- [Landscape median icon] LANDSCAPE MEDIAN
- [Existing freeway icon] EXISTING FREEWAY
- [Main direction of flow arrow] MAIN DIRECTION OF FLOW
- [Dashed line] EXISTING ELEMENT
- [Indicates pop-out icon] INDICATES POP-OUT
- [60' bus icon] 60' BUS

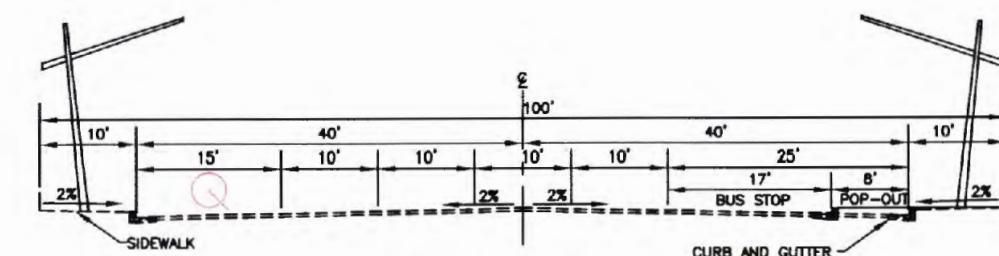

CROSS SECTION B-B

0 100 200 600

NOT FOR CONSTRUCTION

SOLICITATION LEVEL									
0	1/03								
REV	DATE	BY	APP	REG NO	EXPIRES	SEAL HOLDER			

DESIGNED BY JAF	
DRAWN BY JAF	
CHECKED BY MT.	
IN CHARGE RRH	
DATE 1/03	
DESCRIPTION	

LOS ANGELES COUNTY METROPOLITAN TRANSPORTATION AUTHORITY
SAN FERNANDO VALLEY NORTH-SOUTH TRANSITWAY CORRIDOR M.I.S.
MEYER, MOHADDES ASSOCIATES, INC. 707 WILSHIRE BLVD., SUITE 4810
LOS ANGELES, CA 90017


H K A Hernandez, Kroone & Associates, Inc.
CONSULTING ENGINEERS — PLANNING DESIGN SURVEYING
234 DRAKE DRIVE SAN BERNARDINO, CA 92408
(909) 884-3222 FAX (909) 383-1577

RESEDA BLVD CORRIDOR
VENTURA BLVD TO NORDHOFF ST

CONTRACT NO
PS4350-1018
DRAWING NO
REV 0
SCALE
1"=200'
SHEET NO
3 OF 15

MATCH LINE SEE ABOVE RIGHT

MATCH LINE SEE SHEET 3

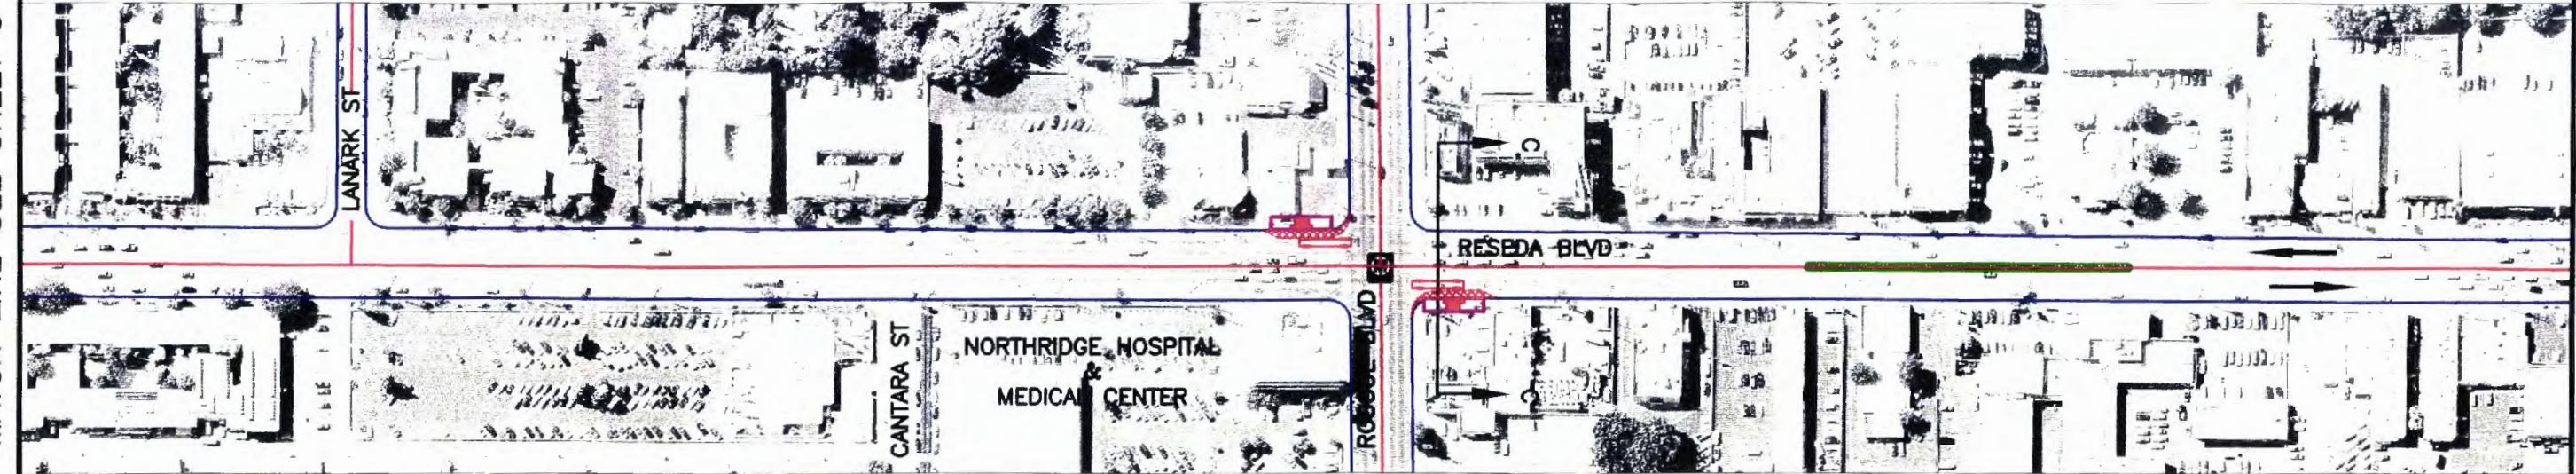

MATCH LINE SEE BELOW LEFT


SCALE: 1"=200'



MATCH LINE SEE SHEET 5

LEGEND:

- M** STATION LOCATION
- LANDSCAPE MEDIAN
- STOP LOCATION
- EXISTING FREEWAY
- PROPOSED BUS STATION
- MAIN DIRECTION OF FLOW
- EXISTING STREETS
- EXISTING ELEMENT
- EXISTING RAILROAD
- INDICATES POP-OUT
- FUTURE EAST-WEST METRO RAPID TRANSITWAY
- 60' BUS

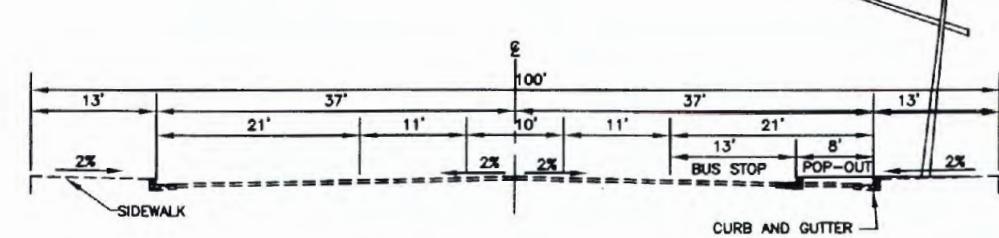

CROSS SECTION C-C
NTS

0 100 200 600

NOT FOR CONSTRUCTION

DESIGNED BY JAF	DRAWN BY JAF	CHECKED BY MT.	IN CHARGE RRH				
0 1/03				SOLICITATION LEVEL			
REV	DATE	BY	APP	REG NO.	EXPIRES	SEAL HOLDER	DESCRIPTION

DESIGNED BY JAF	DRAWN BY JAF	CHECKED BY MT.	IN CHARGE RRH
0 1/03			
DATE	1/03	DESCRIPTION	

M LOS ANGELES COUNTY METROPOLITAN TRANSPORTATION AUTHORITY
SAN FERNANDO VALLEY NORTH-SOUTH TRANSITWAY CORRIDOR M.I.S.
MEYER, MOHADDES ASSOCIATES, INC
707 WILSHIRE BLVD., SUITE 4810
LOS ANGELES, CA 90017

H K A Hernandez, Kroone & Associates, Inc.
CONSULTING ENGINEERS — PLANNING — DESIGN — SURVEYING
234 DRAKE DRIVE SAN BERNARDINO, CA 92408
(909) 864-3222 FAX (909) 383-1577

RESEDA BLVD CORRIDOR
VENTURA BLVD TO NORDHOFF ST

CONTRACT NO PS4350-1018	REV
DRAWING NO	0
SCALE 1"=200'	
SHEET NO	4 OF 15

MATCH LINE SEE SHEET 4

OPTIONAL ACCESS
ROUTE TO CSUN

LEGEND:

- [M] STATION LOCATION
- [---] STOP LOCATION
- [■] PROPOSED BUS STATION
- [—] EXISTING STREETS
- [→] MAIN DIRECTION OF FLOW
- [—] OPTIONAL BUS ROUTE
- [→] OPTIONAL DIRECTION OF FLOW
- [■■■■■] INDICATES POP-OUT
- [—] LANDSCAPE MEDIAN
- [—] 60' BUS

MATCH LINE SEE SHEET 6

OPTIONAL ENTRY
ROUTE TO CSUN



0 100 200

600

SCALE: 1"=200'



NOT FOR CONSTRUCTION

								DESIGNED BY JAF
								DRAWN BY JAF
								CHECKED BY MT.
								IN CHARGE RRH
0	1/03				SOLICITATION LEVEL			DATE 1/03
REV	DATE	BY	APP	REQ NO	EXPIRES	SEAL HOLDER		DESCRIPTION

LOS ANGELES COUNTY METROPOLITAN TRANSPORTATION AUTHORITY SAN FERNANDO VALLEY NORTH-SOUTH TRANSITWAY CORRIDOR M.I.S.	MEYER, MOHADDES ASSOCIATES, INC 707 WILSHIRE BLVD., SUITE 4810 LOS ANGELES, CA 90017	HKA Hernandez, Kroone & Associates, Inc. CONSULTING ENGINEERS — PLANNING - DESIGN - SURVEYING 234 DRAKE DRIVE SAN BERNARDINO, CA 92408 (909) 884-3222 FAX (909) 383-1577	RESEDA BLVD CORRIDOR
			VENTURA BLVD TO NORDHOFF ST

CONTRACT NO PS4350-1018	REV 0
DRAWING NO	
SCALE 1"=200'	
SHEET NO 5 OF 15	

MATCH LINE SEE SHEET 5

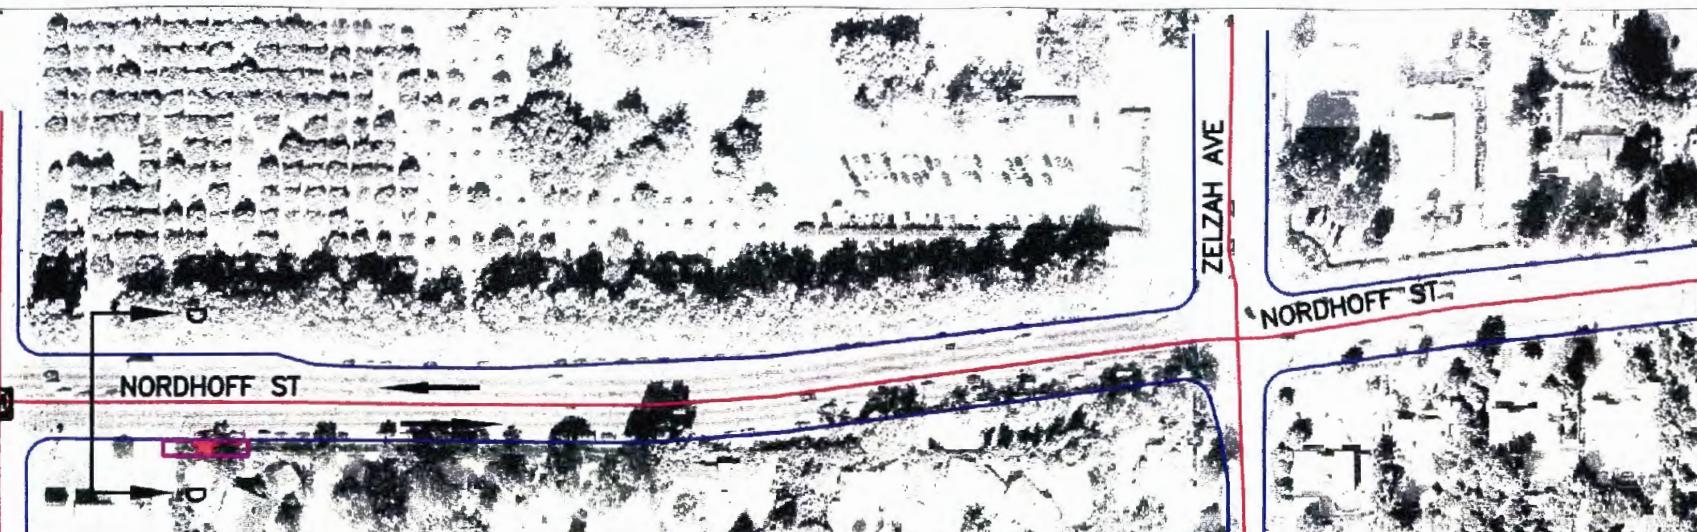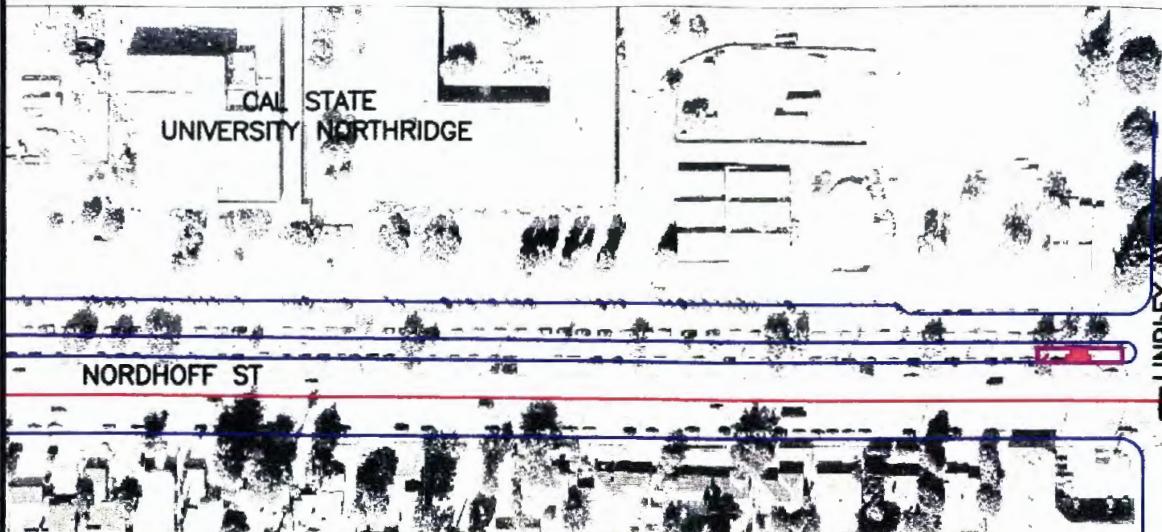

MATCH LINE SEE BELOW LEFT


MATCH LINE SEE ABOVE RIGHT



MATCH LINE SEE SHEET 7

LEGEND:

- [M] STATION LOCATION
- [Landscape Median Icon] LANDSCAPE MEDIAN
- [Pink Box] STOP LOCATION
- [Blue Line] EXISTING FREEWAY
- [Red Arrow] PROPOSED BUS STATION
- [Main Direction of Flow Arrow] MAIN DIRECTION OF FLOW
- [Red Lines] EXISTING STREETS
- [Dashed Line] EXISTING ELEMENT
- [Blue Dashed Line] EXISTING RIVER/WASH
- [Red Dashed Line] INDICATES POP-OUT
- [Red Dashed Line] FUTURE EAST-WEST METRO RAPID TRANSITWAY
- [60' Bus Icon] 60' BUS

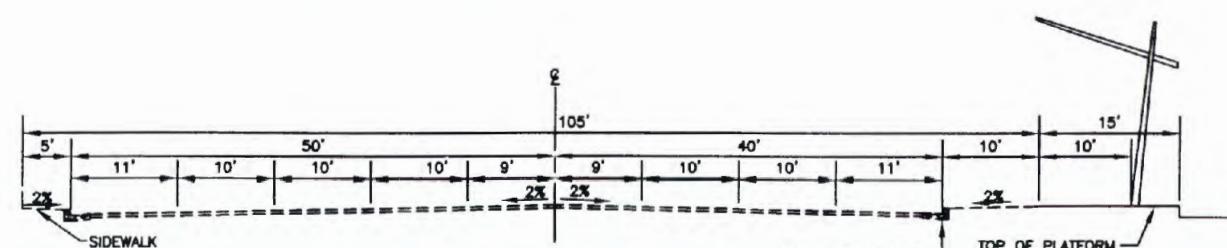

CROSS SECTION D-D

SCALE: 1"=200'

0 100 200 600

NOT FOR CONSTRUCTION

REV	DATE	BY	APP	REG NO.	EXPIRES	SEAL HOLDER	SOLICITATION LEVEL	DESCRIPTION	DESIGNED BY	JAF
0	1/03								DRAWN BY	JAF

1/03

1/03

RRH

DATE

1/03

CHECKED BY

MT.

IN CHARGE

RRH

DATE

1/03

DESIGNER

JAF

DRAFTER

JAF

CHECKER

MT.

IN CHARGE

RRH

DATE

1/03

PLANNING

BEST GH SURVEYING

CONSULTING ENGINEERS

HKA

DESIGNER

JAF

DRAFTER

JAF

CHECKER

MT.

IN CHARGE

RRH

DATE

1/03

DESIGNER

JAF

DRAFTER

JAF

CHECKER

MT.

IN CHARGE

RRH

DATE

1/03

DESIGNER

JAF

DRAFTER

JAF

CHECKER

MT.

IN CHARGE

RRH

DATE

1/03

DESIGNER

JAF

DRAFTER

JAF

CHECKER

MT.

IN CHARGE

RRH

DATE

1/03

DESIGNER

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CHECKER

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IN CHARGE

RRH

DATE

1/03

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IN CHARGE

RRH

DATE

1/03

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DATE

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IN CHARGE

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DATE

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IN CHARGE

RRH

DATE

1/03

DESIGNER

JAF

DRAFTER

JAF

CHECKER

MT.

IN CHARGE

RRH

DATE

1/03

DESIGNER

JAF

DRAFTER

JAF

CHECKER

MT.

IN CHARGE

RRH


DATE

1/03

DESIGNER


JAF

MATCH LINE SEE SHEET 6

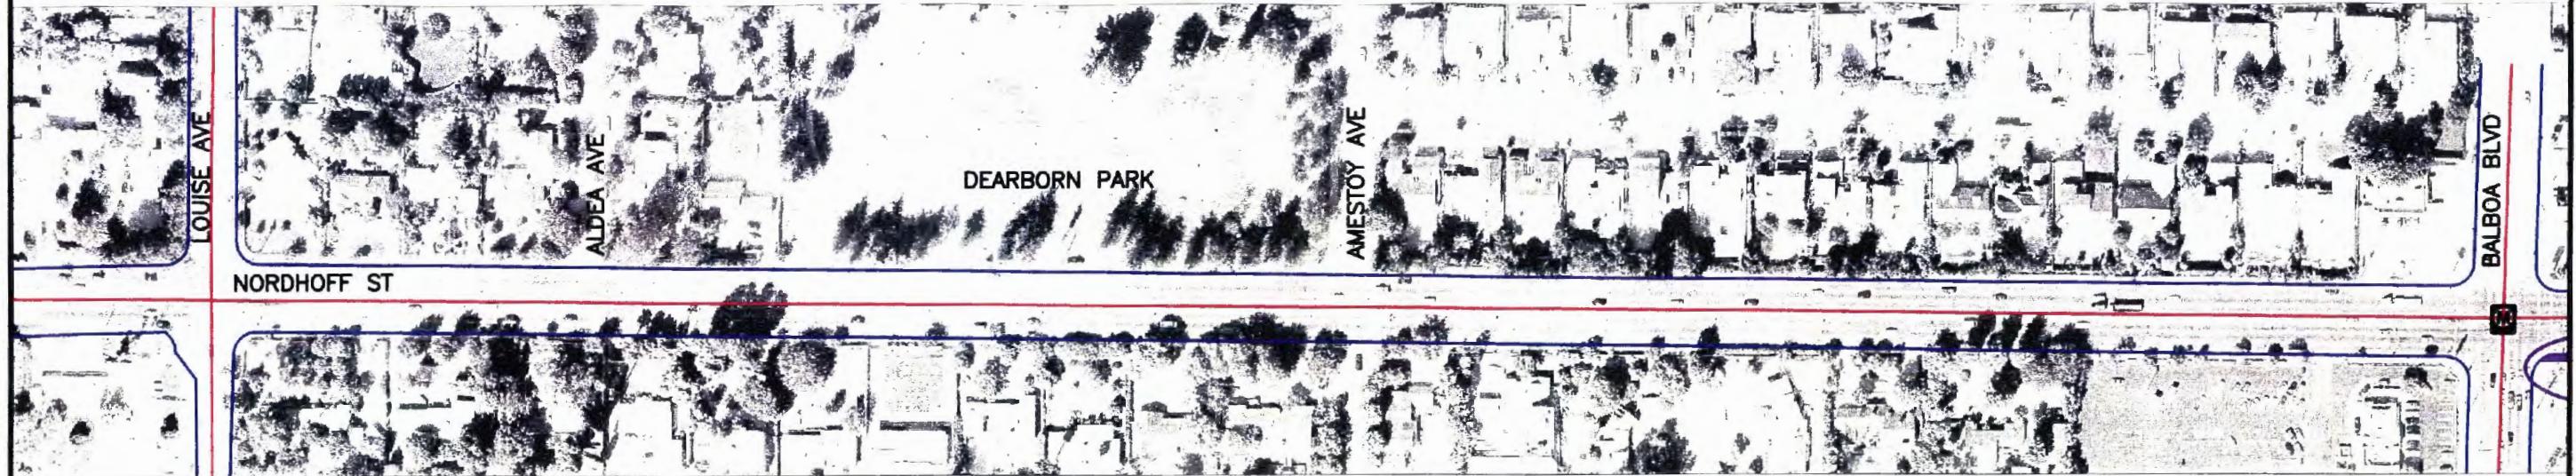

MATCH LINE SEE BELOW LEFT

MATCH LINE SEE ABOVE RIGHT

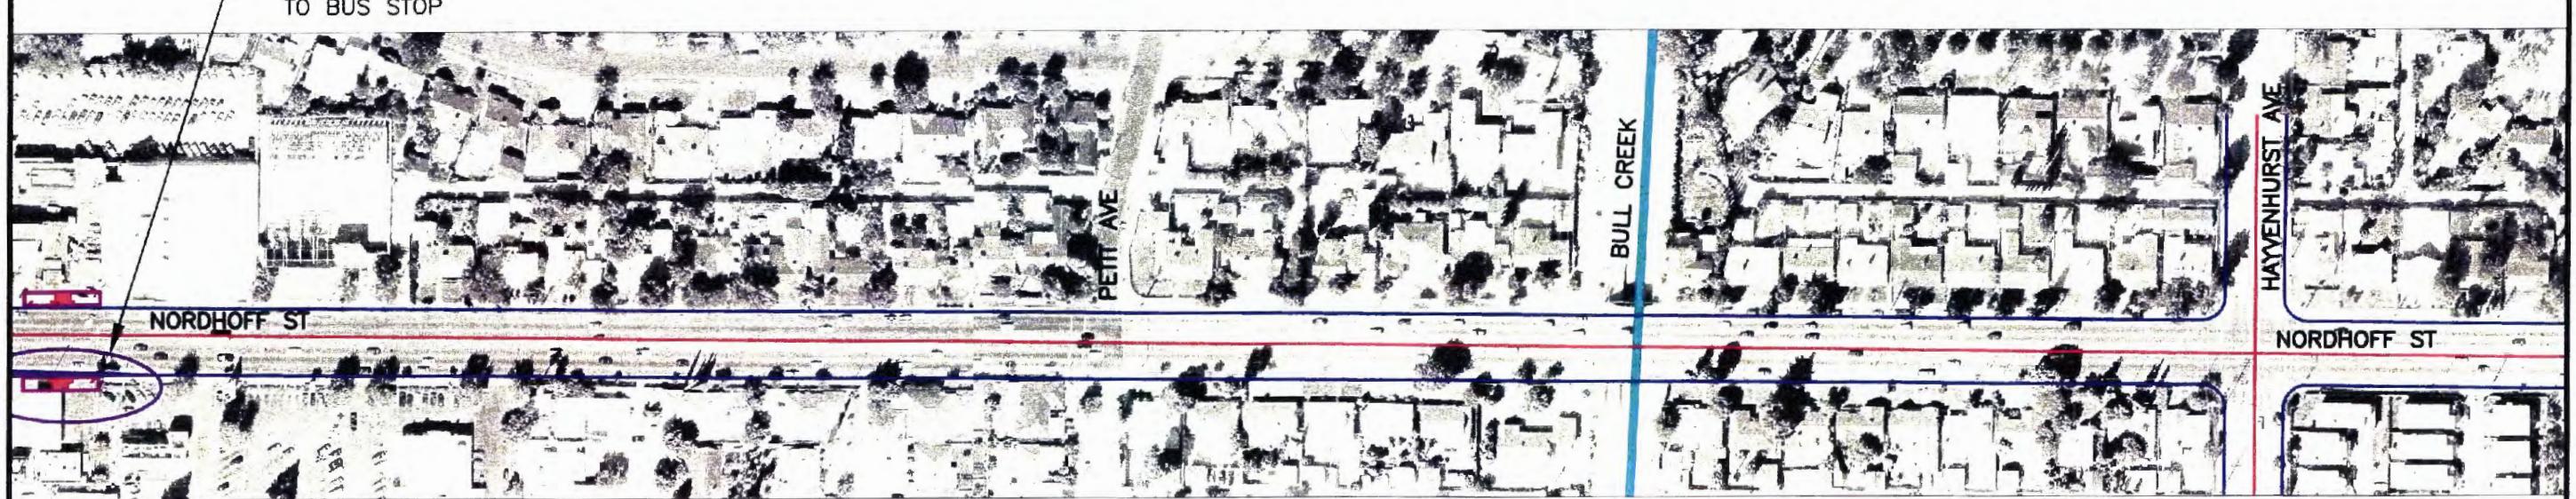

MATCH LINE SEE SHEET 8

LEGEND:

- | | | | |
|--|----------------------|--|------------------------|
| | STATION LOCATION | | LANDSCAPE MEDIAN |
| | STOP LOCATION | | EXISTING FREEWAY |
| | PROPOSED BUS STATION | | MAIN DIRECTION OF FLOW |
| | EXISTING STREETS | | EXISTING ELEMENT |
| | EXISTING RIVER/WASH | | INDICATES POP-OUT |
| | FUTURE EAST-WEST | | 60' BUS |

SCALE: 1"=200'

0 100 200 600

NOT FOR CONSTRUCTION

METRO RAPID TRANSITWAY						SOLICITATION LEVEL	
REV	DATE	BY	APP	REG NO	EXPIRES	SEAL HOLDER	DESCRIPTION

DESIGNED BY
JAF
DRAWN BY
JAF
CHECKED BY
MT.
IN CHARGE
RRH
DATE
1/03

LOS ANGELES COUNTY METROPOLITAN TRANSPORTATION AUTHORITY
SAN FERNANDO VALLEY NORTH-SOUTH TRANSITWAY CORRIDOR M.I.S.
MEYER, MOHADDES ASSOCIATES, INC
707 WILSHIRE BLVD., SUITE 4810
LOS ANGELES, CA 90017



HKA Hernandez, Kroone & Associates, Inc.
CONSULTING ENGINEERS — PLANNING - DESIGN - SURVEYING
234 DRAKE DRIVE SAN BERNARDINO, CA 92408
(909) 864-3222 FAX (909) 383-1577

RESEDA BLVD CORRIDOR
NORDHOFF ST
RESEDA BLVD TO WOODLEY AVE

CONTRACT NO
PS4350-1018
DRAWING NO
REV
0
SCALE
1"=200'
SHEET NO
7 OF 15

MATCH LINE SEE SHEET 9

MATCH LINE SEE SHEET 7

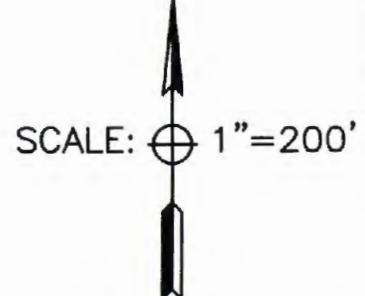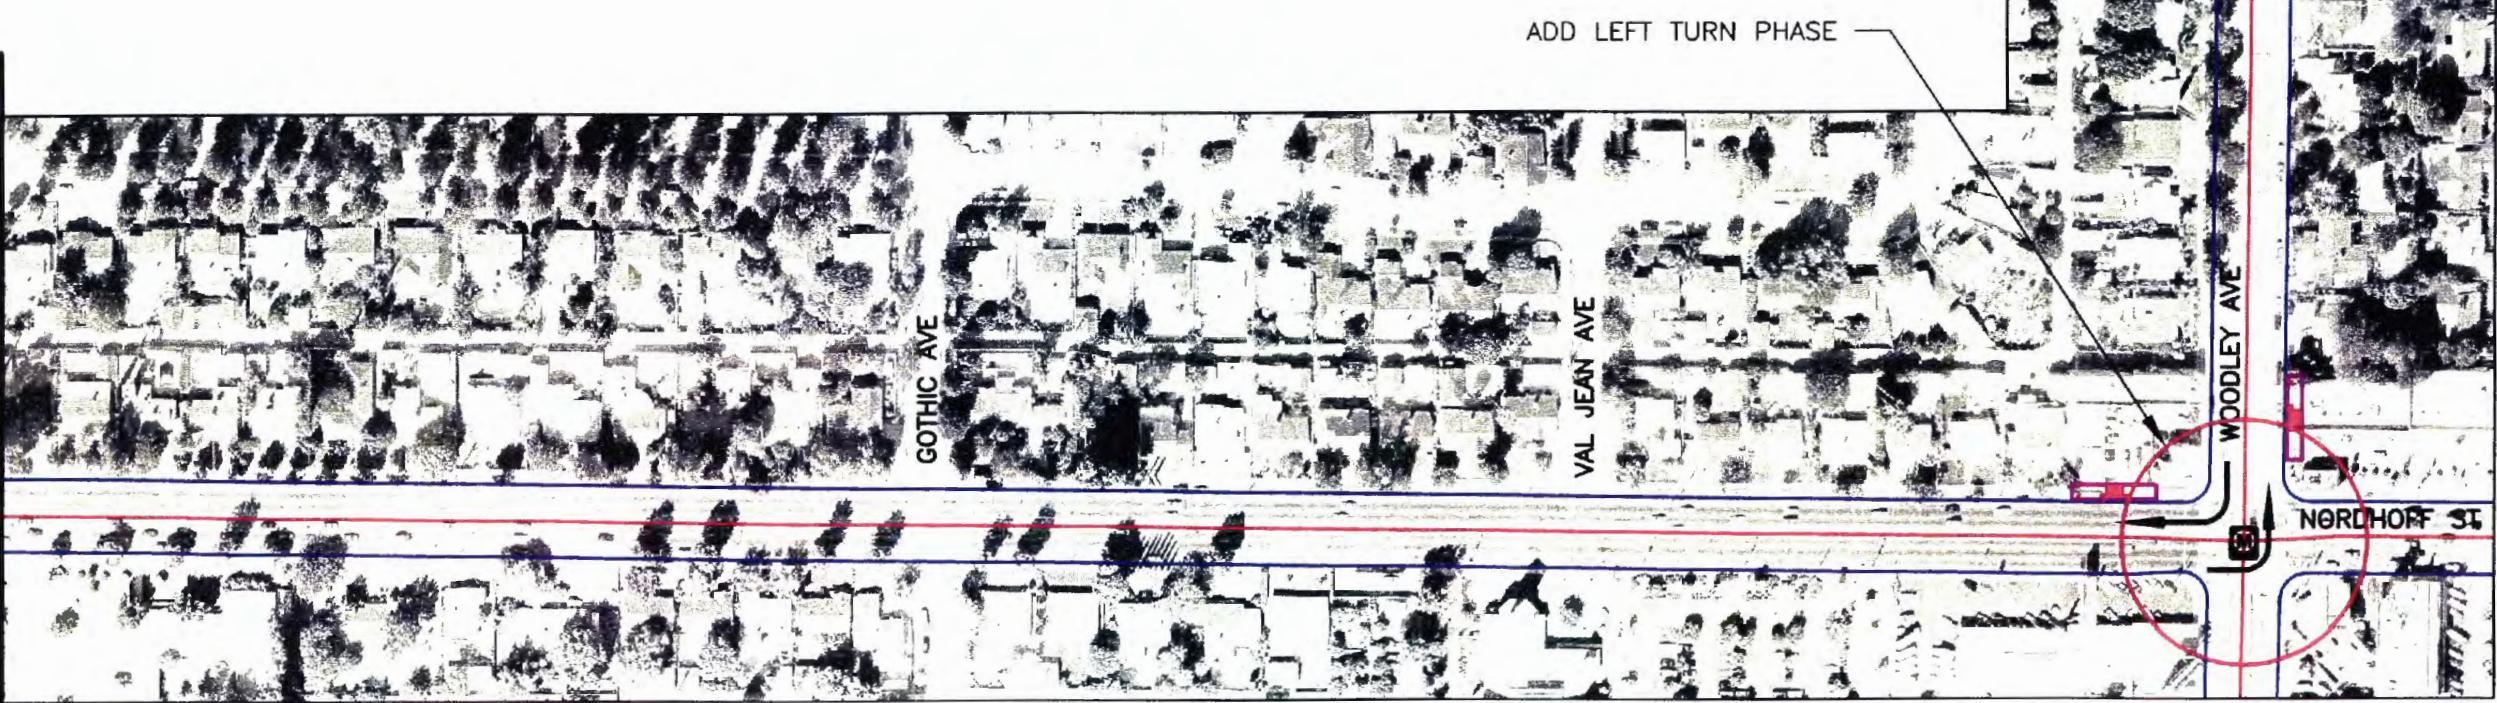

NOT FOR CONSTRUCTION

D	1/03						
REV	DATE	BY	APP	REG NO	EXPIRES	SEAL HOLDER	SOLICITATION LEVEL
DESCRIPTION							

DESIGNED BY JAF
DRAWN BY JAF
CHECKED BY MT.
IN CHARGE RRH
DATE 1/03


LOS ANGELES COUNTY METROPOLITAN TRANSPORTATION AUTHORITY
SAN FERNANDO VALLEY NORTH-SOUTH TRANSITWAY CORRIDOR M.I.S.

MEYER, MOHADDES ASSOCIATES, INC
707 WILSHIRE BLVD., SUITE 4810
LOS ANGELES, CA 90017

HKA Hernandez, Kroone & Associates, Inc.
CONSULTING ENGINEERS — PLANNING - DESIGN - SURVEYING
234 DRAKE DRIVE SAN BERNARDINO, CA 92408
(909) 864-3222 FAX (909) 383-1577

RESEDA BLVD CORRIDOR
NORDHOFF ST
RESEDA BLVD TO WOODLEY AVE


CONTRACT NO
PS4350-1018
DRAWING NO REV
0
SCALE
1"=200'
SHEET NO
8 OF 15

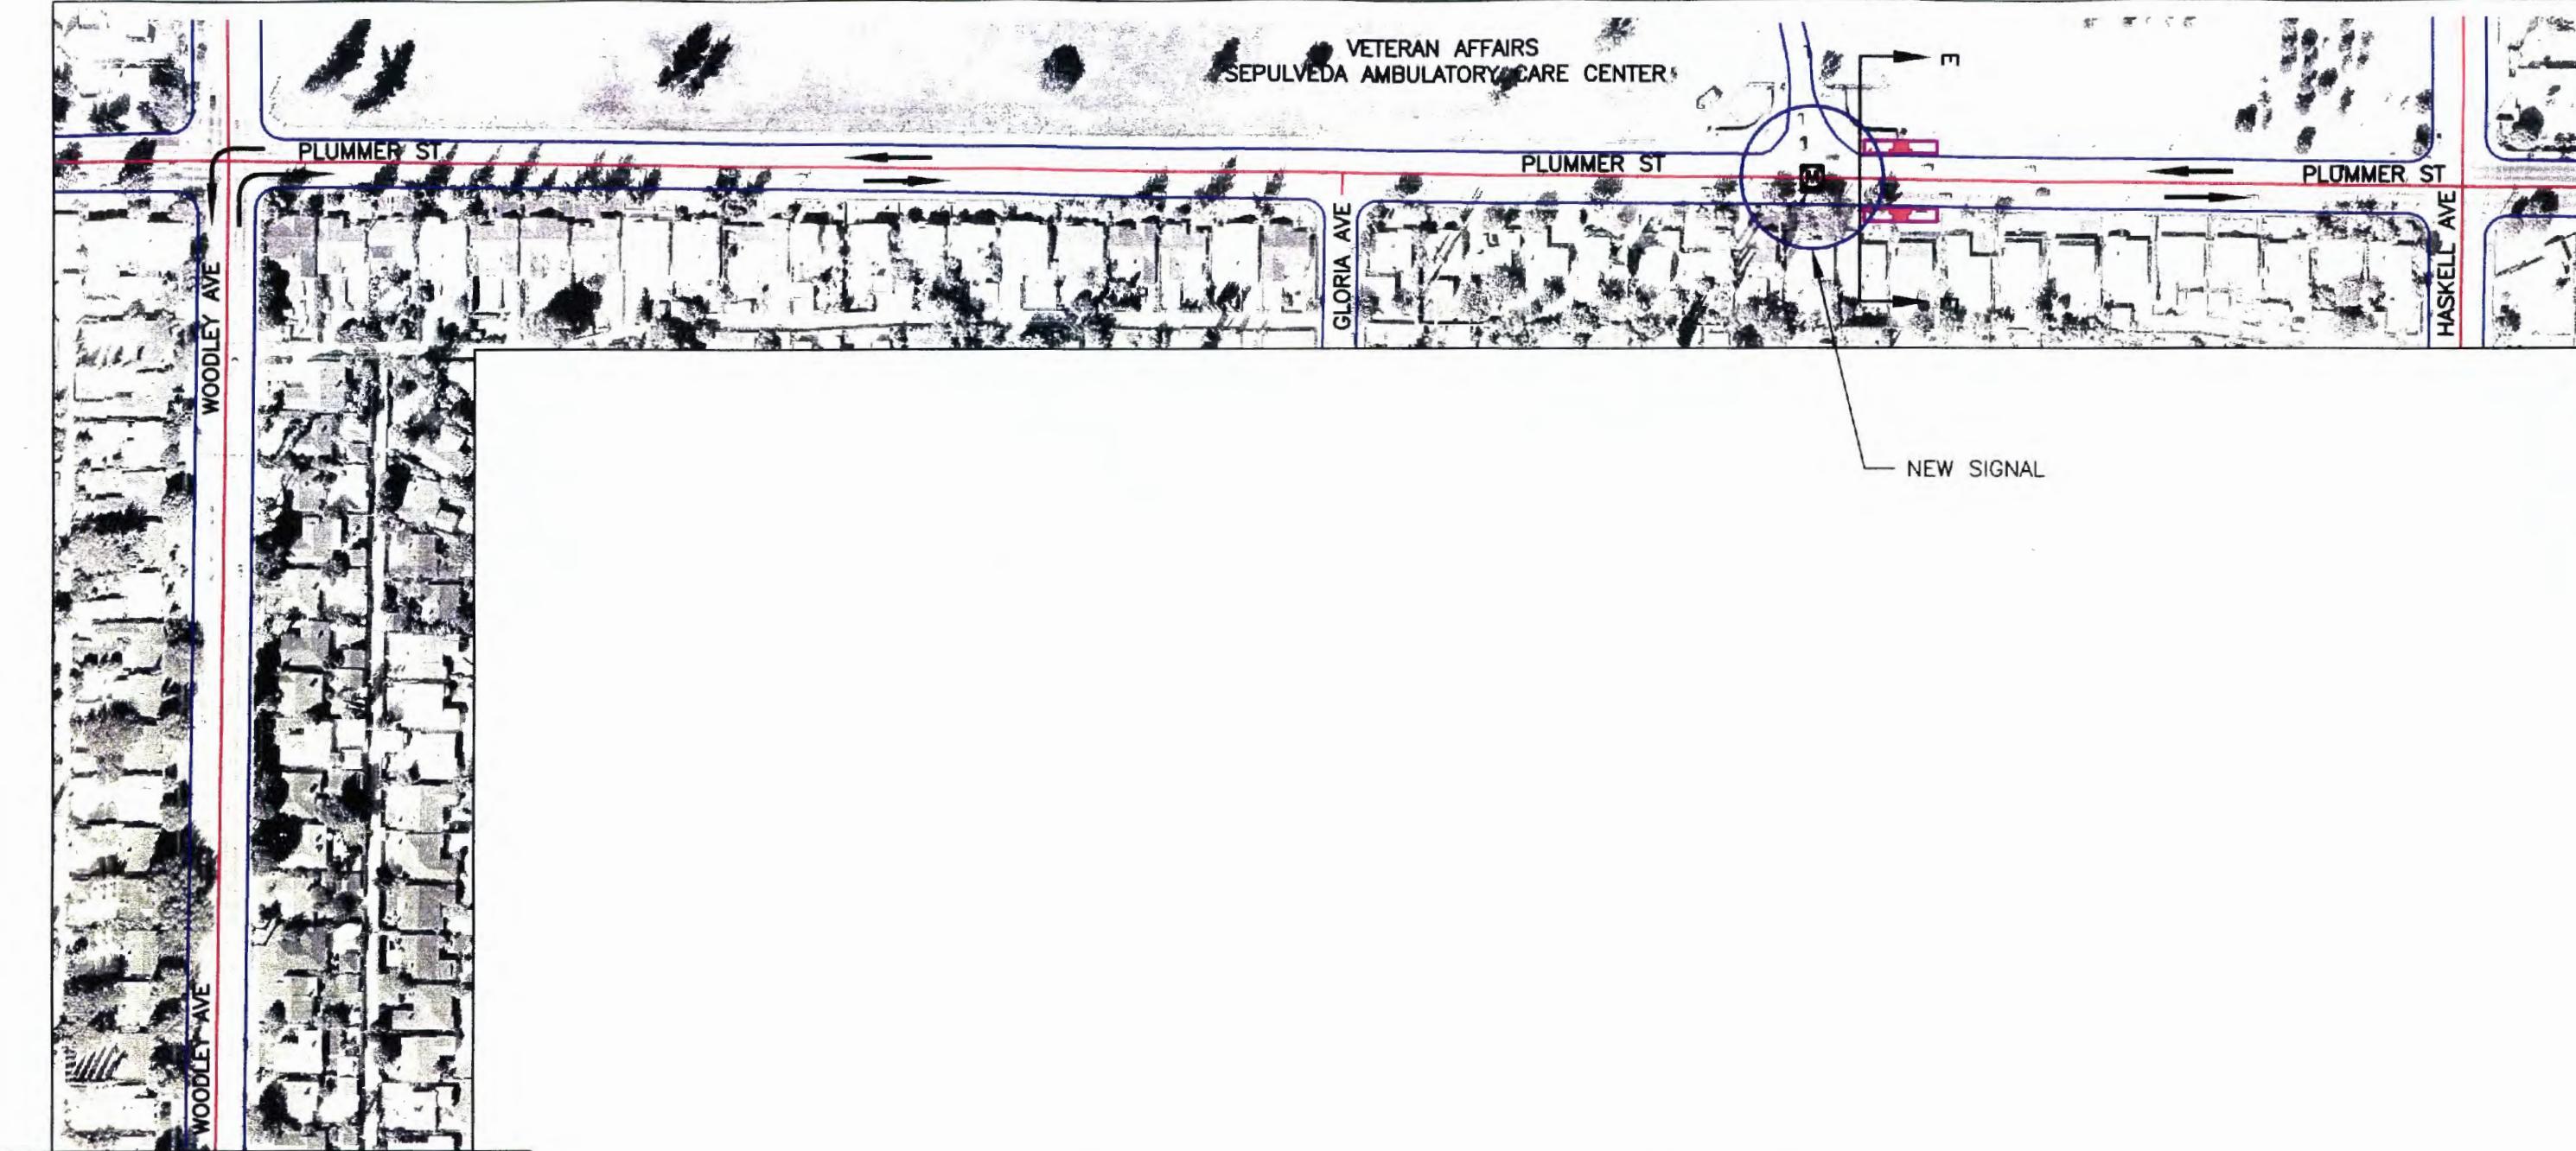

MATCH LINE SEE SHEET 8

LEGEND

- | | | | |
|-------------------------------------------------------------------------------------|-----------------------------------------|-------------------------------------------------------------------------------------|------------------------|
|  | STATION LOCATION |  | LANDSCAPE MEDIAN |
|  | STOP LOCATION |  | EXISTING FREEWAY |
|  | PROPOSED BUS STATION |  | MAIN DIRECTION OF FLOW |
|  | EXISTING STREETS |  | EXISTING ELEMENT |
|  | EXISTING RIVER/WASH |  | INDICATES POP-OUT |
|  | FUTURE EAST-WEST METRO RAPID TRANSITWAY |  | 60' BUS |

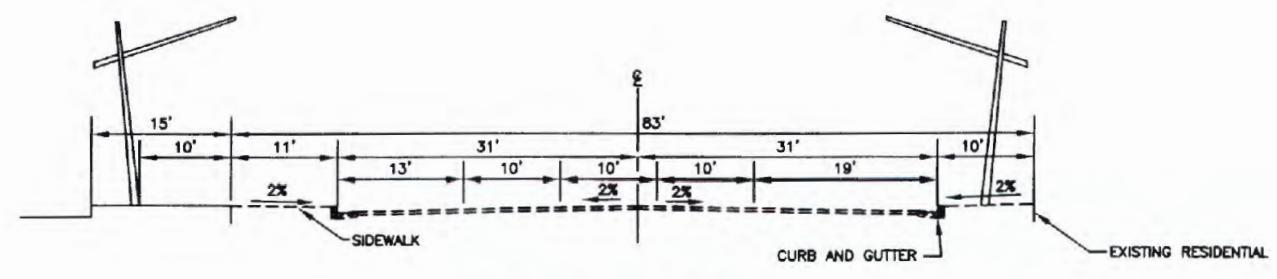

CROSS SECTION E-E

A horizontal scale bar with markings at 0, 100, 200, and 600.


NOT FOR CONSTRUCTION

DESIGNED BY	JAF
DRAWN BY	JAF
CHECKED BY	MT.
IN CHARGE	RRH
DATE	1/03



LOS ANGELES COUNTY METROPOLITAN TRANSPORTATION AUTHORITY
SAN FERNANDO VALLEY NORTH-SOUTH TRANSITWAY CORRIDOR M.I.S.

MEYER, MOHADDES ASSOCIATES, INC.
707 WILSHIRE BLVD., SUITE 4810
LOS ANGELES, CA 90017

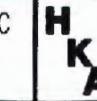


Hernandez, Kroone
& Associates, Inc.
CONSULTING ENGINEERS
PLANNING - DESIGN - SURVEYING
234 DRAKE DRIVE
SAN BERNARDINO, CA 92408
(909) 884-3222 FAX (909) 385-1577

RESEDA BLVD CORRIDOR
PLUMMER ST
WOODLEY AVE TO SEPULVEDA BLVD

ACT NO
PS4350-1018
ING NO [REDACTED]
"=200'
NO
OF 15

MATCH LINE SEE SHEET 9

BEGIN NORTH/SOUTH BOUND
PEAK PERIOD HOUR LANES

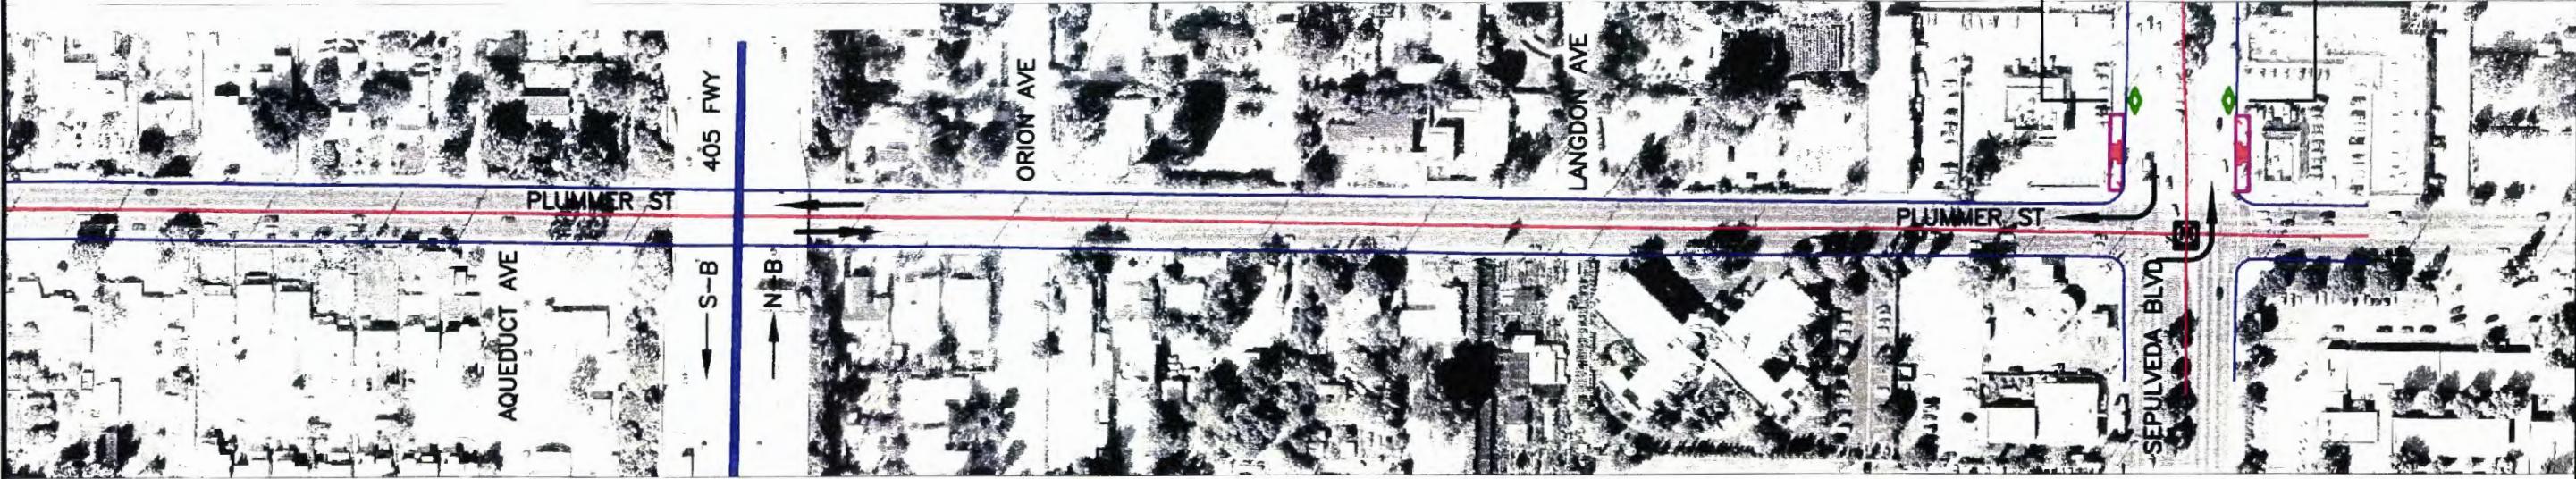

MATCH LINE SEE SHEET 11

LEGEND

- The legend contains seven entries, each consisting of a small icon followed by a descriptive label:

 - STATION LOCATION**: Represented by a black square containing a white letter 'M'.
 - STOP LOCATION**: Represented by a thick red rectangle.
 - PROPOSED BUS STATION**: Represented by a red rectangle with a white outline.
 - EXISTING STREETS**: Represented by three parallel horizontal lines: a red one at the top, a blue one in the middle, and a black one at the bottom.
 - EXISTING FREEWAY**: Represented by a thick blue line.
 - MAIN DIRECTION OF FLOW**: Represented by a black arrow pointing to the right.
 - PEAK PERIOD BUS LANE**: Represented by a green diamond shape.

SCALE:  1"=200'

0 100 200 600

NOT FOR CONSTRUCTION


0	1/03						SOLICITATION LEVEL
REV	DATE	BY	APP	REQ NO	EXPIRES	SEAL HOLDER	DESCRIPTION

DESIGNED BY	JAF
DRAWN BY	JAF
CHECKED BY	MT.
IN CHARGE	RRH
DATE	1/03



LOS ANGELES COUNTY METROPOLITAN TRANSPORTATION AUTHORITY
SAN FERNANDO VALLEY NORTH-SOUTH TRANSITWAY CORRIDOR M.I.S.

MEYER, MOHADDES ASSOCIATES, INC.
707 WILSHIRE BLVD., SUITE 4810
LOS ANGELES, CA 90017

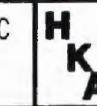


Hernandez, Kroone
& Associates, Inc.
— CONSULTING ENGINEERS —
PLANNING - DESIGN - SURVEYING
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SAN BERNARDINO, CA 92408
(909) 884-3222 FAX (909) 363-1577

RESEDA BLVD CORRIDOR
PLUMMER ST
WOODLEY AVE TO SEPULVEDA BLVD

CONTRACT NO	PS4350-1018
AWING NO	REV 0
ALE	$1'' = 200'$
EET NO	10 OF 15

MATCH LINE SEE SHEET 10

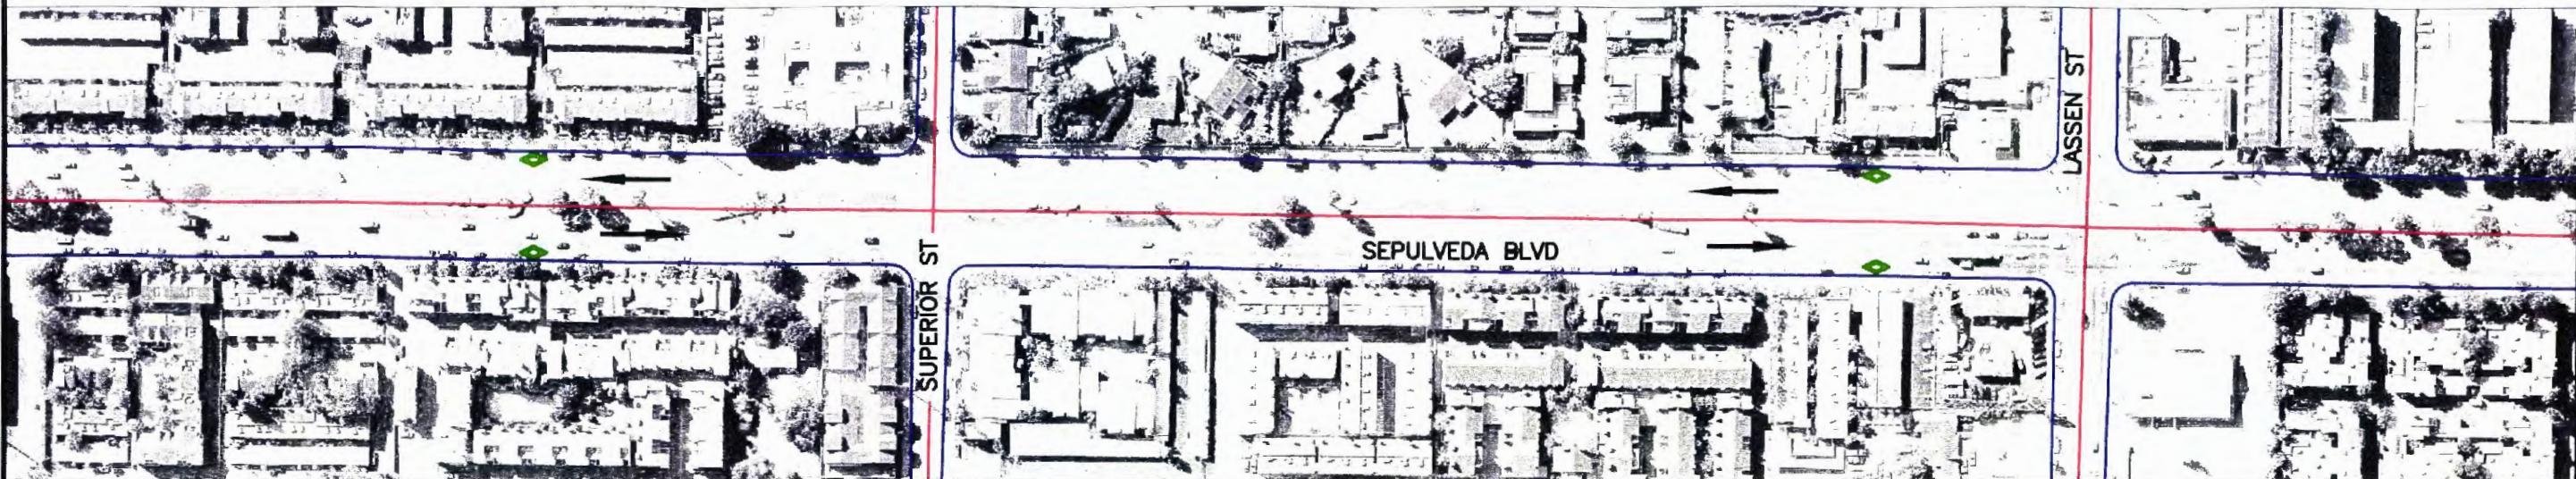

MATCH LINE SEE BELOW LEFT

MATCH LINE SEE ABOVE RIGHT



MATCH LINE SEE SHEET 12

SCALE: 1"=200'

SCALE: 1"=200'

LEGEND:

- STATION LOCATION
- STOP LOCATION
- PROPOSED BUS STATION
- EXISTING STREETS
- MAIN DIRECTION OF FLOW
- EXISTING FREEWAY
- ◆ PEAK PERIOD BUS LANE

0 100 200 600

NOT FOR CONSTRUCTION

0 1/03				SOLICITATION LEVEL			
REV	DATE	BY	APP	REG NO.	EXPIRES	SEAL HOLDER	DESCRIPTION

DESIGNED BY JAF
DRAWN BY JAF
CHECKED BY MT.
IN CHARGE RRH
DATE 1/03

M LOS ANGELES COUNTY METROPOLITAN TRANSPORTATION AUTHORITY
SAN FERNANDO VALLEY NORTH-SOUTH TRANSITWAY CORRIDOR M.I.S.
MEYER, MOHADDES ASSOCIATES, INC
707 WILSHIRE BLVD., SUITE 4810
LOS ANGELES, CA 90017
HKA Hernandez, Kroone & Associates, Inc.
CONSULTING ENGINEERS —
PLANNING - DESIGN - SURVEYING
234 DRAKE DRIVE
SAN BERNARDINO, CA 92408
(909) 884-3222 FAX (909) 383-1577

RESEDA BLVD CORRIDOR
SEPULVEDA BLVD
PLUMMER ST TO BRAND BLVD

CONTRACT NO
PS4350-1018
DRAWING NO
REV 0
SCALE
1"=200'
SHEET NO
11 OF 15

MATCH LINE SEE SHEET 11

END NORTH/SOUTH BOUND
PEAK PERIOD HOUR LANES



MATCH LINE SEE BELOW LEFT

END NORTH/SOUTH BOUND
PEAK PERIOD HOUR LANES

SCALE: 1"=200'

LEGEND:

- STATION LOCATION
- STOP LOCATION
- PROPOSED BUS STATION
- EXISTING STREETS
- MAIN DIRECTION OF FLOW
- EXISTING FREEWAY
- PEAK PERIOD BUS LANE

0 100 200 600

NOT FOR CONSTRUCTION


						DESIGNED BY JAF		LOS ANGELES COUNTY METROPOLITAN TRANSPORTATION AUTHORITY SAN FERNANDO VALLEY NORTH-SOUTH TRANSITWAY CORRIDOR M.I.S. MEYER, MOHADDES ASSOCIATES, INC 707 WILSHIRE BLVD., SUITE 4810 LOS ANGELES, CA 90017	RESEDA BLVD CORRIDOR SEPULVEDA BLVD PLUMMER ST TO BRAND BLVD
						DRAWN BY JAF			
						CHECKED BY MT.			
						IN CHARGE RRH			
0	1/03				SOLICITATION LEVEL	DATE 1/03			
REV	DATE	BY	APP	REG NO	EXPIRES	SEAL HOLDER			
					DESCRIPTION				

0 100 200 600

CONTRACT NO
PS4350-1018
DRAWING NO
REV
0
SCALE
1"=200'
SHEET NO
12 OF 15


HKA Hernandez, Kroone & Associates, Inc.
CONSULTING ENGINEERS — PLANNING — DESIGN — SURVEYING
234 DRAKE DRIVE SAN BERNARDINO, CA 92408
(909) 864-3222 FAX (909) 383-1577

MATCH LINE SEE SHEET 12

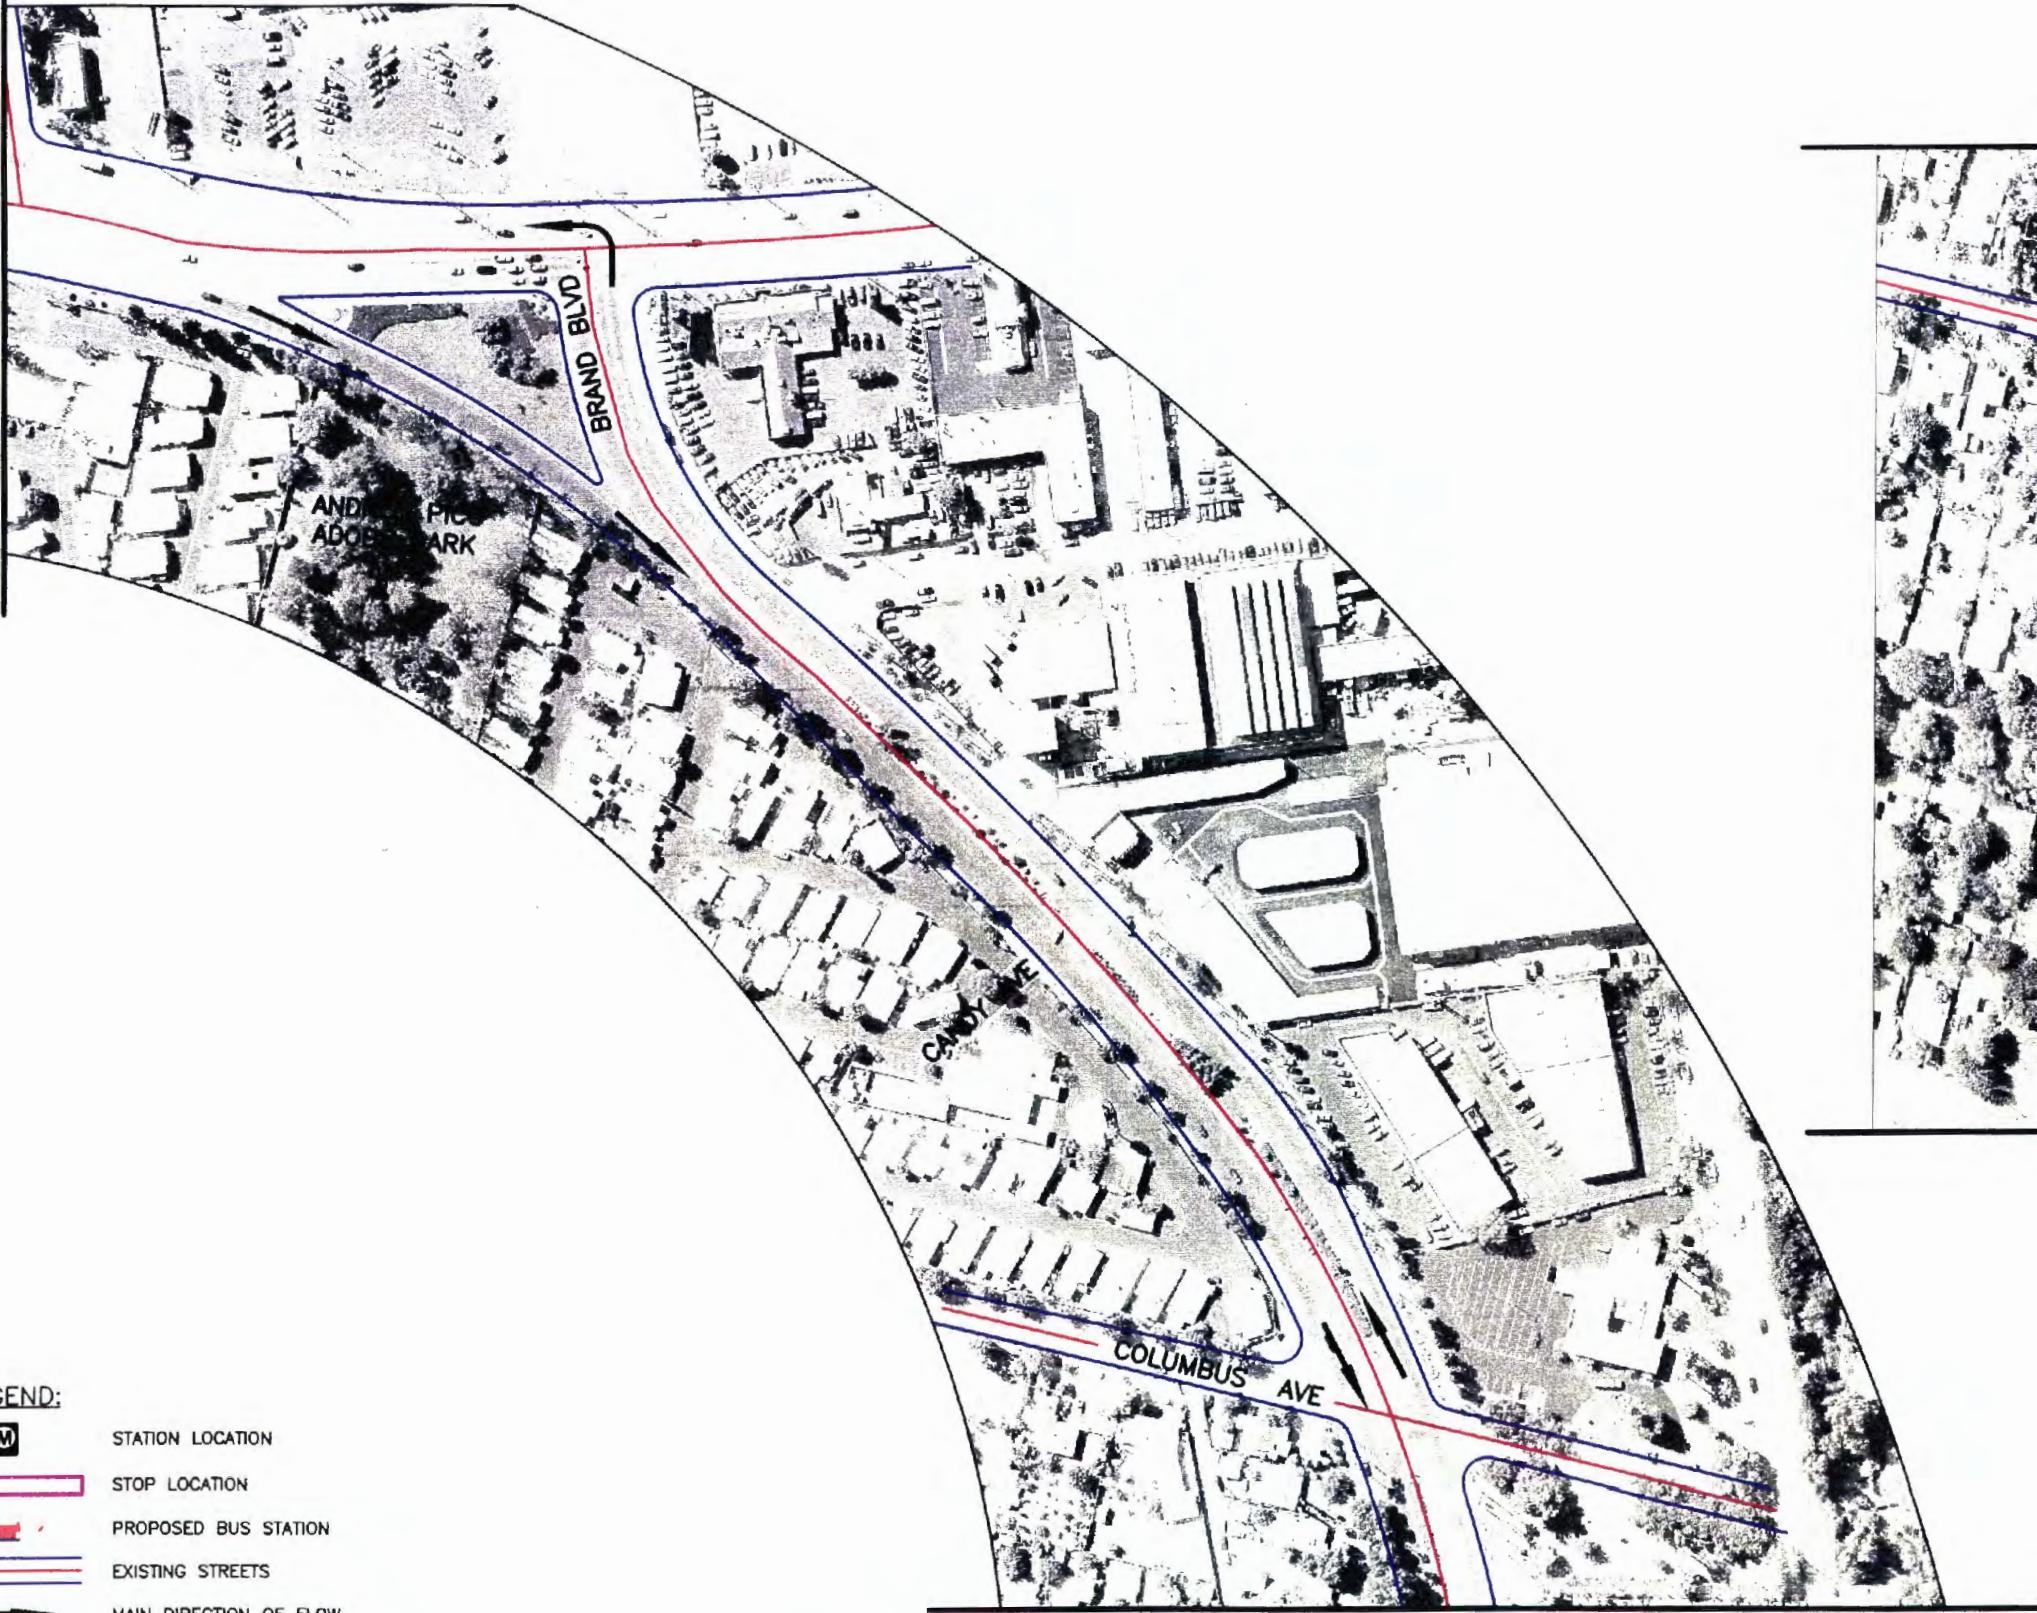

MATCH LINE SEE ABOVE RIGHT

MATCH LINE SEE BELOW LEFT

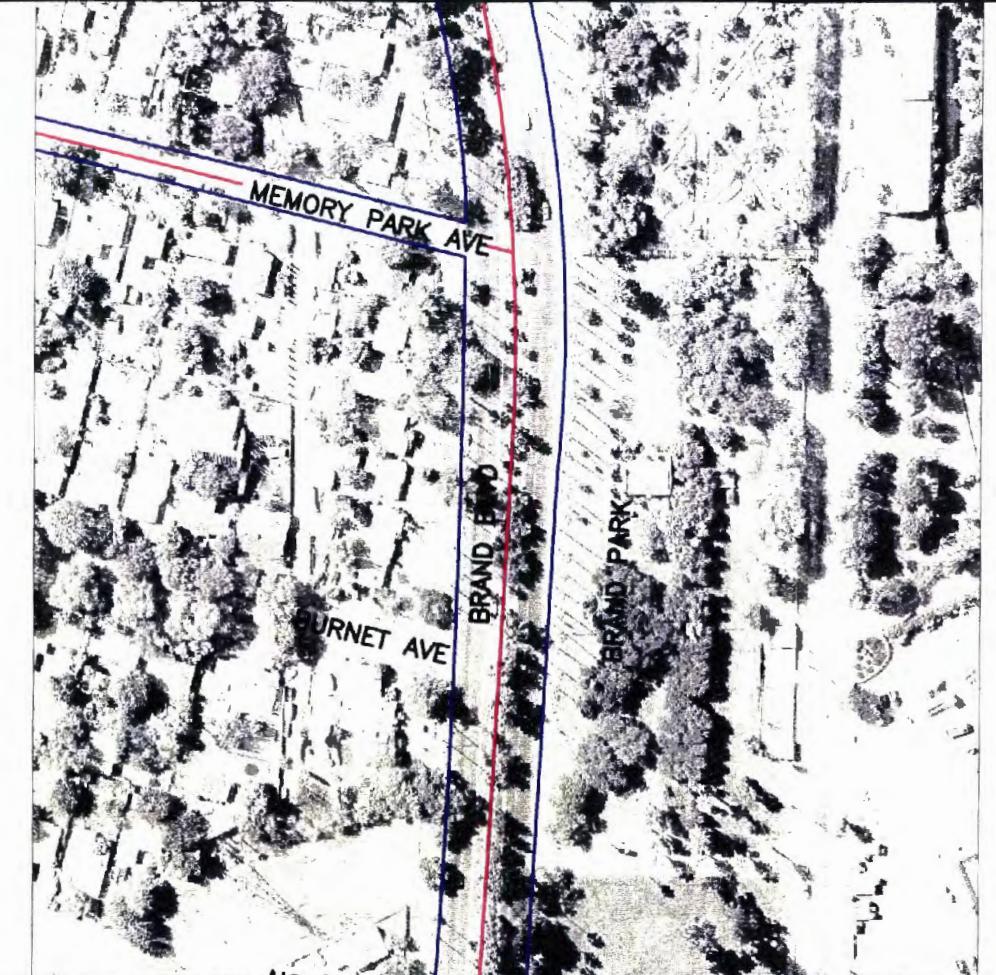

MATCH LINE SEE SHEET 14

LEGEND:

-  STATION LOCATION
 STOP LOCATION
 PROPOSED BUS STATION
 EXISTING STREETS
 MAIN DIRECTION OF FLOW
 EXISTING FREEWAY

SCALE: 1"=200'

M LOS ANGELES COUNTY METROPOLITAN TRANSPORTATION AUTHORITY
SAN FERNANDO VALLEY NORTH-SOUTH TRANSITWAY CORRIDOR M.I.S.

MEYER, MOHADDIES ASSOCIATES, INC
707 WILSHIRE BLVD., SUITE 4810
LOS ANGELES, CA 90017

H K A Hernandez, Kroone
& Associates, Inc.
— CONSULTING ENGINEERS —
PLANNING - DESIGN - SURVEYING
234 DRAKE DRIVE
SAN BERNARDINO, CA 92408
(909) 864-3222 FAX (909) 383-15

									DESIGNED BY JAF
									DRAWN BY JAF
									CHECKED BY MT.
									IN CHARGE RRH
0	1/03						SOLICITATION LEVEL		DATE 1/03
REV	DATE	BY	APP	REQ NO	EXPIRES	SEAL HOLDER	DESCRIPTION		

MEYER, MOHADDES ASSOCIATES, INC.
707 WILSHIRE BLVD., SUITE 4810
LOS ANGELES, CA 90017

H K A Hernandez, Kroone & Associates, Inc.
— CONSULTING ENGINEERS —
PLANNING DESIGN SURVEYING
234 DRAKE DRIVE
SAN BERNARDINO, CA 92408
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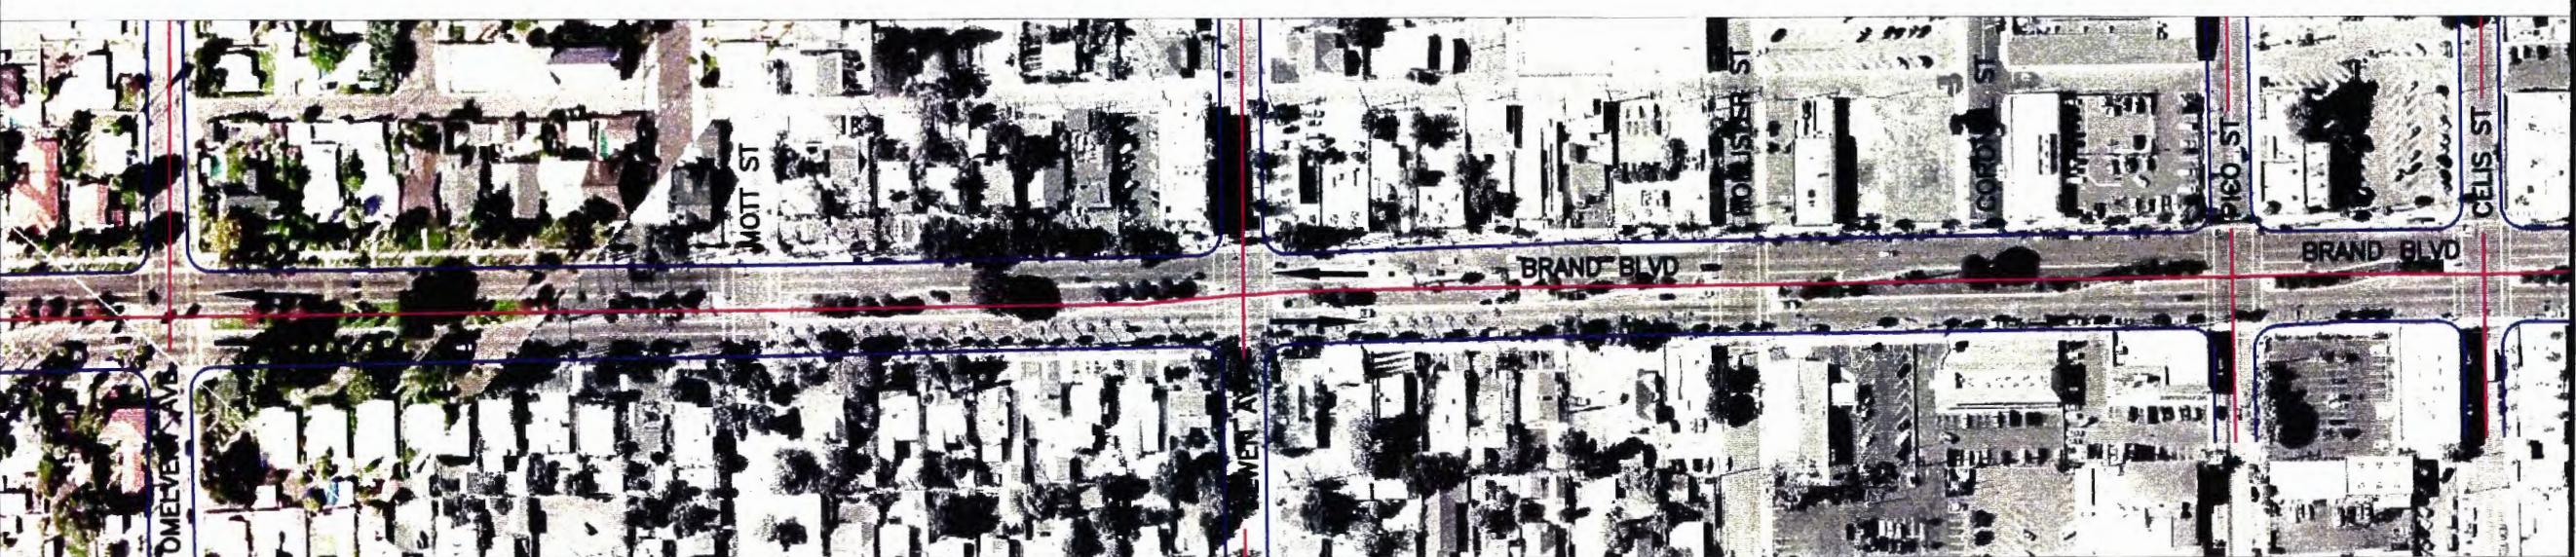
CONTRACT NO	
PS4350-101B	
DRAWING NO	REV
	0
SCALE	
1"=200'	
SHEET NO	
13 OF 15	

MATCH LINE SEE SHEET 13



MATCH LINE SEE BELOW LEFT

MATCH LINE SEE ABOVE RIGHT



MATCH LINE SEE SHEET 15

LEGEND:

- STATION LOCATION
- STOP LOCATION
- PROPOSED BUS STATION
- EXISTING STREETS
- EXISTING RIVER/WASH
- EXISTING FREEWAY
- MAIN DIRECTION OF FLOW

SCALE: 1"=200'

0 100 200 600

NOT FOR CONSTRUCTION

0	1/03											
REV	DATE	BY	APP	REG NO.	EXPIRES	SEAL HOLDER	SOLICITATION LEVEL	RRH	DATE	1/03		

DESIGNED BY
JAF
DRAWN BY
JAF
CHECKED BY
MT.
IN CHARGE
RRH
DATE
1/03

LOS ANGELES COUNTY METROPOLITAN TRANSPORTATION AUTHORITY
SAN FERNANDO VALLEY NORTH-SOUTH TRANSITWAY CORRIDOR M.I.S.
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HKA
Hernandez, Kroone
& Associates, Inc.
CONSULTING ENGINEERS —
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234 DRAKE DRIVE
SAN BERNARDINO, CA 92408
(909) 884-3222 FAX (909) 383-1577

RESEDA BLVD CORRIDOR
BRAND BLVD
SEPULVEDA BLVD TO TRUMAN ST


CONTRACT NO
PS4350-101B
DRAWING NO
REV
0
SCALE
1"=200'
SHEET NO
14 OF 15

MATCH LINE SEE SHEET 14



MATCH LINE SEE BELOW LEFT

MATCH LINE SEE ABOVE RIGHT

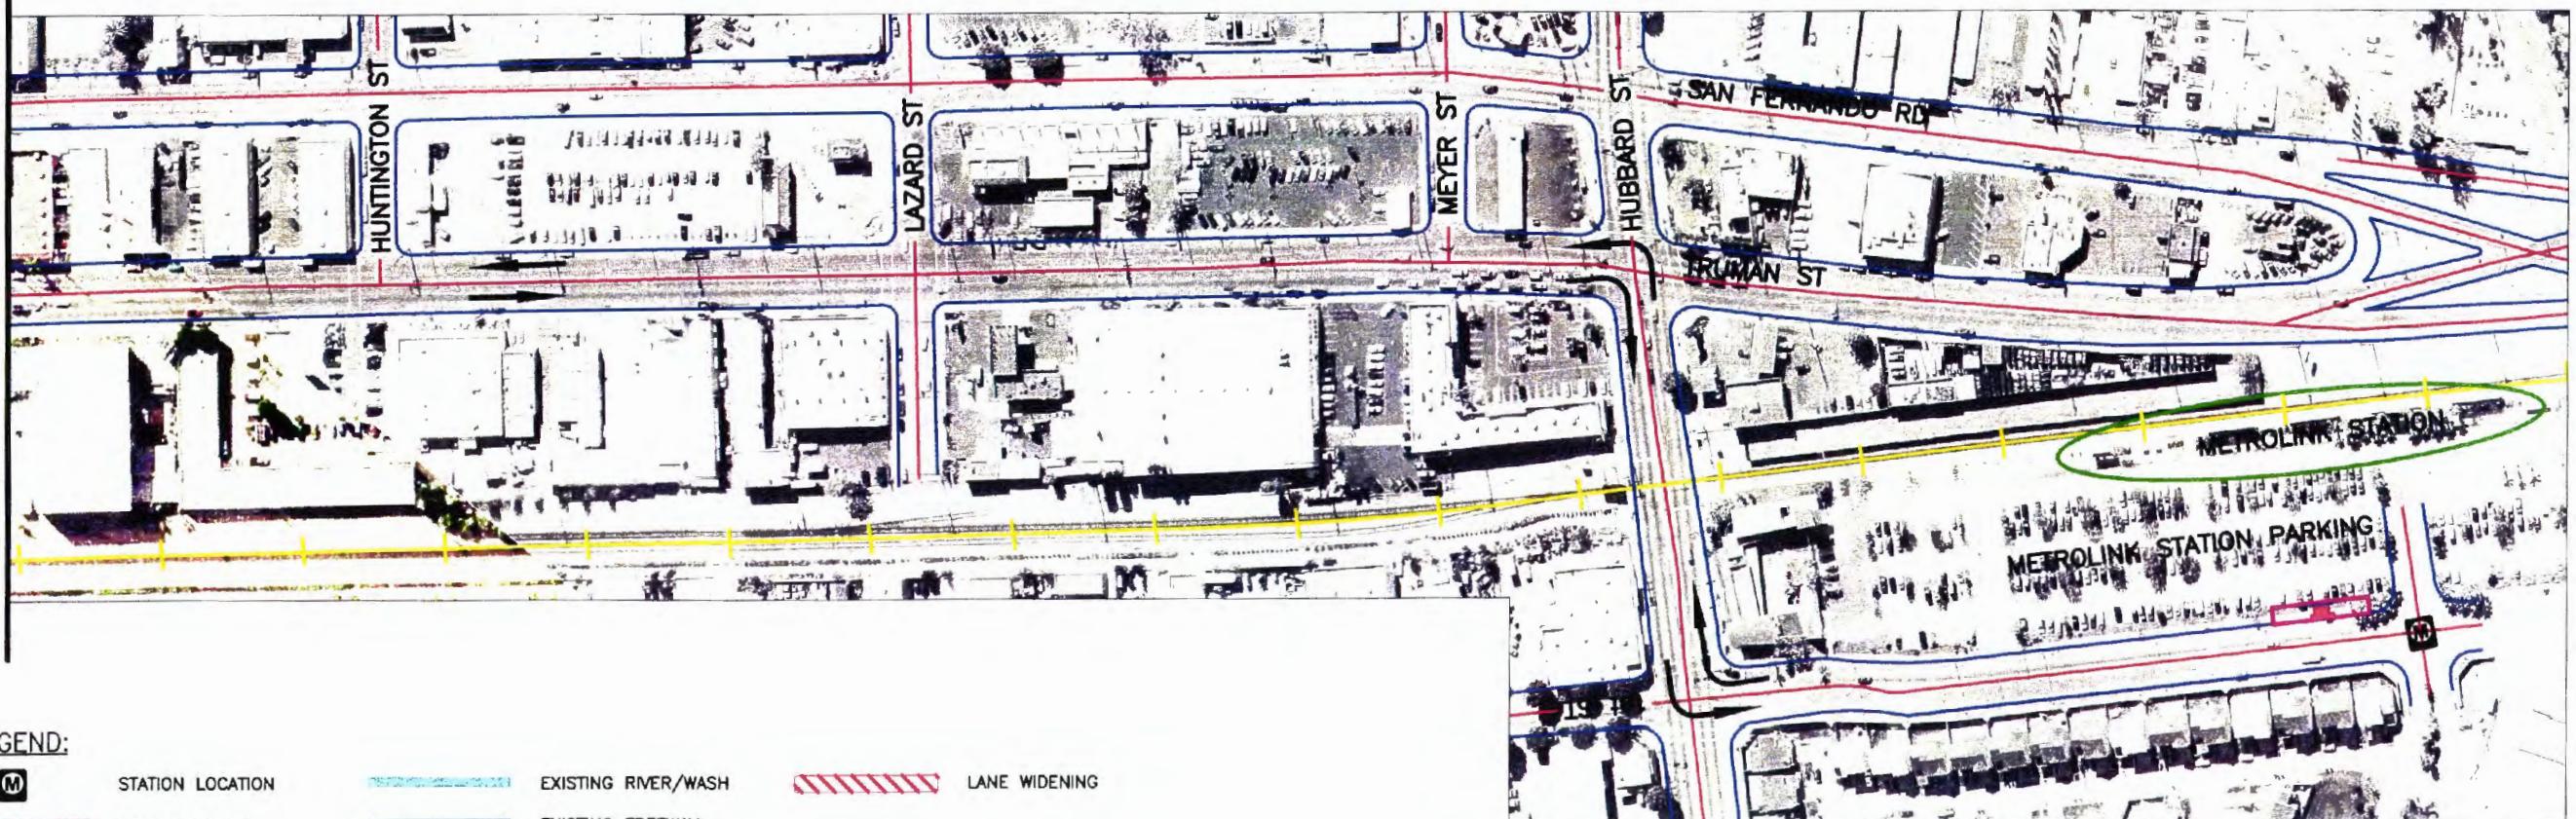

SCALE: 1"=200'

LEGEND:

	STATION LOCATION		EXISTING RIVER/WASH		LANE WIDENING
	STOP LOCATION		EXISTING FREEWAY		
	PROPOSED BUS STATION		MAIN DIRECTION OF FLOW		
	EXISTING STREETS		EXISTING RAILROAD		

0 100 200 600

NOT FOR CONSTRUCTION

0	1/03					
REV	DATE	BY	APP	REG NO.	EXPIRES	SEAL HOLDER
SOLICITATION LEVEL						DESCRIPTION

DESIGNED BY JAF	DRAWN BY JAF
CHECKED BY MT.	IN CHARGE RRH
DATE 1/03	

LOS ANGELES COUNTY METROPOLITAN TRANSPORTATION AUTHORITY
SAN FERNANDO VALLEY NORTH-SOUTH TRANSITWAY CORRIDOR M.I.S.
MEYER, MOHADDES ASSOCIATES, INC
707 WILSHIRE BLVD., SUITE 4810
LOS ANGELES, CA 90017

Hernandez, Kroone & Associates, Inc.
CONSULTING ENGINEERS
PLANNING - DESIGN - SURVEYING
234 DRAKE DRIVE
SAN BERNARDINO, CA 92408
(909) 884-3222 FAX (909) 383-1577

RESEDA BLVD CORRIDOR
TRUMAN ST
BRAND BLVD TO HUBBARD ST


CONTRACT NO PS4350-1018	REV 0
DRAWING NO	
SCALE 1"=200'	
SHEET NO 15 OF 15	

MATCH LINE SEE ABOVE RIGHT



SCALE: 1"=200'

MATCH LINE SEE BELOW LEFT

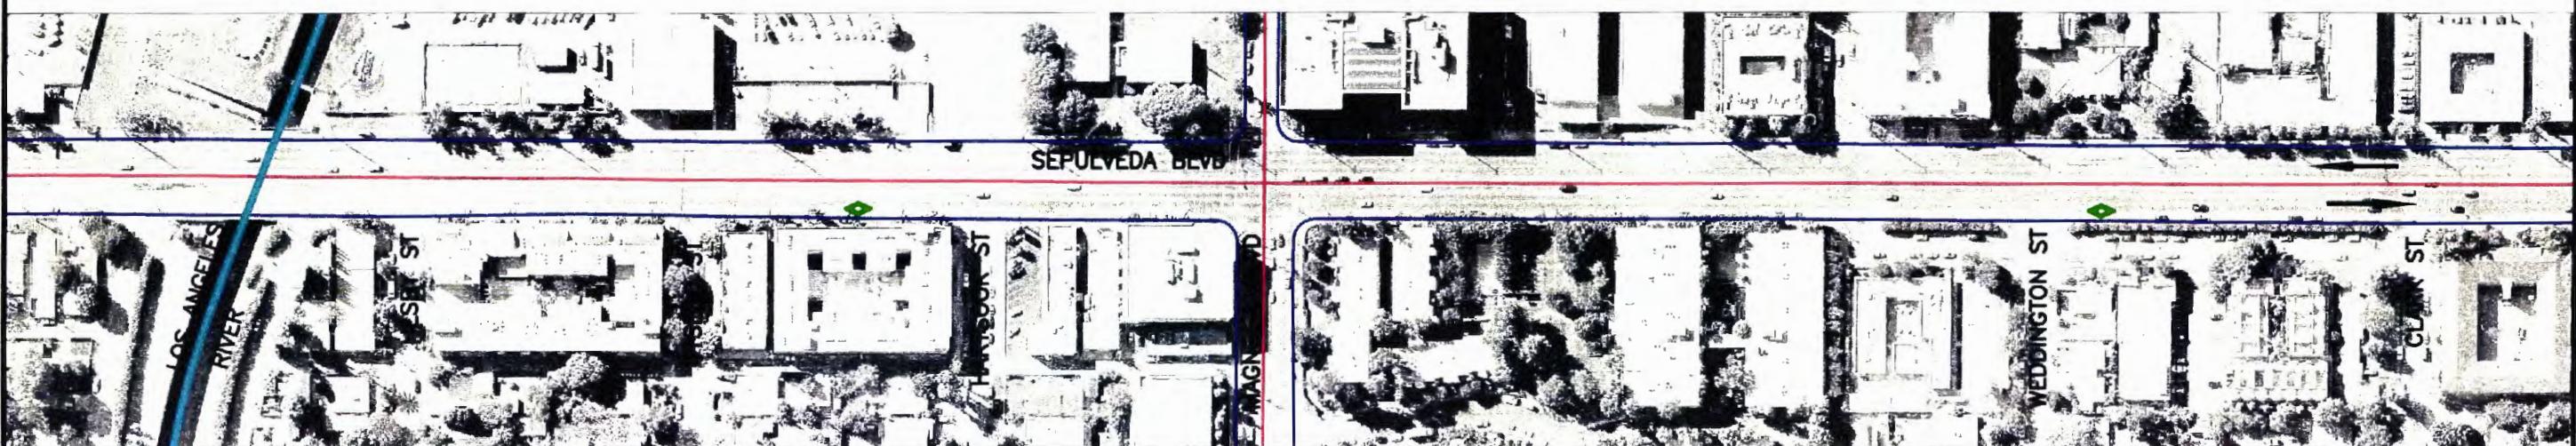

SCALE: 1"=200'

MATCH LINE SEE SHEET 2

LEGEND:

- | | | | |
|--|-----------------------------------------|--|------------------------|
| | STATION LOCATION | | LANE WIDENING |
| | STOP LOCATION | | EXISTING FREEWAY |
| | PROPOSED BUS STATION | | MAIN DIRECTION OF FLOW |
| | EXISTING STREETS | | EXISTING ELEMENT |
| | EXISTING RAILROAD | | PEAK PERIOD BUS LANE |
| | FUTURE EAST-WEST METRO RAPID TRANSITWAY | | EXISTING RIVER/WASH |

NOTE:

RESTRIPE PROVIDES NORTH BOUND
PEAK PERIOD BUS LANE

0 100 200 600
600

CONTRACT NO PS4350-1018	
DRAWING NO	REV 0
SCALE 1"=200'	
SHEET NO 1 OF 10	

						DESIGNED BY JAF		LOS ANGELES COUNTY METROPOLITAN TRANSPORTATION AUTHORITY SAN FERNANDO VALLEY NORTH-SOUTH TRANSITWAY CORRIDOR M.I.S.	
						DRAWN BY JAF			
						CHECKED BY MT.			
						IN CHARGE RRH			
0	1/03								
REV	DATE	BY	APP	REQ NO	EXPIRES	SEAL HOLDER		SOLICITATION LEVEL	DESCRIPTION
								1/03	

DESIGNED BY
JAF
DRAWN BY
JAF
CHECKED BY
MT.
IN CHARGE
RRH
DATE
1/03
SOLICITATION LEVEL
DESCRIPTION

MEYER, MOHADDES ASSOCIATES, INC
707 WILSHIRE BLVD., SUITE 4810
LOS ANGELES, CA 90017

— CONSULTING ENGINEERS —
PLANNING • DESIGN • SURVEYING
234 DRAKE DRIVE
SAN BERNARDINO, CA 92408
(909) 884-3222 FAX (909) 383-1577

NOT FOR CONSTRUCTION
SEPULEDVA BLVD CORRIDOR
VENTURA BLVD TO TRUMAN ST

MATCH LINE SEE SHEET 1



MATCH LINE SEE BELOW LEFT

MATCH LINE SEE ABOVE RIGHT



MATCH LINE SEE SHEET 3

FUTURE EAST-WEST METRO RAPID TRANSITWAY

SCALE: 1"=200'

LEGEND:

	STATION LOCATION		LANE WIDENING
	STOP LOCATION		EXISTING FREEWAY
	PROPOSED BUS STATION		MAIN DIRECTION OF FLOW
	EXISTING STREETS		EXISTING ELEMENT
	EXISTING RAILROAD		PEAK PERIOD BUS LANE
	FUTURE EAST-WEST METRO RAPID TRANSITWAY		EXISTING RIVER/WASH

0 100 200
600

NOT FOR CONSTRUCTION
 CONTRACT NO
 PS4350-1018
 DRAWING NO
 REV 0
 SCALE
 1"=200'
 SHEET NO
 2 OF 10


0 1/03	REV	DATE	BY	APP	REG NO	EXPIRES	SEAL HOLDER	SOLICITATION LEVEL	DESCRIPTION	DESIGNED BY JAF	DRAWN BY JAF	CHECKED BY MT.	IN CHARGE RRH	DATE 1/03
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M LOS ANGELES COUNTY METROPOLITAN TRANSPORTATION AUTHORITY
 SAN FERNANDO VALLEY NORTH-SOUTH TRANSITWAY CORRIDOR M.I.S.
 MEYER, MOHADDES ASSOCIATES, INC
 707 WILSHIRE BLVD., SUITE 4810
 LOS ANGELES, CA 90017

HKA Hernandez, Kroone & Associates, Inc.
 CONSULTING ENGINEERS
 PLANNING DESIGN SURVEYING
 234 DRAKE DRIVE
 SAN BERNARDINO, CA 92408
 (909) 884-3222 FAX (909) 383-1577

SEPULVEDA BLVD CORRIDOR
 VENTURA BLVD TO TRUMAN ST

MATCH LINE SEE SHEET 2

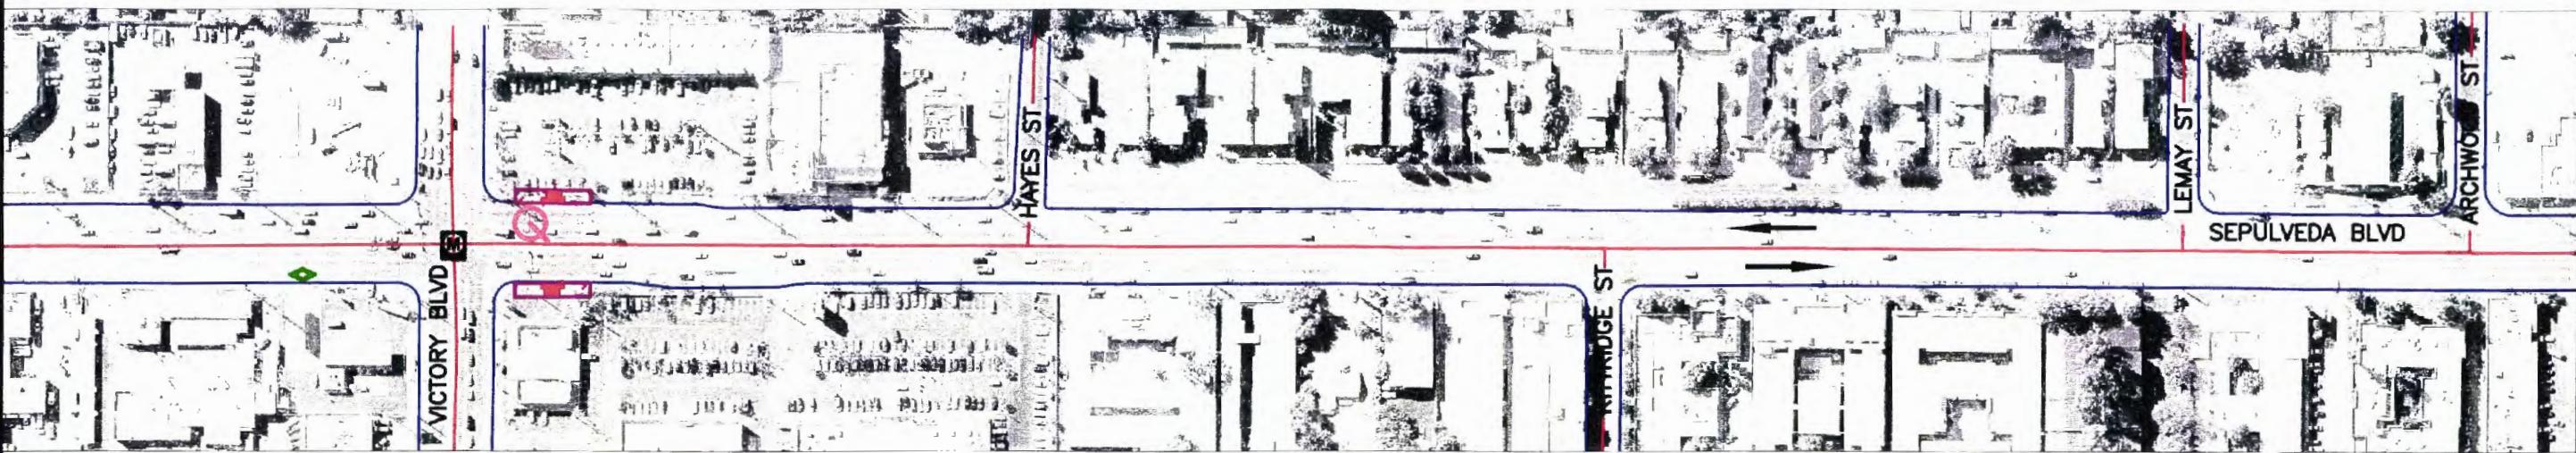

LEMY ST


ARCHWOOD ST

SEPULVEDA BLVD

MATCH LINE SEE BELOW LEFT

SCALE: 1"=200'

MATCH LINE SEE ABOVE RIGHT

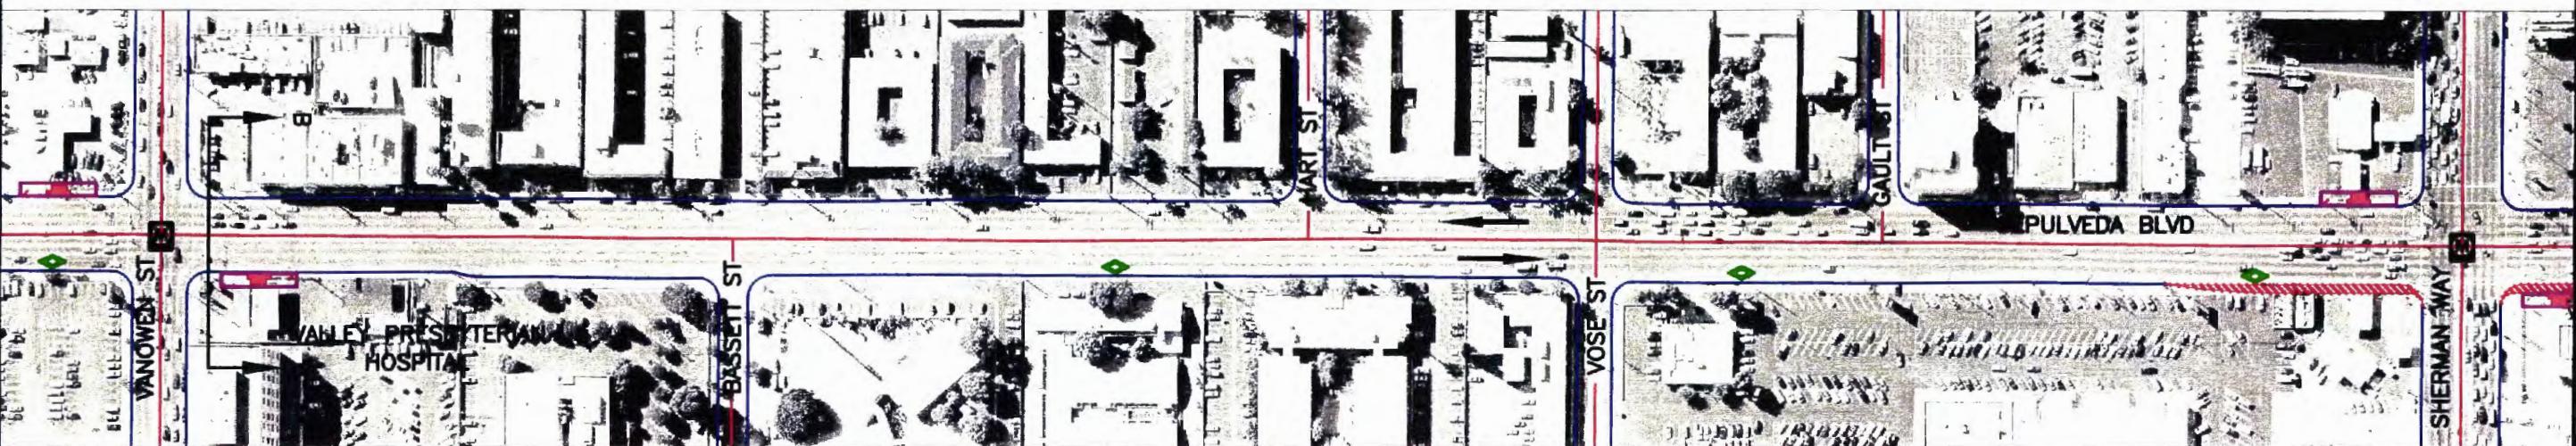


MATCH LINE SEE SHEET 4

SCALE: 1"=200'

LEGEND:

- STATION LOCATION
- LANE WIDENING
- STOP LOCATION
- EXISTING FREEWAY
- PROPOSED BUS STATION
- QUEUE JUMP SIGNAL
- EXISTING STREETS
- EXISTING ELEMENT
- EXISTING RAILROAD
- FUTURE EAST-WEST METRO RAPID TRANSITWAY
- PEAK PERIOD BUS LANE
- MAIN DIRECTION OF FLOW

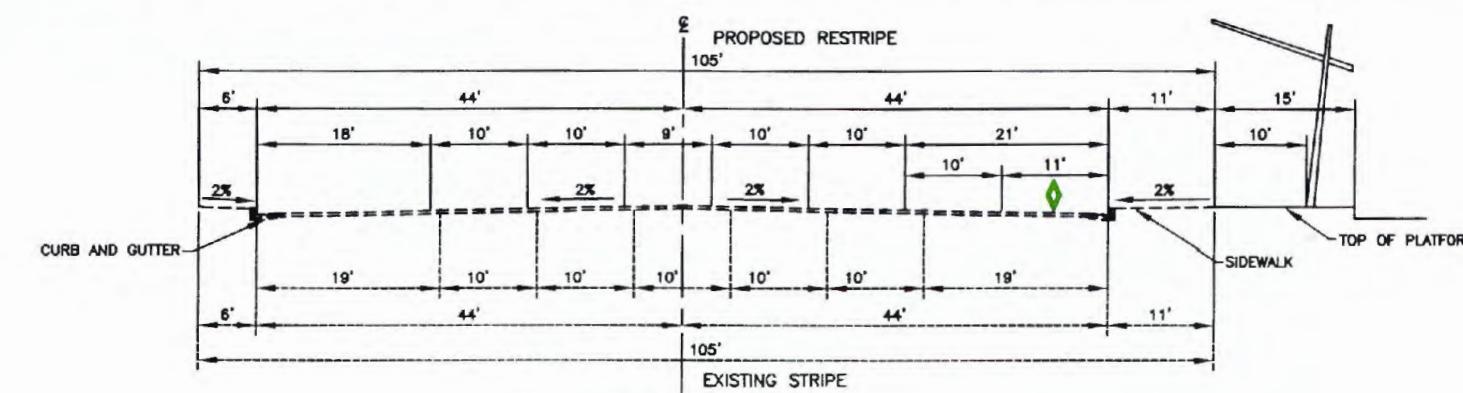

0 100 200
600

NOT FOR CONSTRUCTION

0	1/03												
REV	DATE	BY	APP	REQ NO	EXPIRES	SEAL HOLDER	SOLICITATION LEVEL						
								DESCRIPTION					

DESIGNED BY: JAF
DRAWN BY: JAF
CHECKED BY: MT.
IN CHARGE: RRH
DATE: 1/03


M LOS ANGELES COUNTY METROPOLITAN TRANSPORTATION AUTHORITY
SAN FERNANDO VALLEY NORTH-SOUTH TRANSITWAY CORRIDOR M.I.S.
MEYER, MOHADDES ASSOCIATES, INC
707 WILSHIRE BLVD., SUITE 4810
LOS ANGELES, CA 90017

HKA Hernandez, Kroone & Associates, Inc.
CONSULTING ENGINEERS — PLANNING — DESIGN — SURVEYING
234 DRAKE DRIVE
SAN BERNARDINO, CA 92408
(909) 884-3222 FAX (909) 383-1577

SEPULVEDA BLVD CORRIDOR
VENTURA BLVD TO TRUMAN ST

CONTRACT NO:
PS4350-1018
DRAWING NO:
REV 0
SCALE:
1"=200'
SHEET NO:
3 OF 10

MATCH LINE SEE SHEET 3

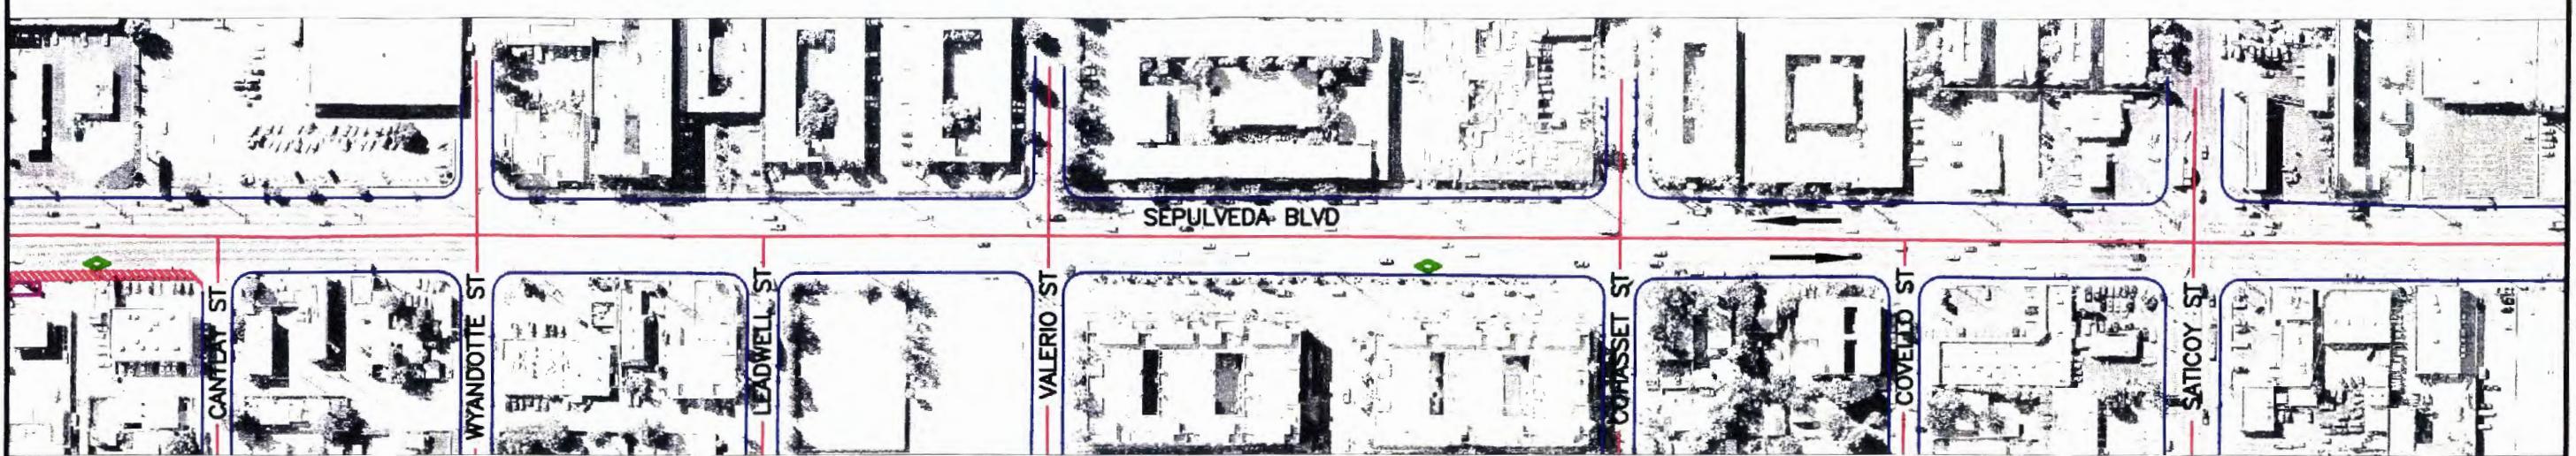

SCALE: 1"=200'

MATCH LINE SEE ABOVE RIGHT



SCALE: 1"=200'

LEGEND:

	STATION LOCATION		LANE WIDENING
	STOP LOCATION		EXISTING FREEWAY
	PROPOSED BUS STATION		MAIN DIRECTION OF FLOW
	EXISTING STREETS		EXISTING ELEMENT
	EXISTING RAILROAD		PEAK PERIOD BUS LANE
	FUTURE EAST-WEST METRO RAPID TRANSITWAY		EXISTING RIVER/WASH




NOT FOR CONSTRUCTION

REV	DATE	BY	APP	REG NO.	EXPIRES	SEAL HOLDER	DESCRIPTION	SOLICITATION LEVEL	DATE	DESIGNED BY	DRAWN BY	CHECKED BY	IN CHARGE	PLANNING	DESIGN	SURVEYING	CONTRACT NO	DRAWING NO	REV
										JAF	JAF	MT.	RRH	Hernandez, Kroone & Associates, Inc.	HKA	Hernandez, Kroone & Associates, Inc.	234 DRAKE DRIVE	SAN BERNARDINO, CA 92408	(909) 884-3222
0	1/03								1/03										

SEPULVEDA BLVD CORRIDOR
VENTURA BLVD TO TRUMAN ST

MATCH LINE SEE ABOVE RIGHT

MATCH LINE SEE SHEET 4

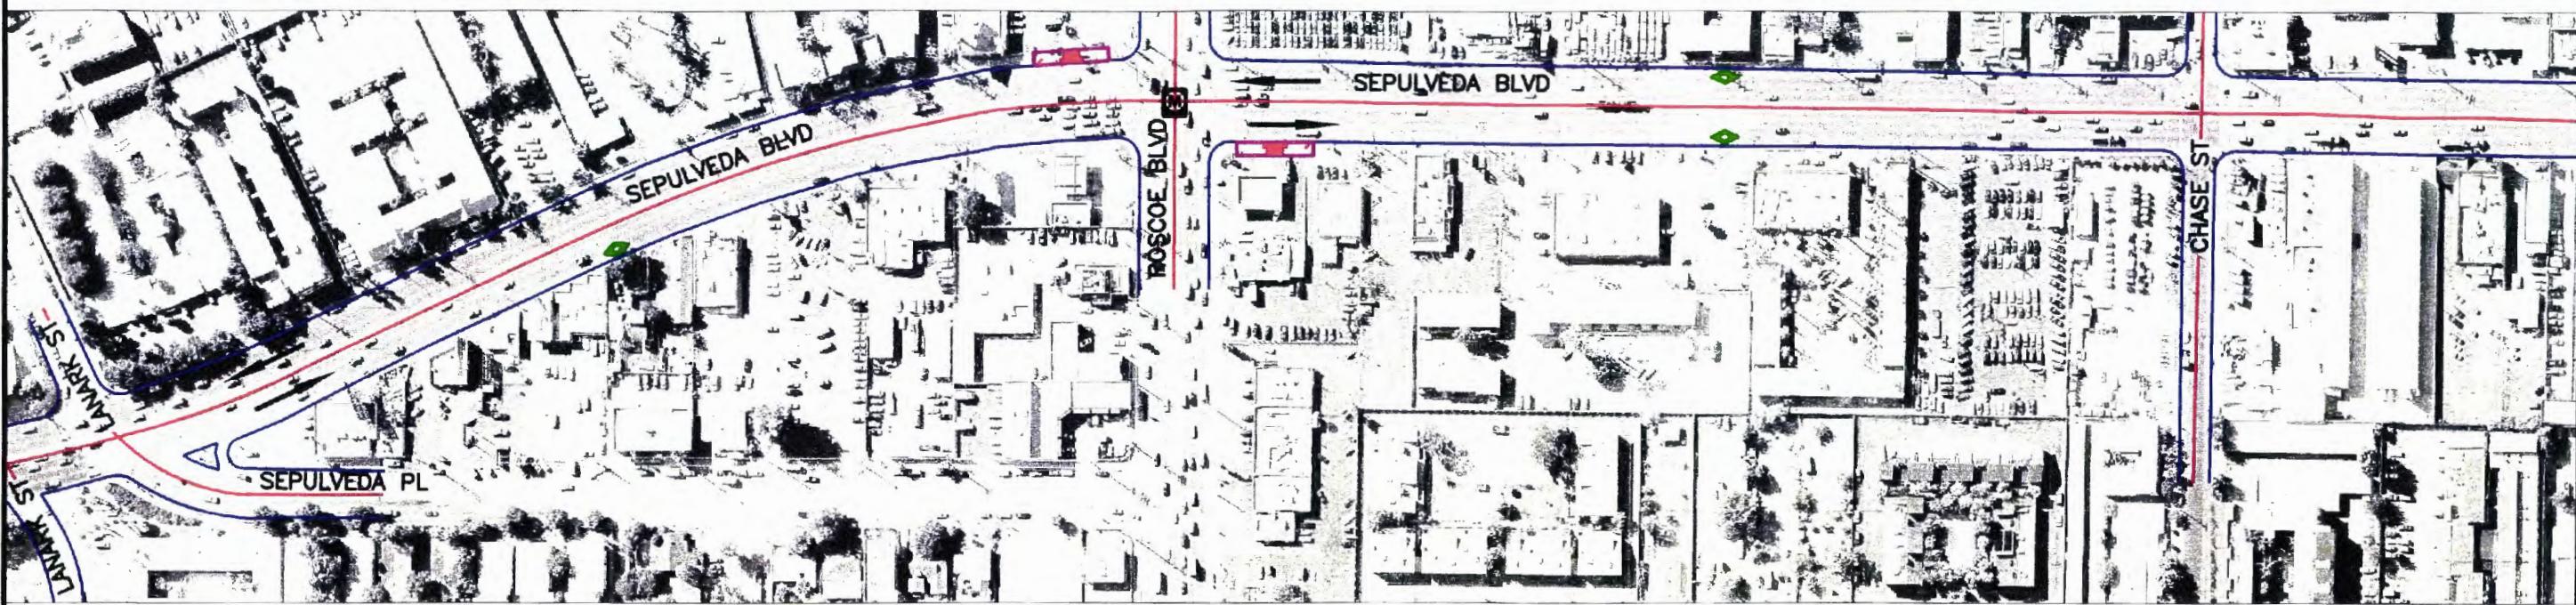END OF SOUTH BOUND
PEAK PERIOD

MATCH LINE SEE SHEET 6

MATCH LINE SEE BELOW LEFT

SCALE: 1"=200'

LEGEND:

- | | | | |
|--|----------------------|--|------------------------|
| | STATION LOCATION | | LANE WIDENING |
| | STOP LOCATION | | EXISTING FREEWAY |
| | PROPOSED BUS STATION | | MAIN DIRECTION OF FLOW |
| | EXISTING STREETS | | EXISTING ELEMENT |
| | EXISTING RAILROAD | | PEAK PERIOD BUS LANE |

SCALE: 1"=200'

0 100 200 600

NOT FOR CONSTRUCTION

CONTRACT NO PS4350-1018	
DRAWING NO	REV 0
SCALE 1"=200'	
SHEET NO 5 OF 10	


DESIGNED BY JAF		LOS ANGELES COUNTY METROPOLITAN TRANSPORTATION AUTHORITY				
DRAWN BY JAF		SAN FERNANDO VALLEY NORTH-SOUTH TRANSITWAY CORRIDOR M.I.S.				
CHECKED BY MT.						
IN CHARGE RRH						
DATE 1/03						
REV DATE BY APP REQ NO EXPIRES SEAL HOLDER	SOLICITATION LEVEL		DESCRIPTION			DATE 1/03

M MEYER, MOHADDES ASSOCIATES, INC.
707 WILSHIRE BLVD., SUITE 4810
LOS ANGELES, CA 90017

HKA CONSULTING ENGINEERS —
PLANNING - DESIGN - SURVEYING
234 DRAKE DRIVE
SAN BERNARDINO, CA 92408
(909) 884-3222 FAX (909) 383-1577

SEPULVEDA BLVD CORRIDOR
VENTURA BLVD TO TRUMAN ST

MATCH LINE SEE SHEET 5

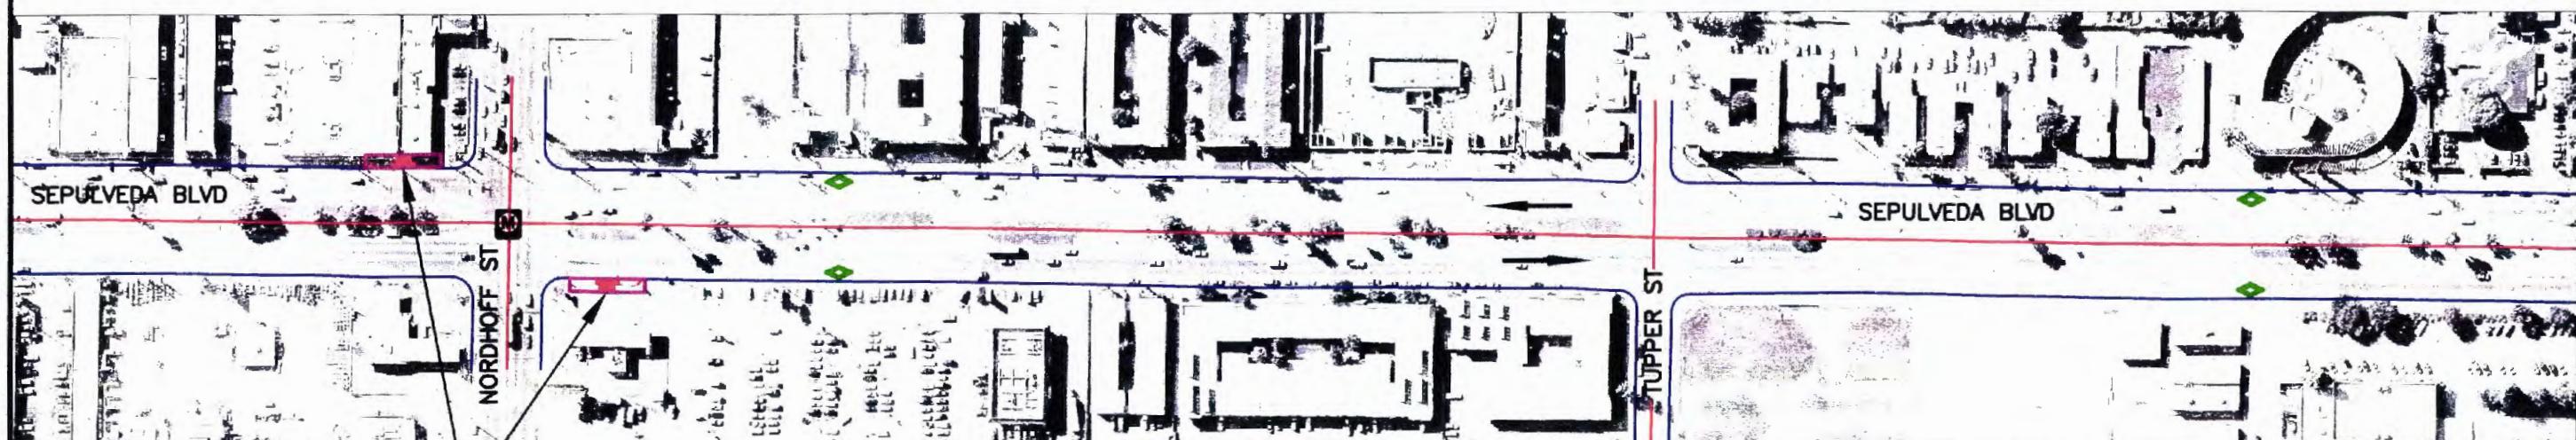

MATCH LINE SEE BELOW LEFT

MATCH LINE SEE ABOVE RIGHT



MATCH LINE SEE SHEET 7

SCALE: 1"=200'

SCALE: 1"=200'

LEGEND:

- | | | | |
|--|-----------------------------------------|--|------------------------|
| | STATION LOCATION | | LANE WIDENING |
| | STOP LOCATION | | MAIN DIRECTION OF FLOW |
| | PROPOSED BUS STATION | | EXISTING ELEMENT |
| | EXISTING STREETS | | PEAK PERIOD BUS LANE |
| | FUTURE EAST-WEST METRO RAPID TRANSITWAY | | EXISTING RIVER/WASH |

0 100 200 600

NOT FOR CONSTRUCTION

0	1/03										
REV	DATE	BY	APP	REG NO	EXPIRES	SEAL HOLDER	SOLICITATION LEVEL				

DESIGNED BY
JAF
DRAWN BY
JAF
CHECKED BY
MT.
IN CHARGE
RRH
DATE
1/03



LOS ANGELES COUNTY METROPOLITAN TRANSPORTATION AUTHORITY
SAN FERNANDO VALLEY NORTH-SOUTH TRANSITWAY CORRIDOR M.I.S.
MEYER, MOHADDES ASSOCIATES, INC
707 WILSHIRE BLVD., SUITE 4810
LOS ANGELES, CA 90017

Hernandez, Kroone
& Associates, Inc.
CONSULTING ENGINEERS
PLANNING - DESIGN - SURVEYING
234 DRAKE DRIVE
SAN BERNARDINO, CA 92408
(909) 884-3222 FAX (909) 383-1577

SEPULVEDA BLVD CORRIDOR
VENTURA BLVD TO TRUMAN ST


CONTRACT NO
PS4350-1018
DRAWING NO
REV
0
SCALE
1"=200'
SHEET NO
6 OF 10

MATCH LINE SEE ABOVE RIGHT

MATCH LINE SEE SHEET 6




MATCH LINE SEE BELOW LEFT

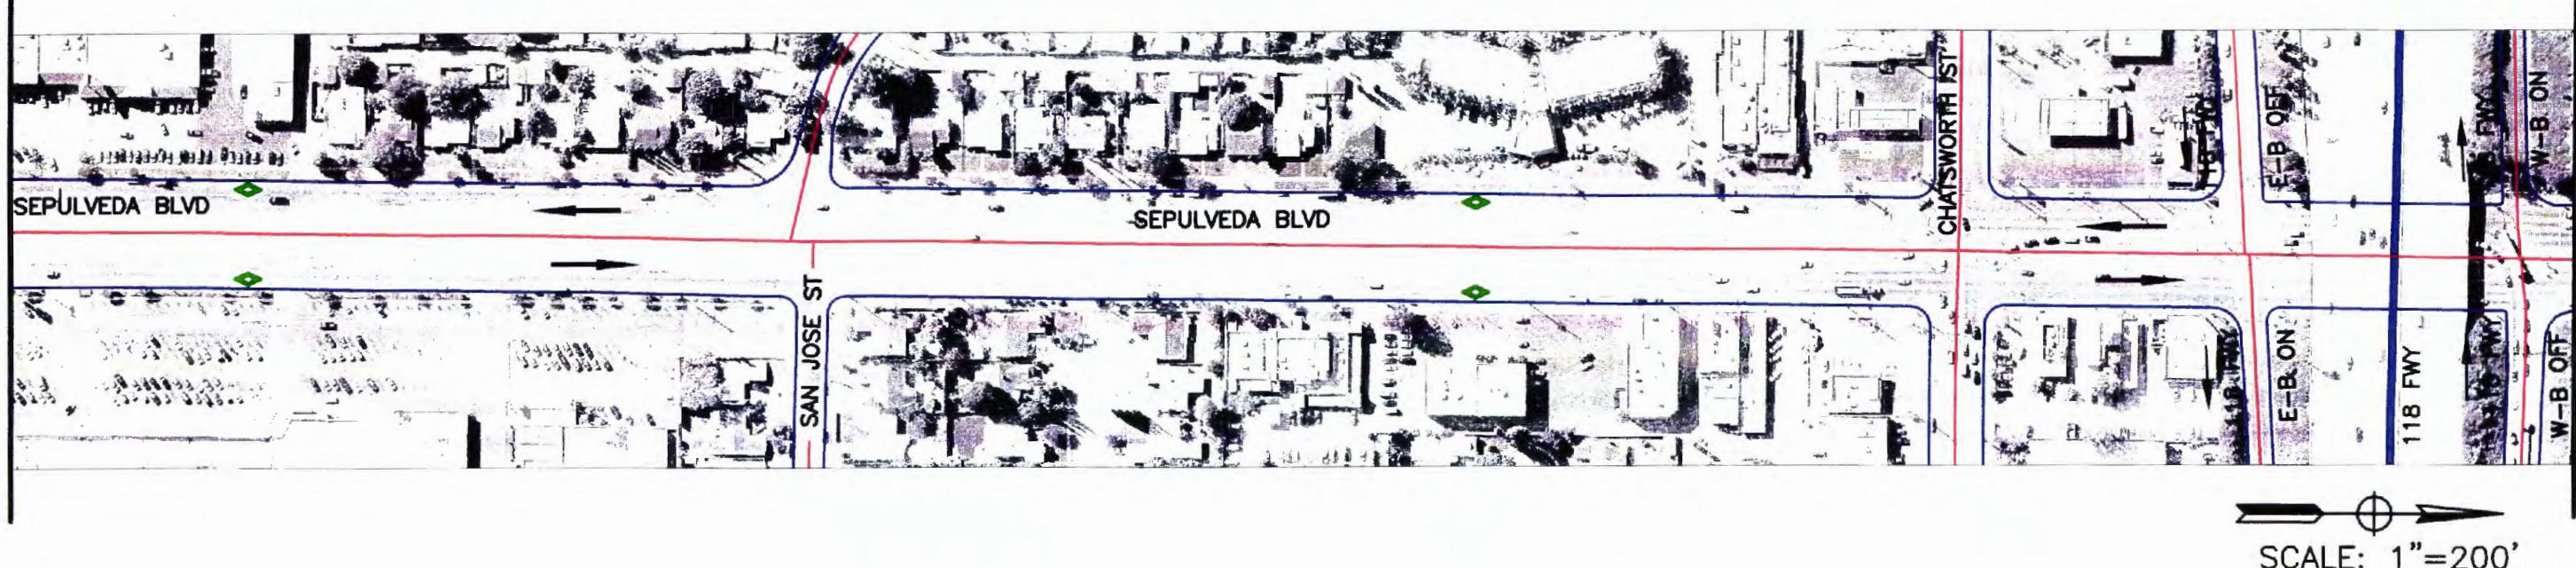

MATCH LINE SEE SHEET 8

LEGEND:

- [M] STATION LOCATION
- [Red Box] STOP LOCATION
- [Red Box with Bus] PROPOSED BUS STATION
- [Blue Line] EXISTING FREEWAY
- [Red Line] EXISTING STREETS
- [Yellow Line] EXISTING RAILROAD
- [Dashed Red Line] FUTURE EAST-WEST METRO RAPID TRANSITWAY
- [Hatched Pattern] LANE WIDENING
- [Solid Blue Line] MAIN DIRECTION OF FLOW
- [Dashed Blue Line] EXISTING ELEMENT
- [Diamond with Bus] PEAK PERIOD BUS LANE
- [Blue Line with River] EXISTING RIVER/WASH

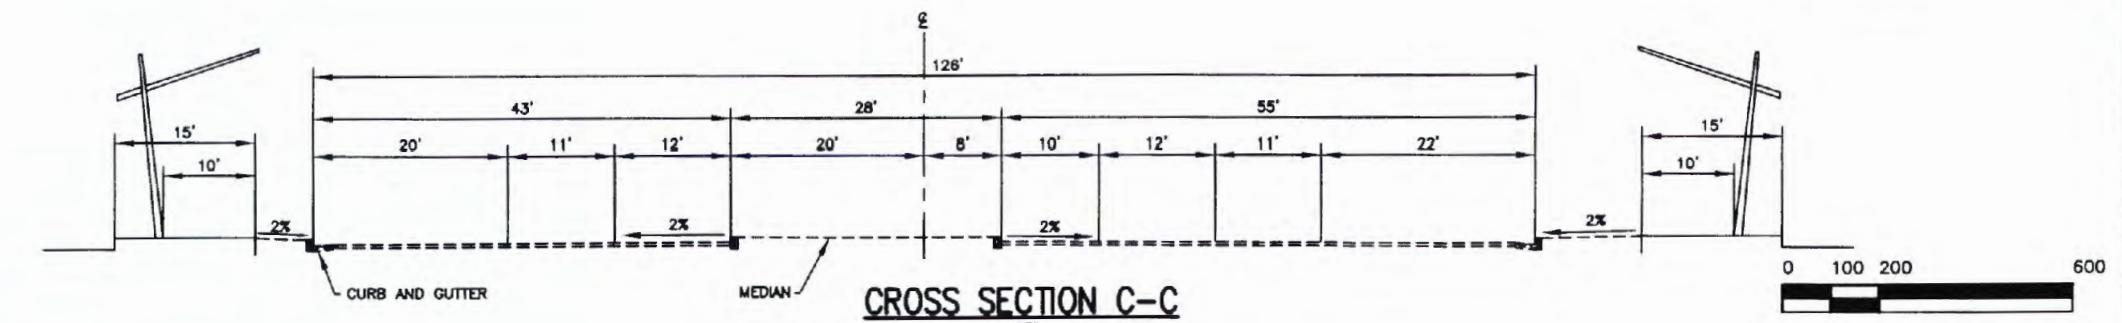

NOT FOR CONSTRUCTION

0	1/03							
REV	DATE	BY	APP	REQ NO	EXPIRES	SEAL HOLDER	SOLICITATION LEVEL	DESCRIPTION

DESIGNED BY JAF
DRAWN BY JAF
CHECKED BY MT.
IN CHARGE RRH
DATE 1/03

M LOS ANGELES COUNTY METROPOLITAN TRANSPORTATION AUTHORITY
SAN FERNANDO VALLEY NORTH-SOUTH TRANSITWAY CORRIDOR M.I.S.
MEYER, MOHADDES ASSOCIATES, INC. 707 WILSHIRE BLVD., SUITE 4810
LOS ANGELES, CA 90017

HKA Hernandez, Kroone & Associates, Inc.
CONSULTING ENGINEERS — PLANNING - DESIGN - SURVEYING
234 DRAKE DRIVE SAN BERNARDINO, CA 92408
(909) 884-3222 FAX (909) 363-1577


SEPULVEDA BLVD CORRIDOR
VENTURA BLVD TO TRUMAN ST

CONTRACT NO
PS4350-1018
DRAWING NO REV 0
SCALE 1"=200'
SHEET NO 7 OF 10

MATCH LINE SEE SHEET 7




LEGEND:

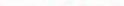	STATION LOCATION		LANE WIDENING
	STOP LOCATION		EXISTING FREEWAY
	PROPOSED BUS STATION		MAIN DIRECTION OF FLOW
	EXISTING STREETS		EXISTING ELEMENT
	EXISTING RAILROAD		PEAK PERIOD BUS LANE
	FUTURE EAST-WEST METRO RAPID TRANSITWAY		EXISTING RIVER/WASH

MATCH LINE SEE ABOVE RIGHT

MATCH LINE SEE BELOW LEFT

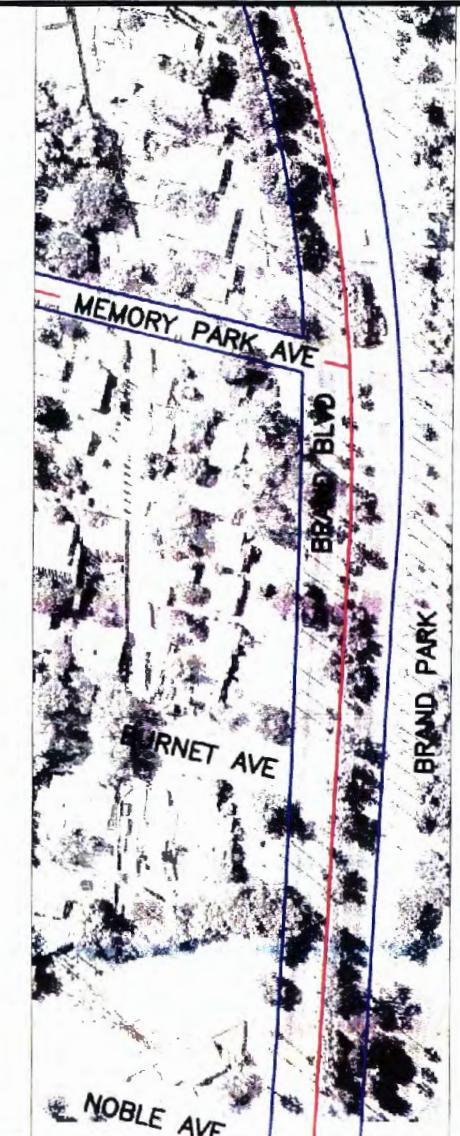

MATCH LINE SEE SHEET 9

SCALE 1" = 200'

0 100 200 600

NOT FOR CONSTRUCTION

							DESIGNED BY JAF	 LOS ANGELES COUNTY METROPOLITAN TRANSPORTATION AUTHORITY SAN FERNANDO VALLEY NORTH-SOUTH TRANSITWAY CORRIDOR M.I.S.	SEPULVEDA BLVD CORRIDOR VENTURA BLVD TO TRUMAN ST			CONTRACT NO PS4350-1018	
							DRAWN BY JAF					DRAWING NO	REV 0
							CHECKED BY MT.					SCALE	1"=200'
							IN CHARGE RRH					SHEET NO	8 OF 10
0	1/03						MAYER, MOHADDES ASSOCIATES, INC					H K A Hernandez, Kroone & Associates, Inc. CONSULTING ENGINEERS — PLANNING - DESIGN - SURVEYING 234 DRAKE DRIVE SAN BERNARDINO, CA 92408 (909) 884-3222 FAX (909) 383-1577	
REV	DATE	BY	APP	REQ NO	EXPIRES	SEAL HOLDER	DESCRIPTION					1/03	

MATCH LINE SEE ABOVE RIGHT

MATCH LINE SEE SHEET 8



MATCH LINE SEE BELOW LEFT

SCALE: 1"=200'

An aerial photograph of a residential neighborhood. The area is filled with single-family homes arranged in a grid pattern. A major street, Grand Boulevard, runs horizontally across the middle of the image. To its left, another street is labeled "BOND BLVD". A small park or green space is visible in the center-left. The image is taken from a high angle, providing a clear view of the urban layout and surrounding greenery.



MATCH LINE SEE SHEET 10



MATCH LINE SEE SHEET 10

LEGEND

- The legend consists of five entries, each with a colored line segment followed by a label:

 - M**: STATION LOCATION (black line)
 - : STOP LOCATION (purple line)
 - : PROPOSED BUS STATION (red line)
 - : EXISTING STREETS (blue line)
 - : EXISTING RIVER/WASH (light blue line)
 - : EXISTING FREEWAY (dark blue line)
 - : MAIN DIRECTION OF FLOW (black arrow)

 SCALE: 1"=200'

0 100 200 600

CONTRACT NO	
PS4350-1018	
DRAWING NO	REV
	0
SCALE	
1"=200'	
SHEET NO	
9 OF 10	


CONTRACT NO	
PS4350-1018	
DRAWING NO	REV
	0
SCALE	
1"=200'	
SHEET NO	
9 OF 10	

0	1/03						SOLICITATION LEVEL		
REV	DATE	BY	APP	REQ NO	EXPIRES	SEAL HOLDER	DESCRIPTION		

**LOS ANGELES COUNTY METROPOLITAN TRANSPORTATION AUTHORITY
SAN FERNANDO VALLEY NORTH-SOUTH TRANSITWAY CORRIDOR M.I.S.**


**SEPULVEDA BLVD CORRIDOR
BRAND BLVD
SEPULVEDA BLVD TO TRUMAN ST**

MATCH LINE SEE SHEET 9

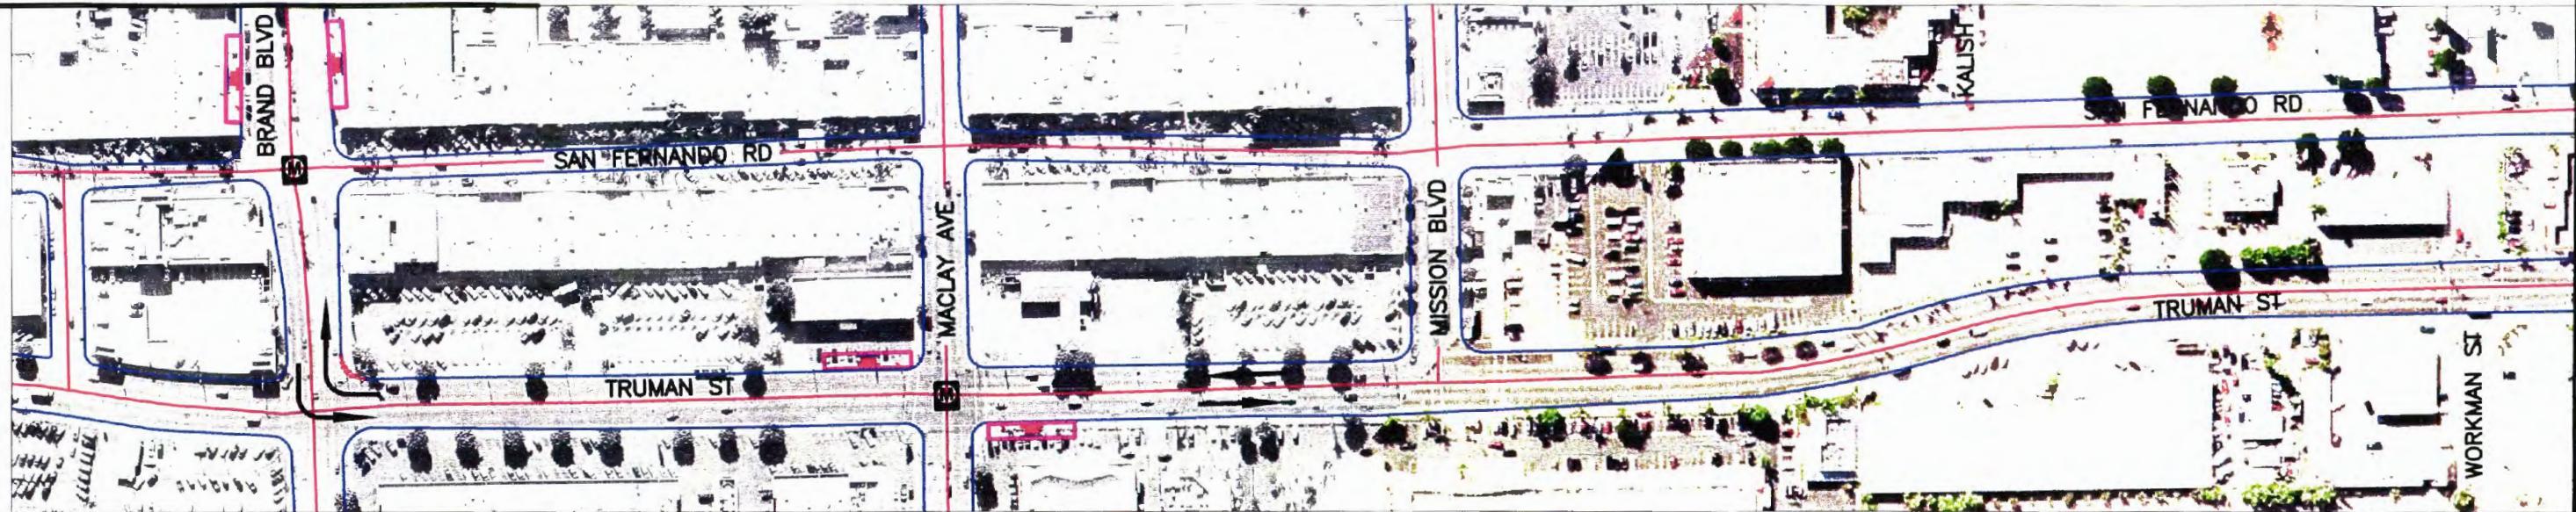

MATCH LINE SEE BELOW LEFT

SCALE: 1"=200'

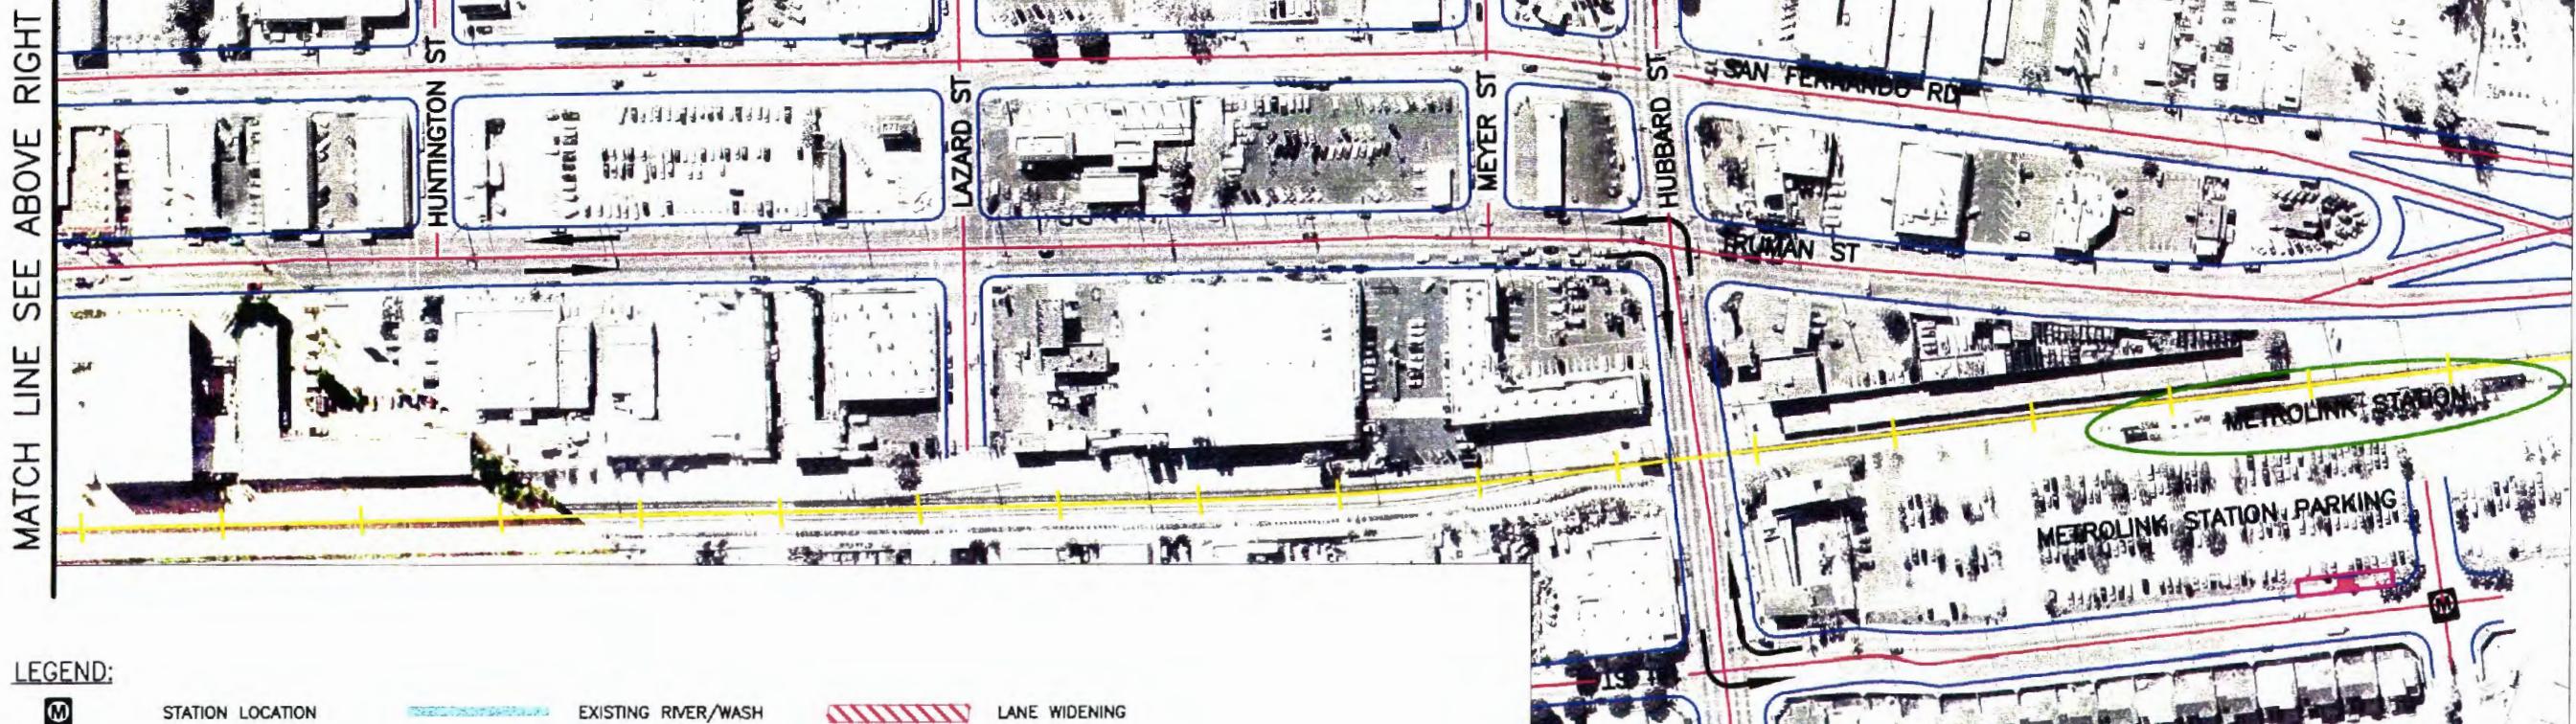

LEGEND:

- | | | | | | |
|--|----------------------|--|------------------------|--|---------------|
| | STATION LOCATION | | EXISTING RIVER/WASH | | LANE WIDENING |
| | STOP LOCATION | | EXISTING FREEWAY | | |
| | PROPOSED BUS STATION | | MAIN DIRECTION OF FLOW | | |
| | EXISTING STREETS | | EXISTING RAILROAD | | |

SCALE: 1"=200'

0 100 200 600

NOT FOR CONSTRUCTION

0	1/03					
REV	DATE	BY	APP	REG NO	EXPIRES	SEAL HOLDER
						SOLICITATION LEVEL
						DESCRIPTION


DESIGNED BY JAF
DRAWN BY JAF
CHECKED BY MT.
IN CHARGE RRH
DATE 1/03

MEYER, MOHADDES ASSOCIATES, INC
707 WILSHIRE BLVD., SUITE 4810
LOS ANGELES, CA 90017

H K A
Hernandez, Kroone
& Associates, Inc.
CONSULTING ENGINEERS
234 DRAKE DRIVE
SAN BERNARDINO, CA 92408
(909) 884-3222 FAX (909) 383-1577

SEPULVEDA BLVD CORRIDOR
TRUMAN ST
BRAND BLVD TO HUBBARD ST

CONTRACT NO
PS4350-1018
DRAWING NO
REV 0
SCALE
1"=200'
SHEET NO
10 OF 10

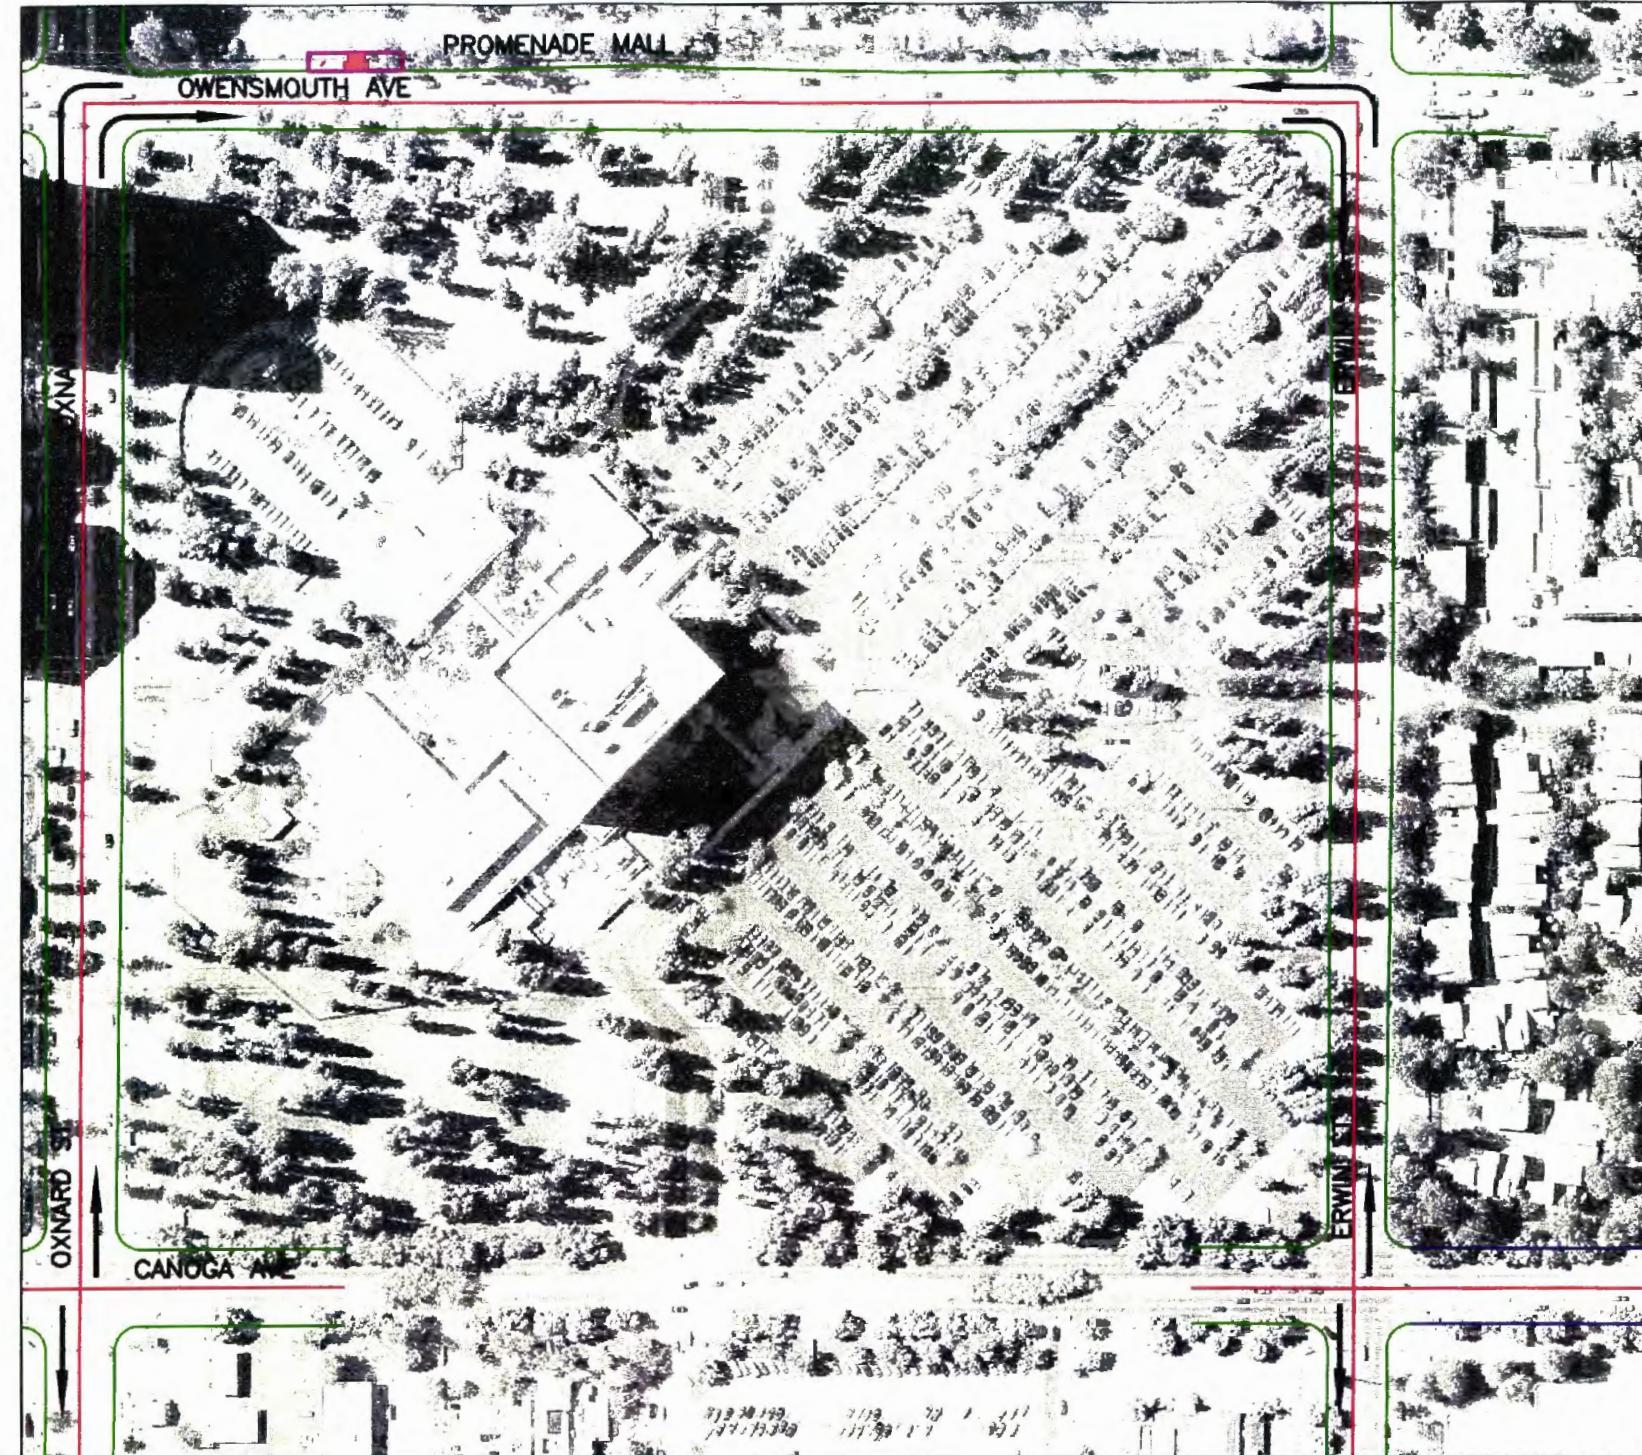

MATCH LINE SEE SHEET 2

SCALE: 1"=200'

0 100 200 600

NOT FOR CONSTRUCTION

DESIGNED BY	JAF
DRAWN BY	JAF
CHECKED BY	MT.
IN CHARGE	RRH
DATE	1/03

SOLICITATION LEVEL	DESCRIPTION
REV DATE BY APP REG NO EXPIRES	SEAL HOLDER

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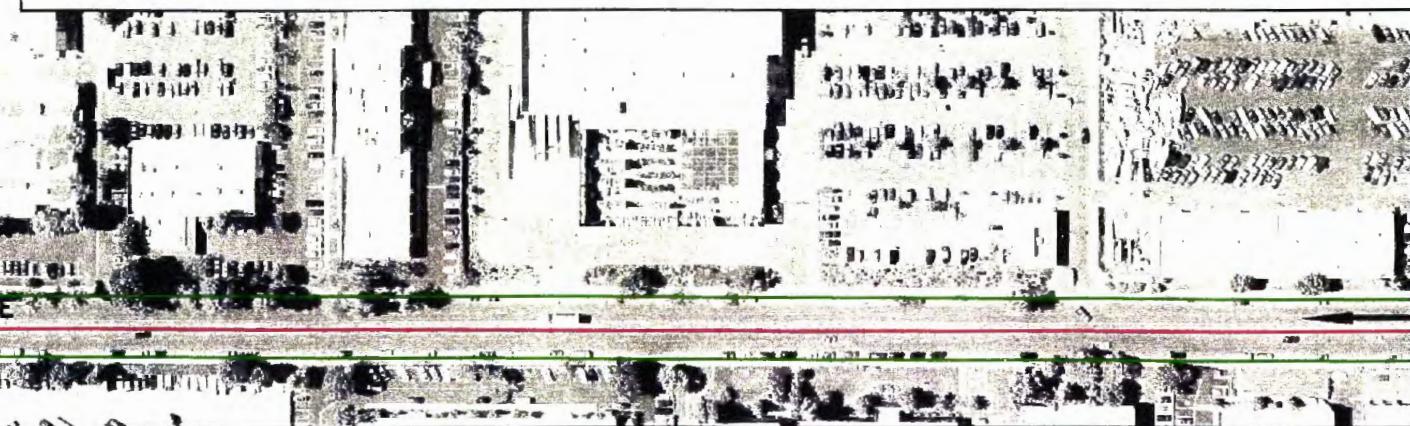
1/03

1/03

1/03

1/03

MATCH LINE SEE SHEET 1



MATCH LINE SEE SHEET 3

SCALE: 1"=200'

LEGEND:

BUS ROUTE

MAIN DIRECTION OF FLOW

0 100 200 600

NOT FOR CONSTRUCTION

DESIGNED BY	JAF
DRAWN BY	JAF
CHECKED BY	MT.
IN CHARGE	RRH
DATE	1/03
REV	0
DATE	1/03
BY	
APP	
REG NO	
EXPIRES	
SEAL HOLDER	
SOLICITATION LEVEL	
DESCRIPTION	

1/03


LOS ANGELES COUNTY METROPOLITAN TRANSPORTATION AUTHORITY
SAN FERNANDO VALLEY NORTH-SOUTH TRANSITWAY CORRIDOR M.I.S.
MEYER, MOHADDES ASSOCIATES, INC
707 WILSHIRE BLVD., SUITE 4810
LOS ANGELES, CA 90017

Hernandez, Kroone & Associates, Inc.
CONSULTING ENGINEERS —
PLANNING - DESIGN - SURVEYING
234 DRAKE DRIVE
SAN BERNARDINO, CA 92408
(909) 884-3222 FAX (909) 383-1577

CANOGA AVE CORRIDOR
OXNARD ST TO LASSEN ST

CONTRACT NO
PS4350-1018
DRAWING NO REV
0
SCALE
1"=200'
SHEET NO
2 OF 7

MATCH LINE SEE SHEET 2

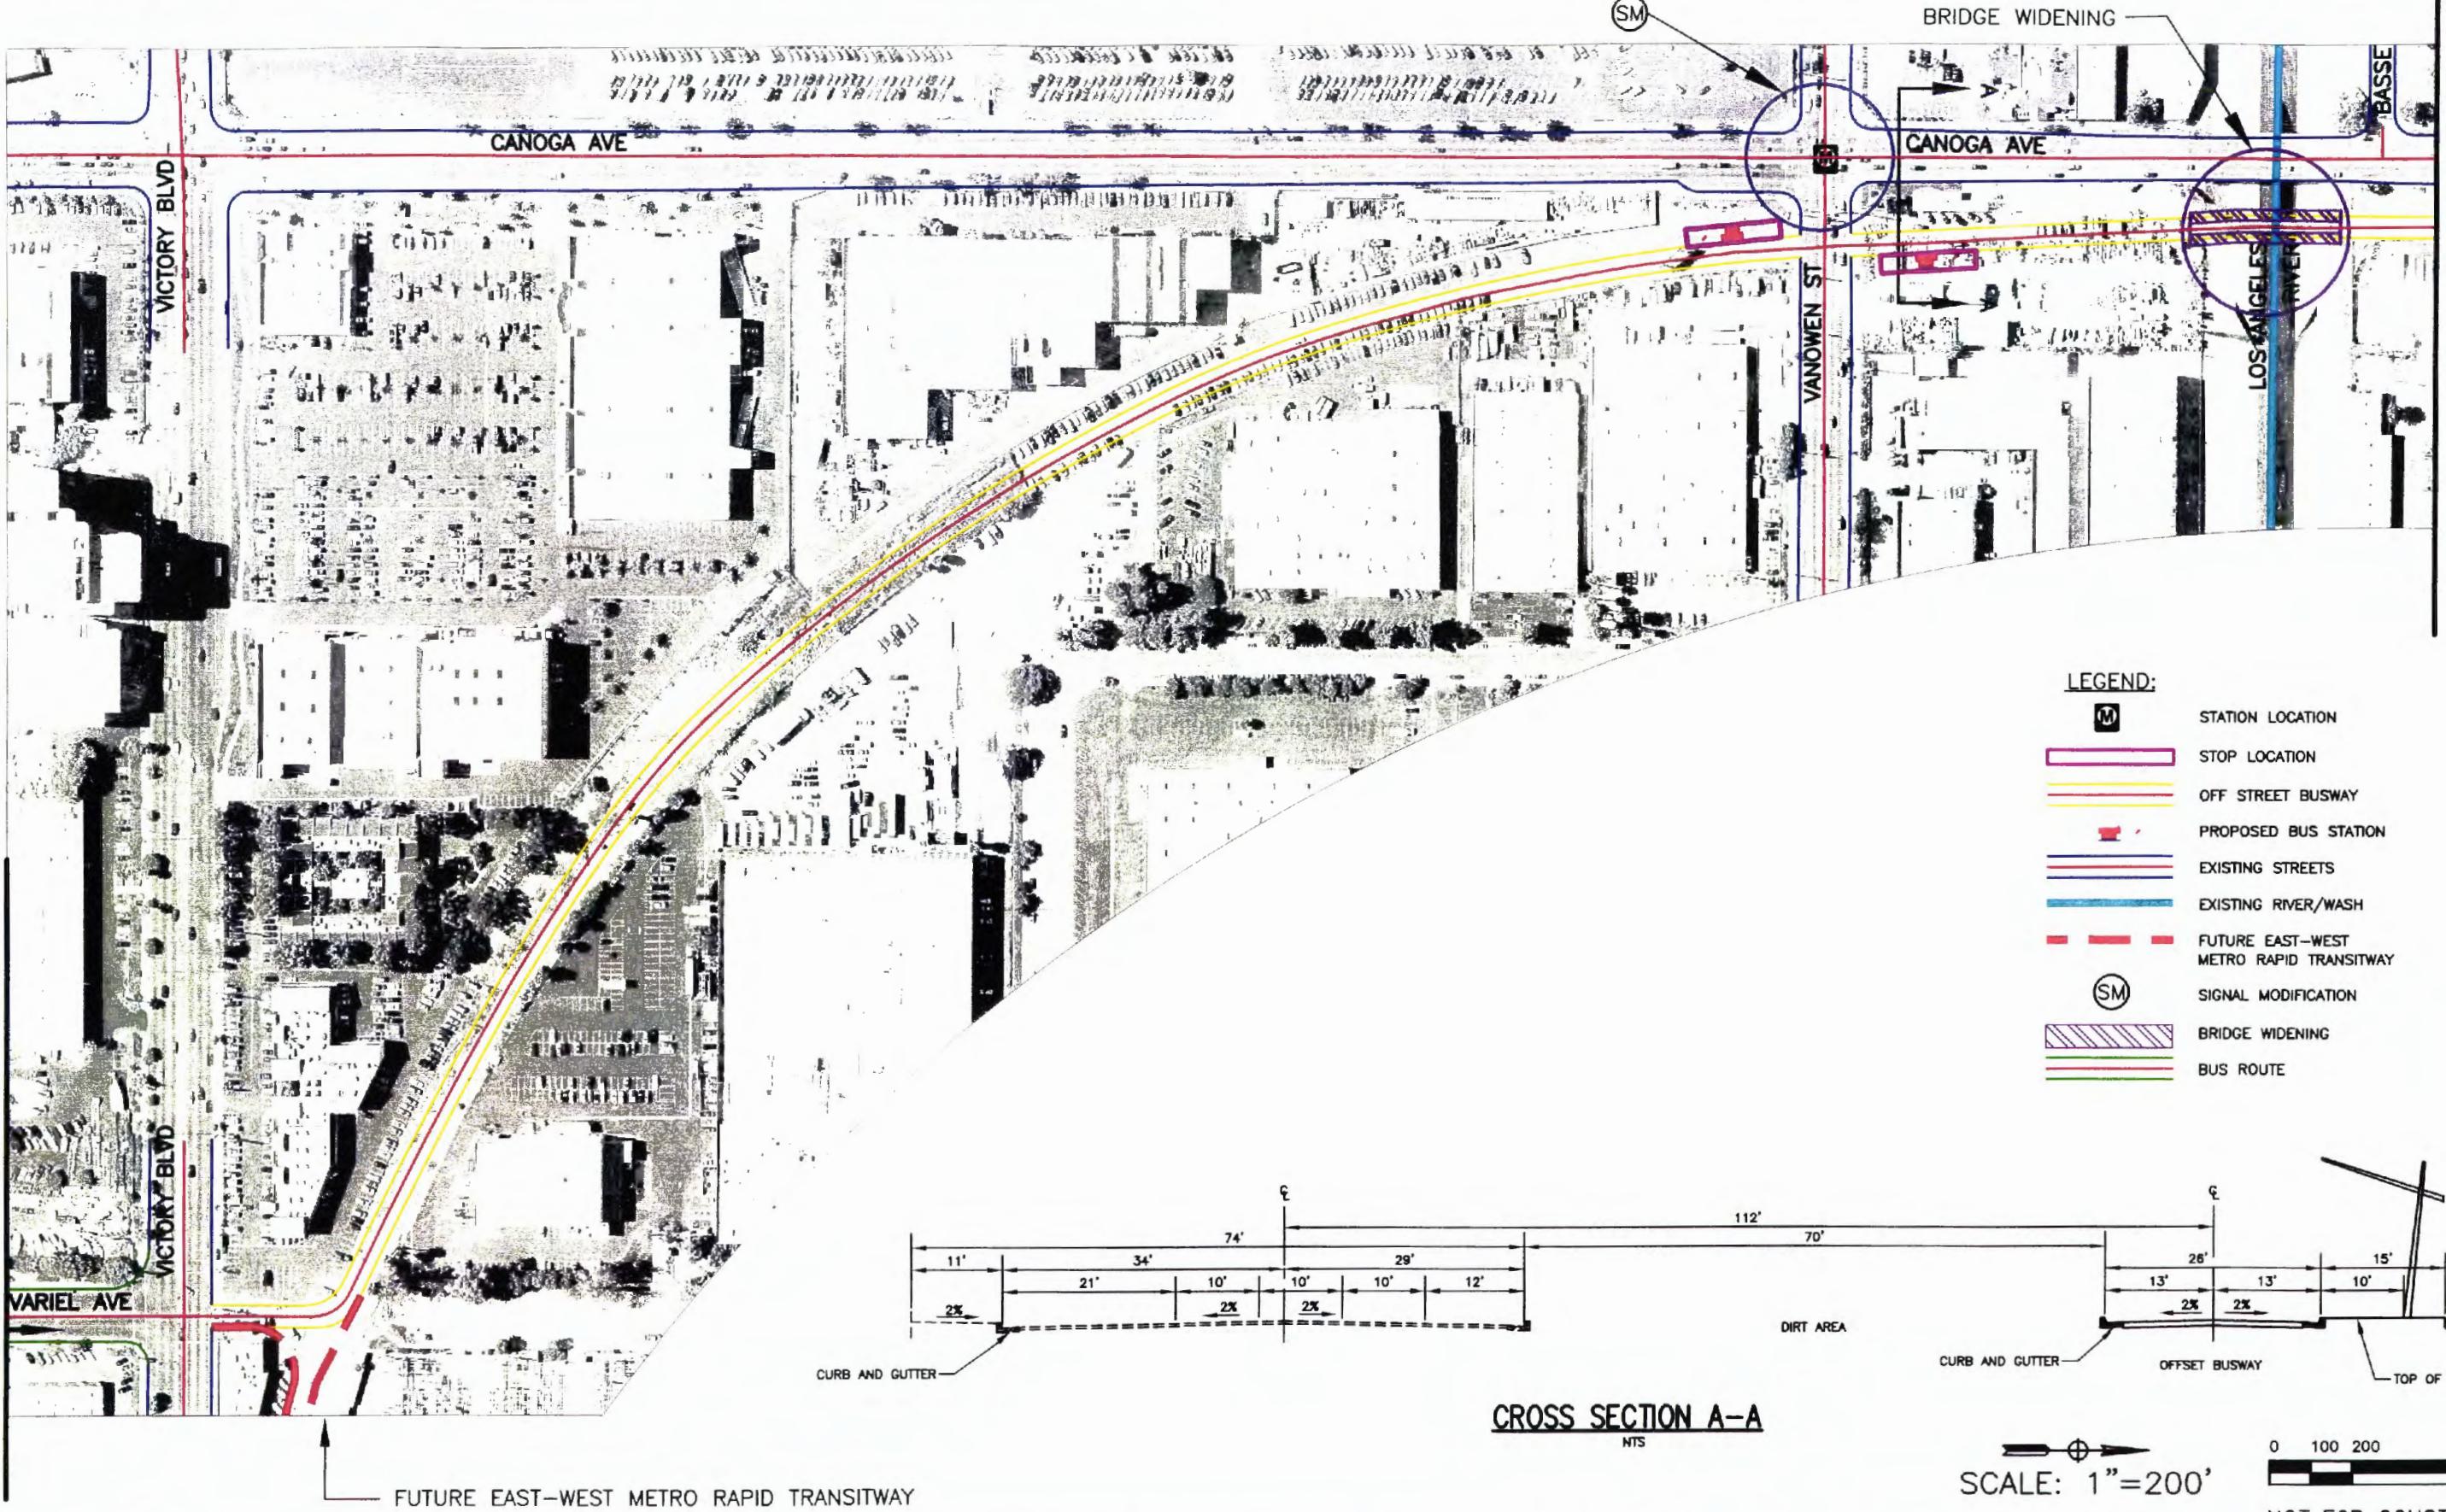

DESIGNED BY	JAF	
DRAWN BY	JAF	
CHECKED BY	MT.	
IN CHARGE	RRH	
DATE	1/03	
REV	0	
APP		
REQ NO		
EXPIRES		
SEAL HOLDER		
SOLICITATION LEVEL		
DESCRIPTION		
DATE	1/03	


LOS ANGELES COUNTY METROPOLITAN TRANSPORTATION AUTHORITY
SAN FERNANDO VALLEY NORTH-SOUTH TRANSITWAY CORRIDOR M.I.S.
M MEYER, MOHADDES ASSOCIATES, INC. 707 WILSHIRE BLVD., SUITE 4810
CONSULTING ENGINEERS — PLANNING — DESIGN — SURVEYING
234 DRAKE DRIVE SAN BERNARDINO, CA 92406
(909) 884-3222 FAX (909) 383-1577

CANOGA AVE CORRIDOR
OXNARD ST TO LASSEN ST

CONTRACT NO	PS4350-101B
DRAWING NO	0
SCALE	1"=200'
SHEET NO	3 OF 7

MATCH LINE SEE ABOVE RIGHT

MATCH LINE SEE SHEET 3

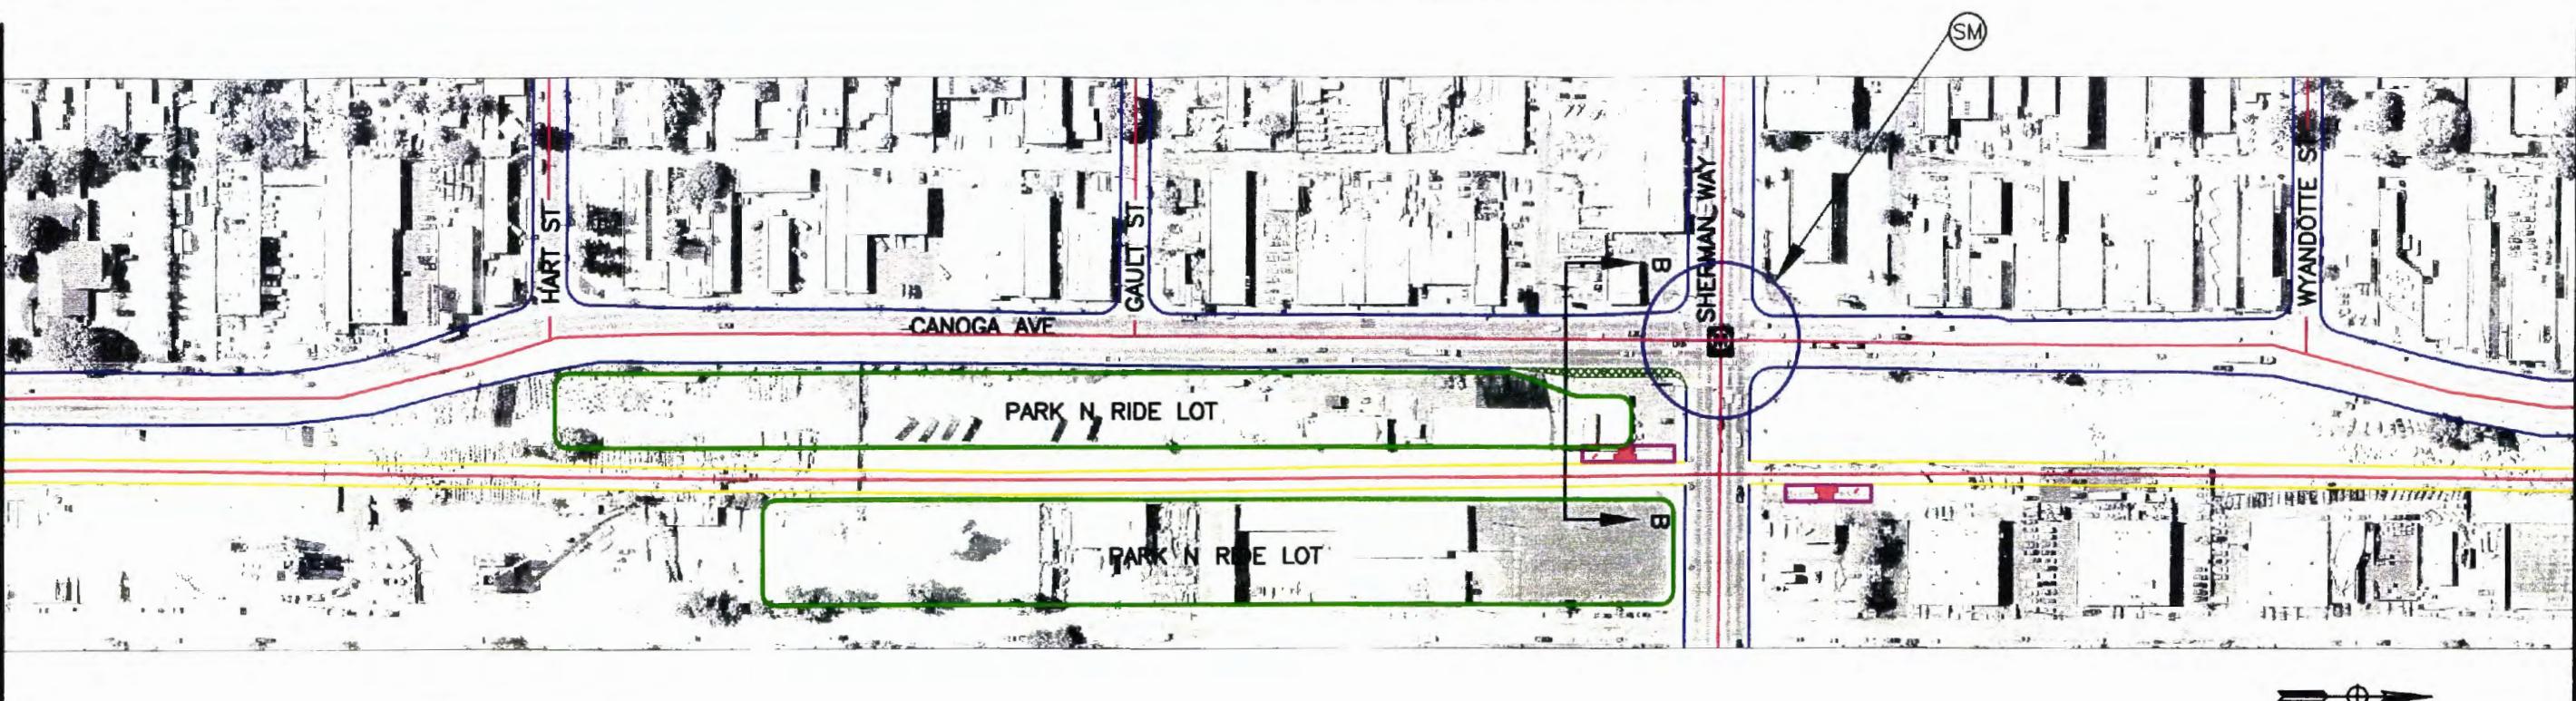


MATCH LINE SEE BELOW LEFT

SCALE: 1"=200'

LEGEND:

	STATION LOCATION		RIGHT TURN LANE WIDENING
	STOP LOCATION		EXISTING STREETS
	OFF STREET BUSWAY		SIGNAL MODIFICATION
	PROPOSED BUS STATION		BIKE LANE

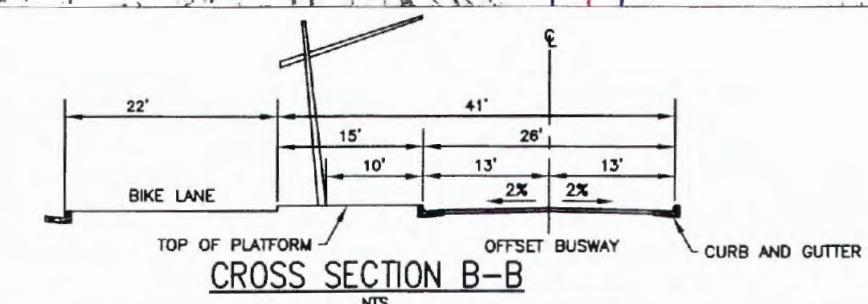

SCALE: 1"=200'

0 100 200

600

NOT FOR CONSTRUCTION

REV	DATE	BY	APP	REQ NO	EXPIRES	SEAL HOLDER	SOLICITATION LEVEL	DESCRIPTION	DATE
0	1/03								1/03

DESIGNED BY
JAF
DRAWN BY
JAF
CHECKED BY
MT.
IN CHARGE
RRH

MEYER, MOHADDES ASSOCIATES, INC
707 WILSHIRE BLVD., SUITE 4810
LOS ANGELES, CA 90017


HKA
Hernandez, Kroone & Associates, Inc.
CONSULTING ENGINEERS
PLANNING DESIGN SURVEYING
234 DRAKE DRIVE
SAN BERNARDINO, CA 92408
(909) 884-3222 FAX (909) 385-1577

CANOGA AVE CORRIDOR
OXNARD ST TO LASSEN ST

CONTRACT NO	PS4350-1018
DRAWING NO	REV 0
SCALE	1"=200'
SHEET NO	4 OF 7

MATCH LINE SEE ABOVE RIGHT

MATCH LINE SEE SHEET 4

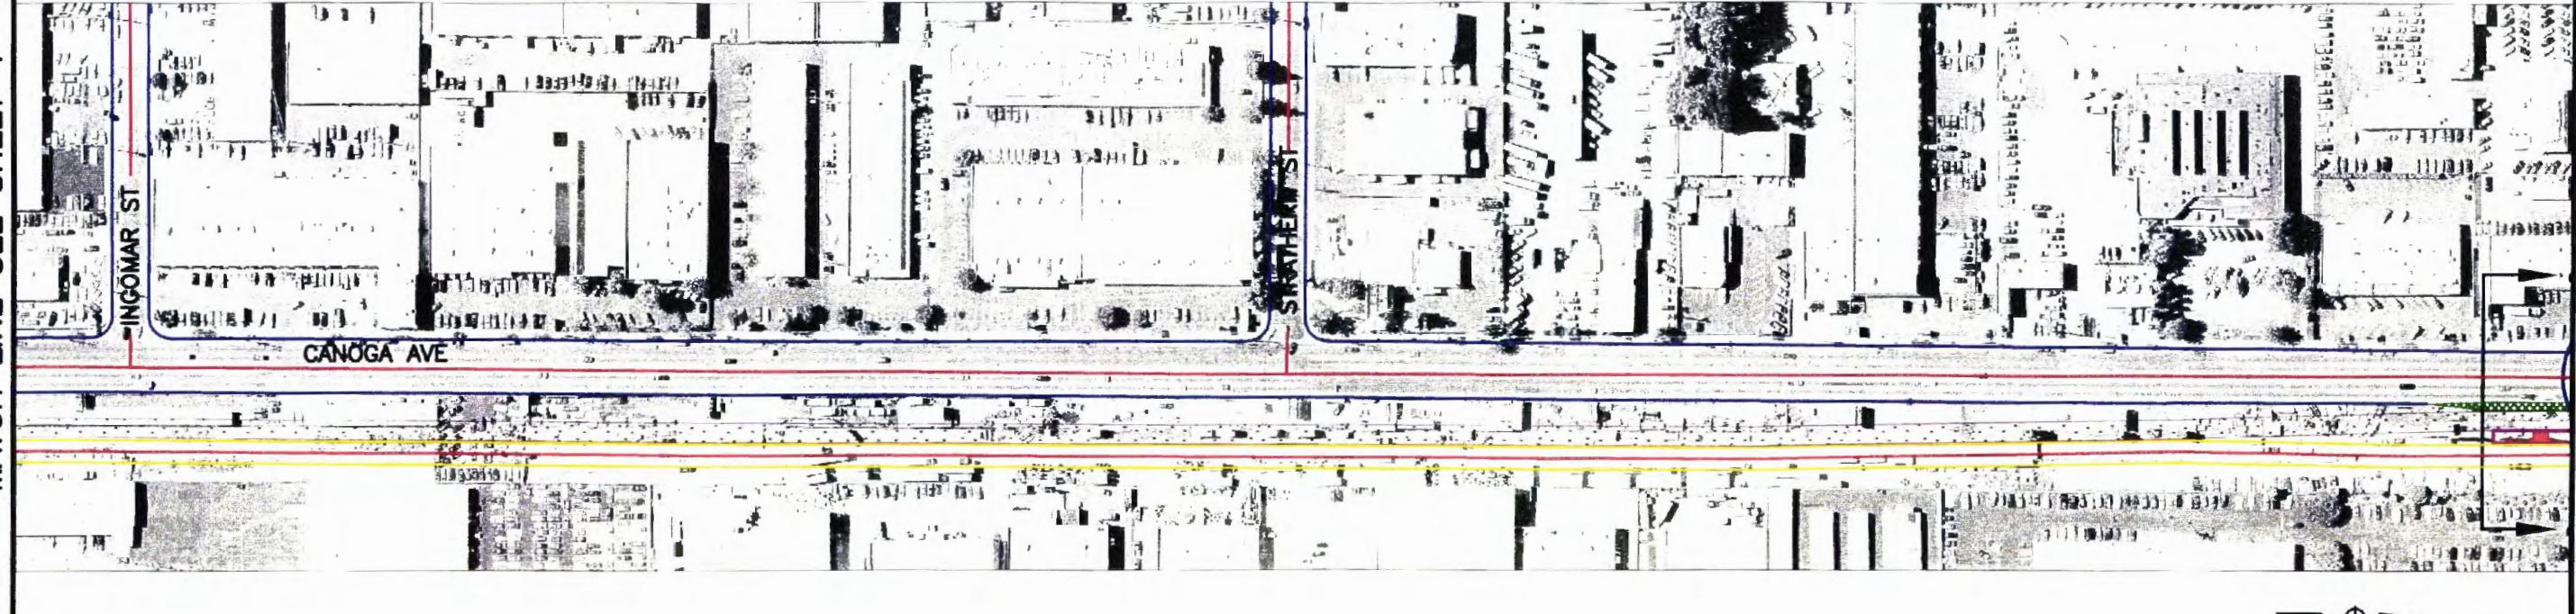


MATCH LINE SEE BELOW LEFT

SCALE: 1"=200'

MATCH LINE SEE ABOVE RIGHT

MATCH LINE SEE SHEET 4

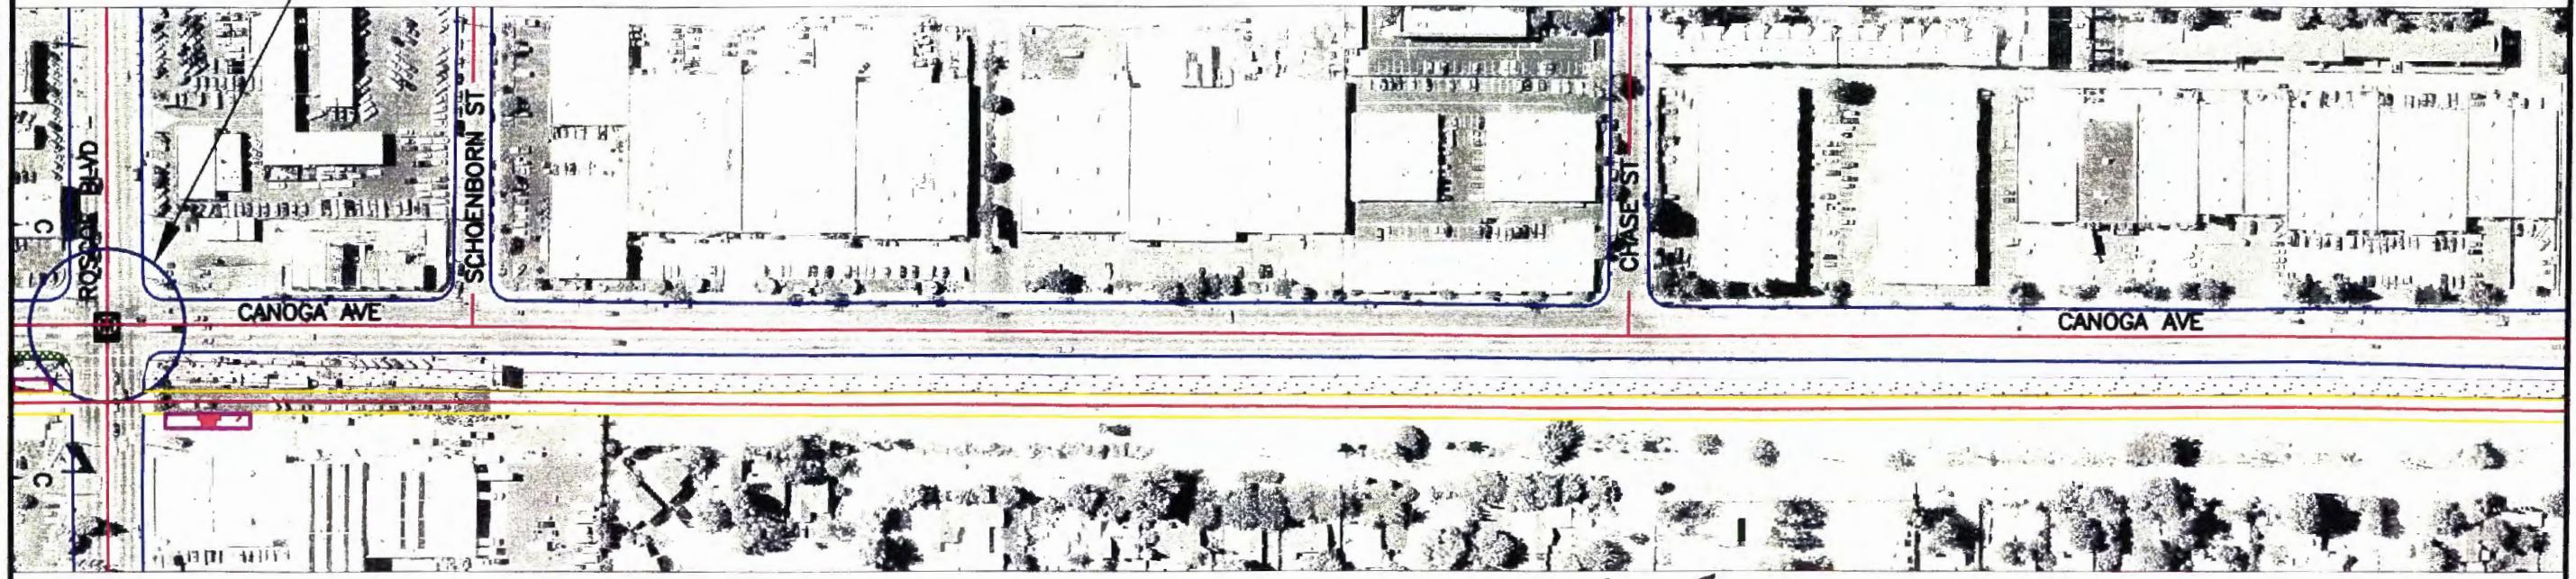

MATCH LINE SEE SHEET 6

LEGEND:

	STATION LOCATION		BIKE LANE
	STOP LOCATION		RIGHT TURN LANE WIDENING
	OFF STREET BUSWAY		EXISTING STREETS
	PROPOSED BUS STATION		SIGNAL MODIFICATION




LOS ANGELES COUNTY METROPOLITAN TRANSPORTATION AUTHORITY
SAN FERNANDO VALLEY NORTH-SOUTH TRANSITWAY CORRIDOR M.I.S.

MEYER, MOHADDES ASSOCIATES, INC
707 WILSHIRE BLVD., SUITE 4810
LOS ANGELES, CA 90017

HKA
Hernandez, Kroone & Associates, Inc.
CONSULTING ENGINEERS —
PLANNING - DESIGN - SURVEYING
234 DRAKE DRIVE
SAN BERNARDINO, CA 92408
(909) 884-3222 FAX (909) 383-1577

CROSS SECTION C-C

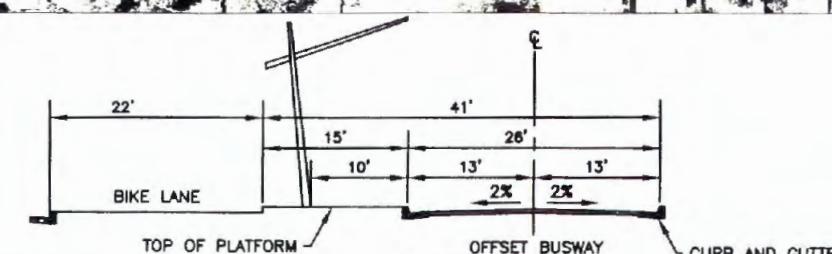

SCALE: 1"=200'

0 100 200

600


NOT FOR CONSTRUCTION

REV	DATE	BY	APP	REG NO	EXPIRES	SEAL HOLDER	SOLICITATION LEVEL	DESCRIPTION	DATE
0	1/03								1/03

CANOGA AVE CORRIDOR
OXNARD ST TO LASSEN ST

CONTRACT NO	PS4350-1018
DRAWING NO	REV 0
SCALE	1"=200'
SHEET NO	5 OF 7


MATCH LINE SEE SHEET 5

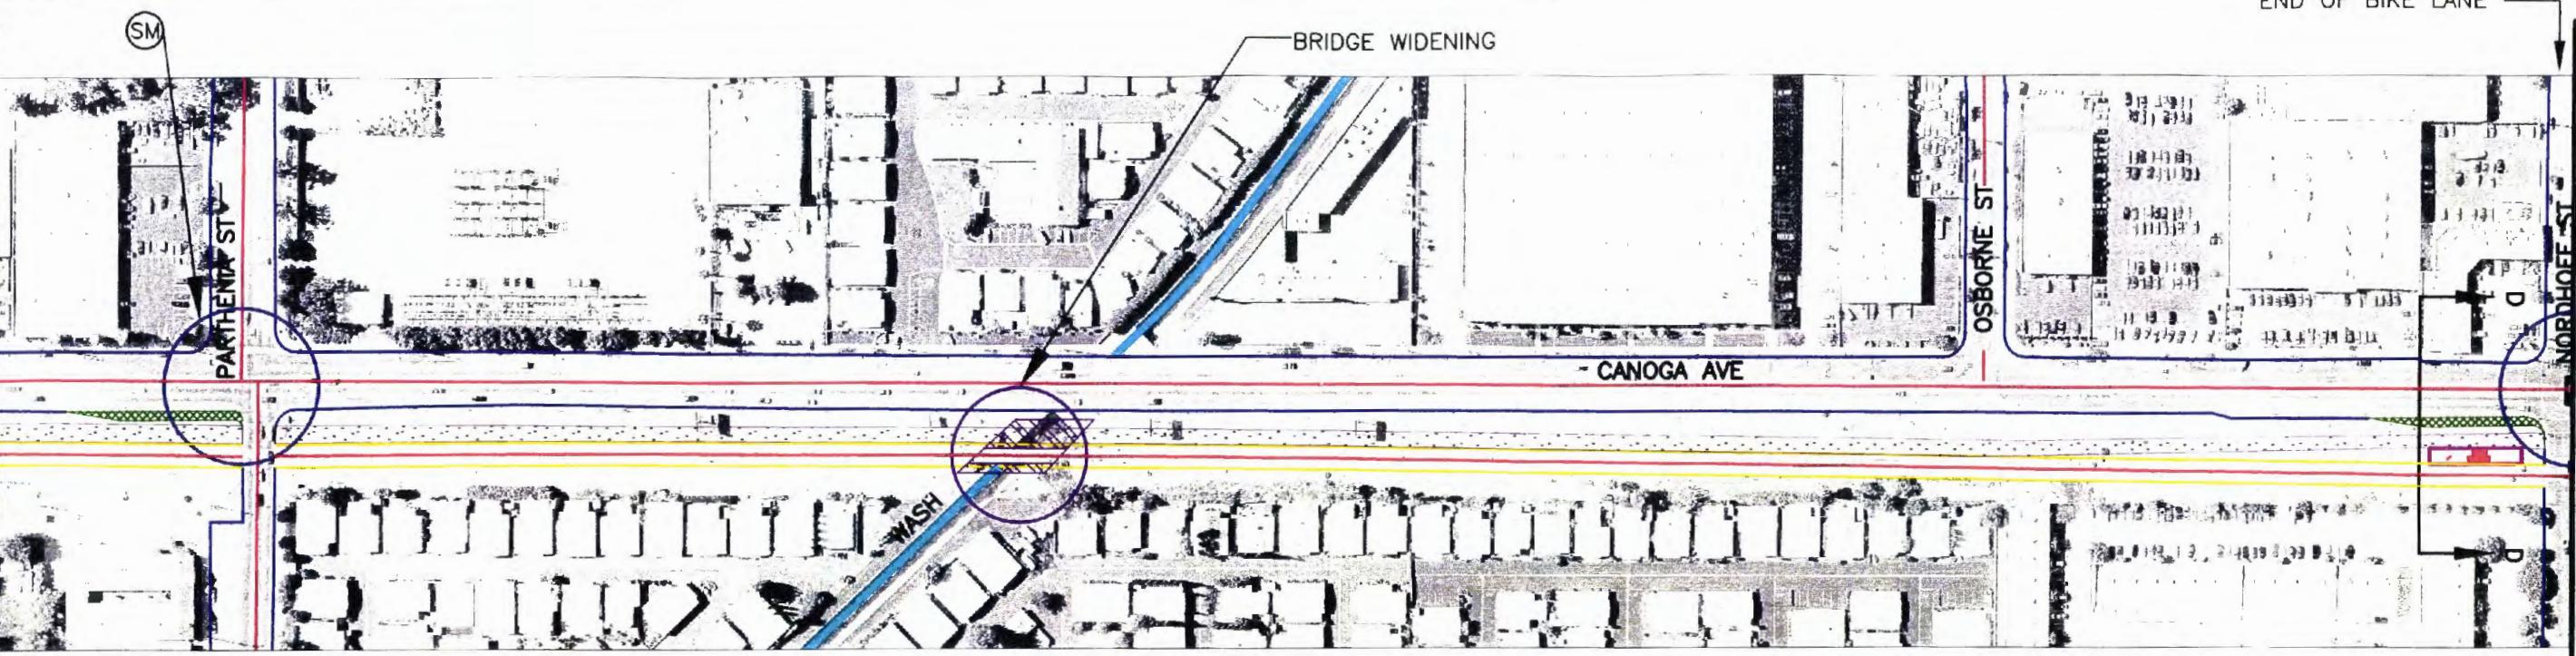

END OF BIKE LANE

MATCH LINE SEE BELOW LEFT


MATCH LINE SEE ABOVE RIGHT

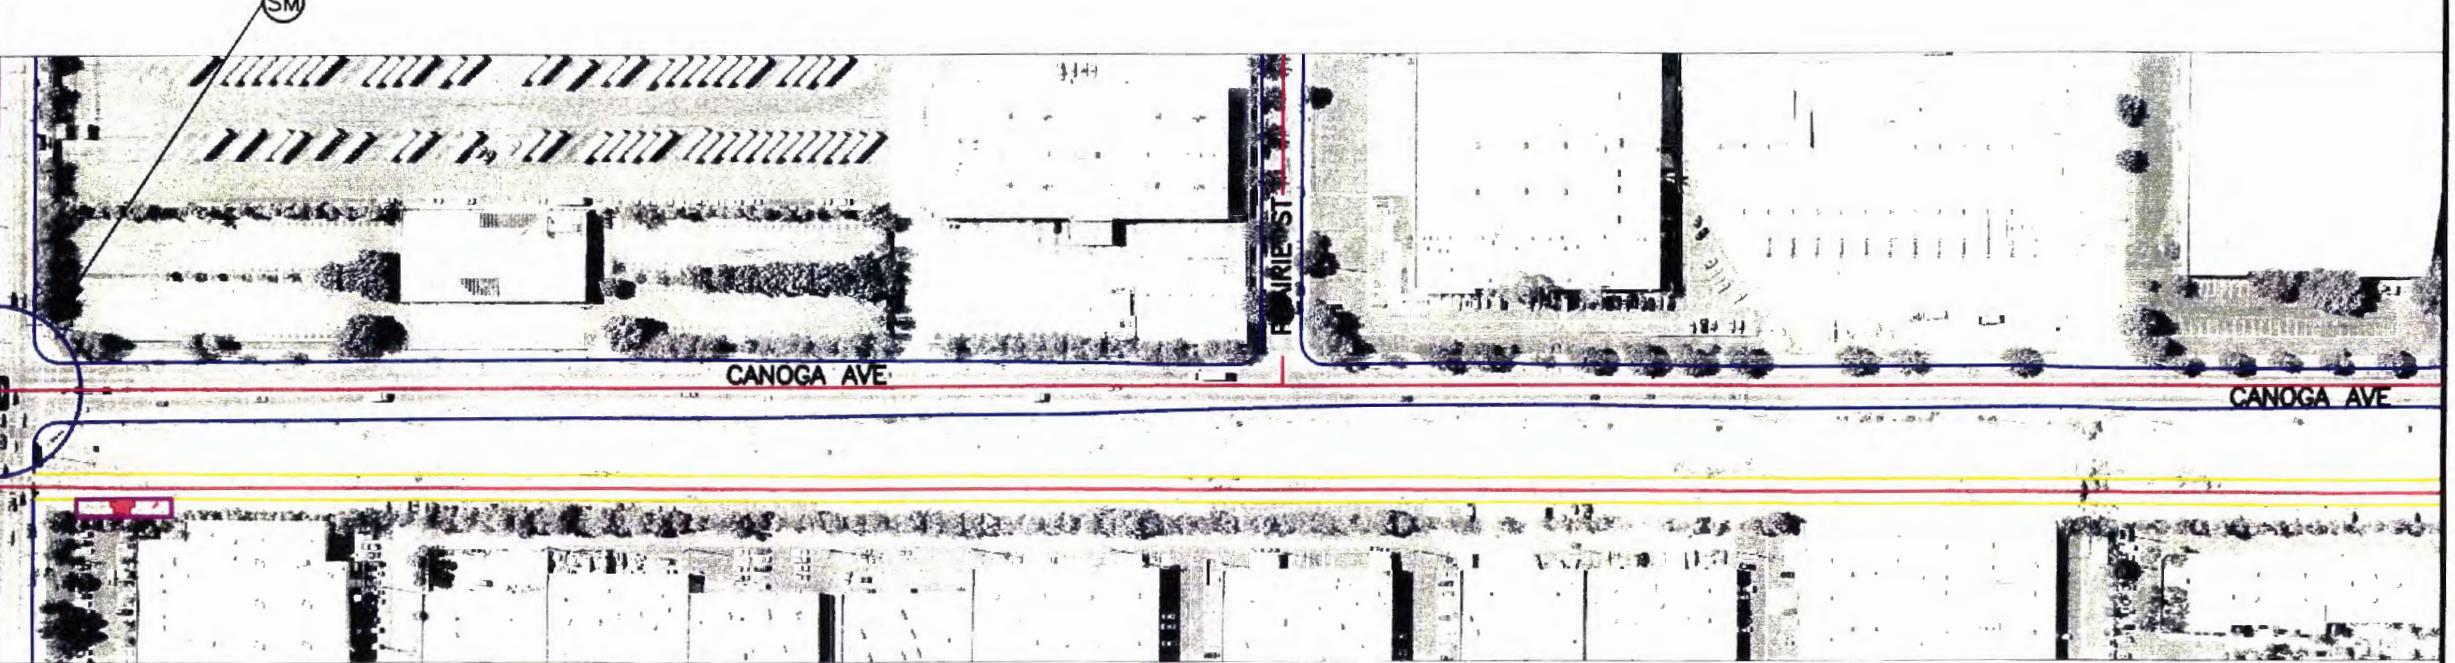

MATCH LINE SEE SHEET 7

LEGEND:

	STATION LOCATION		RIGHT TURN LANE WIDENING
	STOP LOCATION		EXISTING STREETS
	OFF STREET BUSWAY		EXISTING RIVER/WASH
	PROPOSED BUS STATION		BIKE LANE
	BRIDGE WIDENING		SIGNAL MODIFICATION

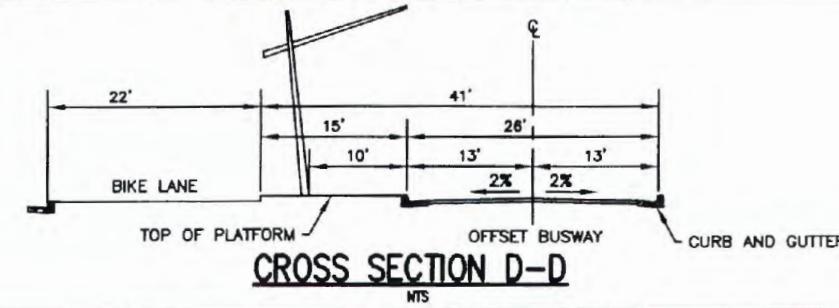

SCALE: 1"=200'

0 100 200
600

CONTRACT NO	PS4350-1018
DRAWING NO	REV 0
SCALE	1"=200'
HEET NO	6 OF 7



LOS ANGELES COUNTY METROPOLITAN TRANSPORTATION AUTHORITY
SAN FERNANDO VALLEY NORTH-SOUTH TRANSITWAY CORRIDOR M.I.S.




MEYER, MOHADDES ASSOCIATES, INC.
707 WILSHIRE BLVD., SUITE 4810
LOS ANGELES, CA 90017

HKA
CONSULTING ENGINEERS — SURVEYING
234 DRAKE DRIVE
SAN BERNARDINO, CA 92408
(909) 884-3222 FAX (909) 383-1577

CANOGA AVE CORRIDOR
OXNARD ST TO LASSEN ST

0	1/03	SOLICITATION LEVEL	DATE	DESCRIPTION
REV	DATE	BY APP REG NO	EXPIRES	SEAL HOLDER

MATCH LINE SEE SHEET 6

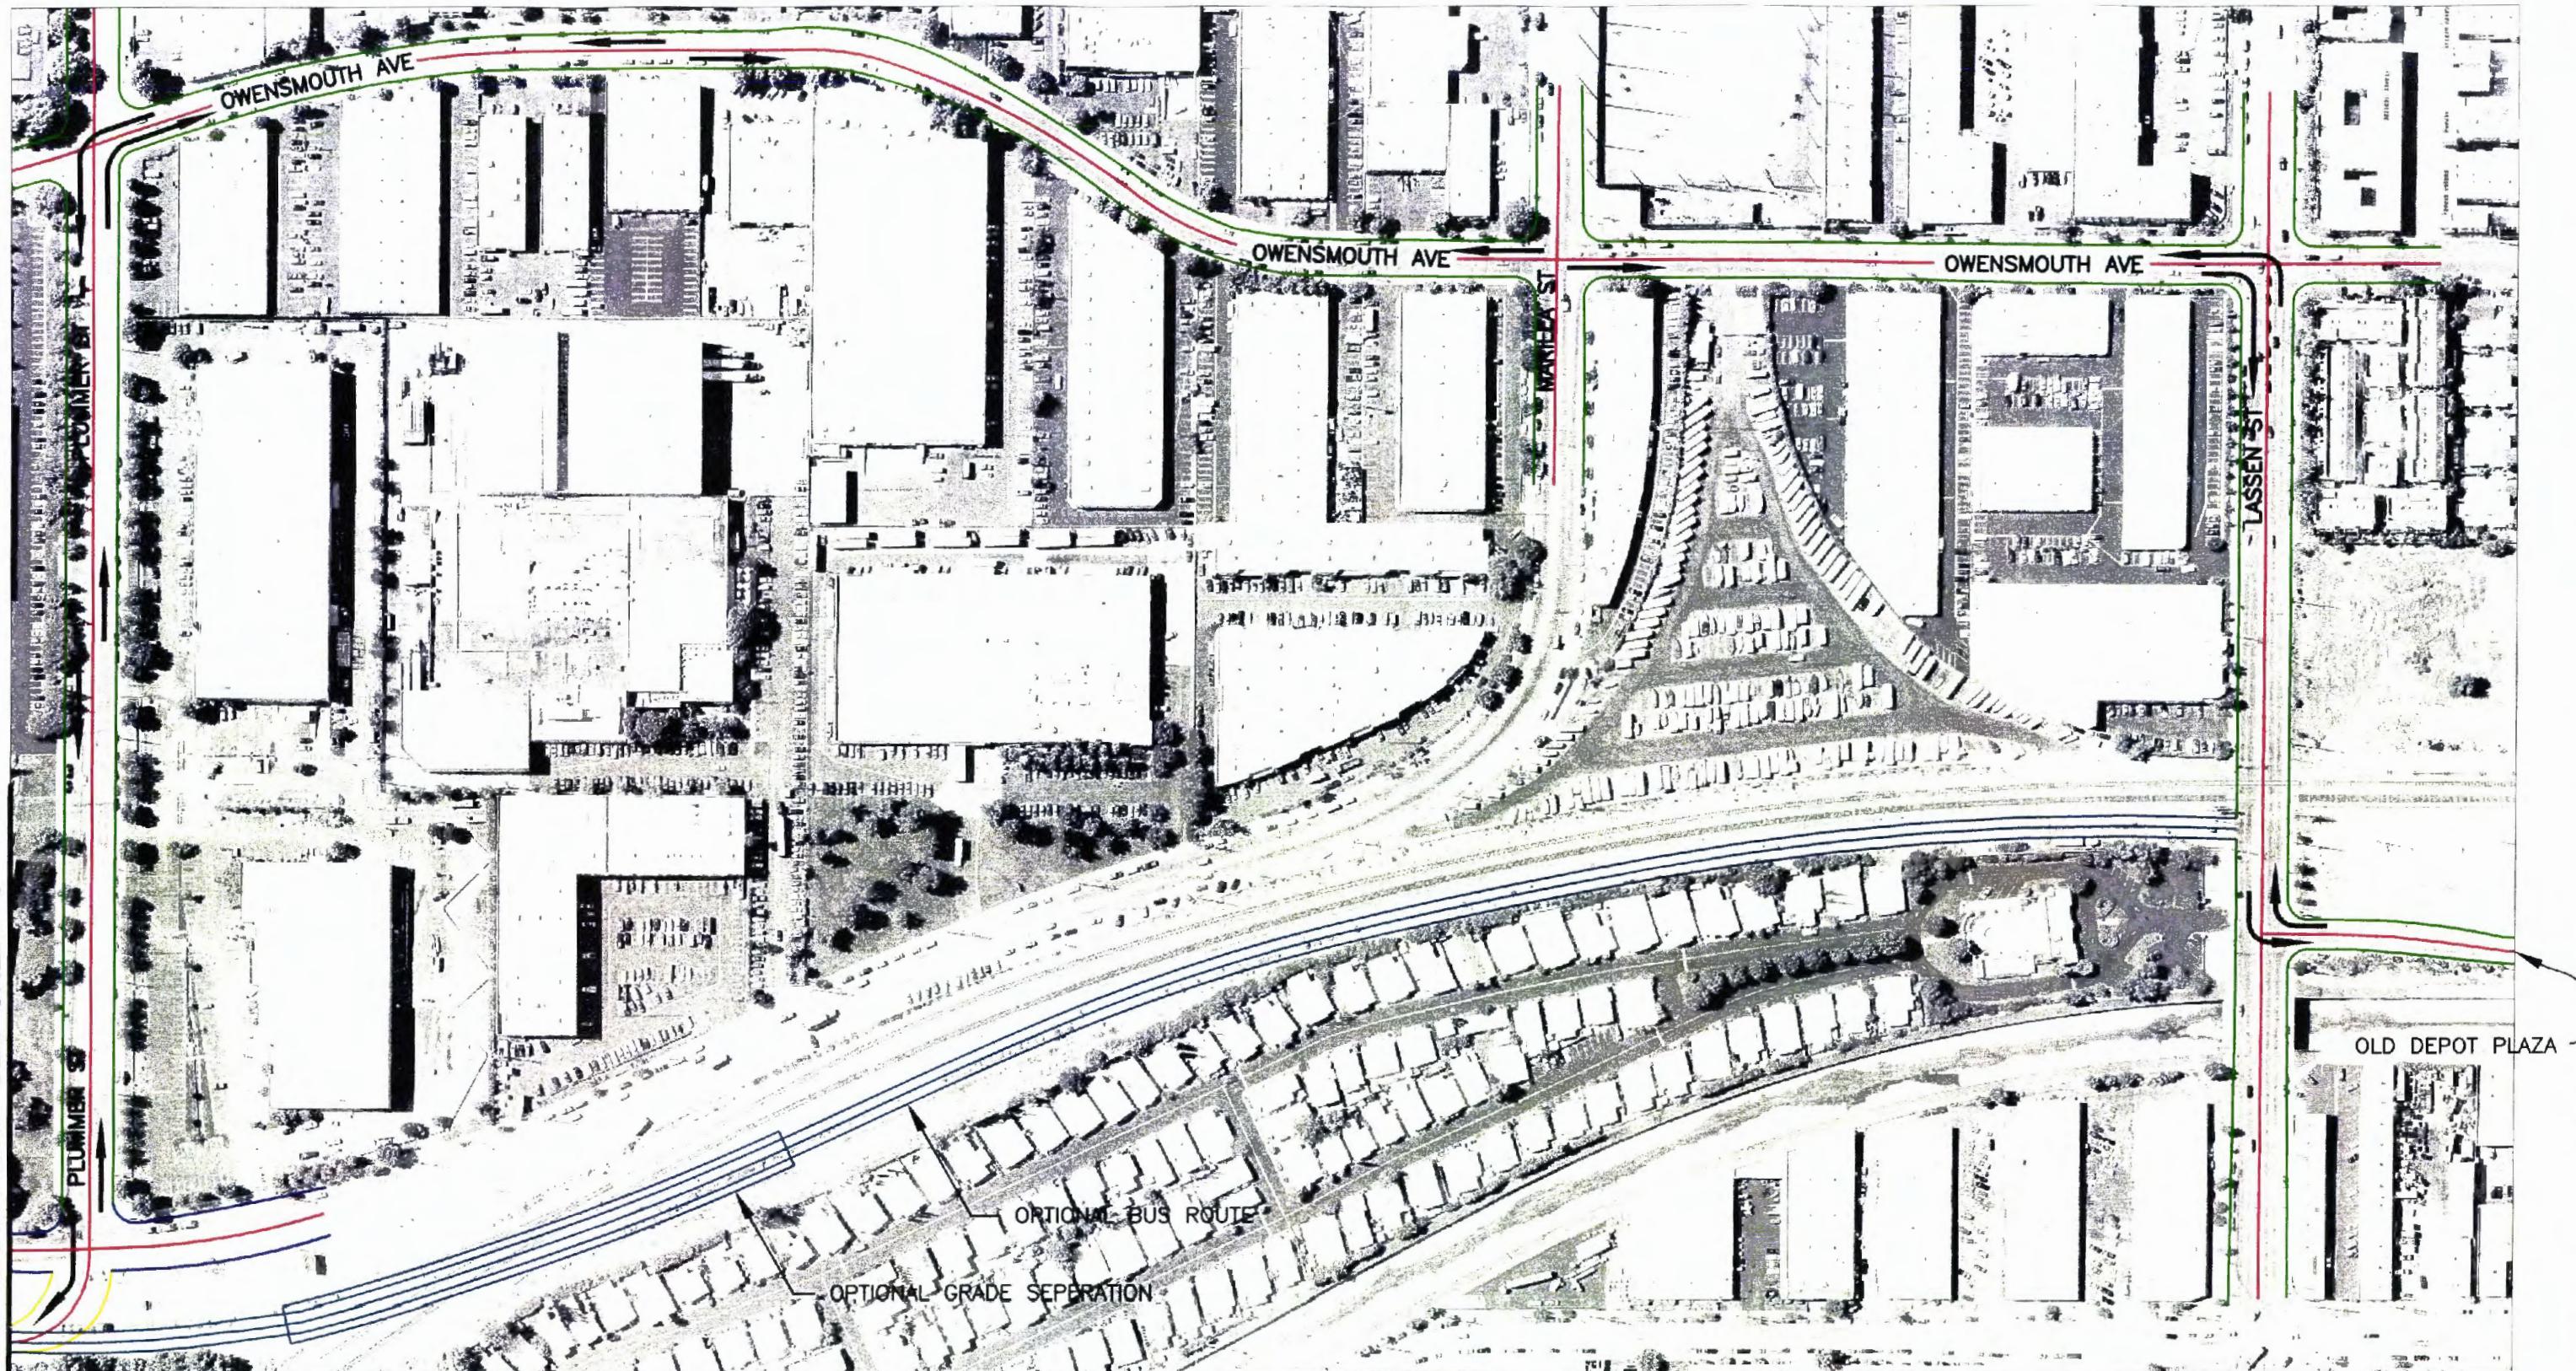

LEGEND:

BUS ROUTE

OFF STREET BUSWAY

MAIN DIRECTION OF FLOW

ALTERNATIVE BUS ROUTE W/GRADE SEPARATION

EXISTING STREETS

0 100 200
600

SCALE: 1"=200'

NOT FOR CONSTRUCTION

								DESIGNED BY JAF
								DRAWN BY JAF
								CHECKED BY MT.
								IN CHARGE RRH
0	1/03							
REV	DATE	BY	APP	REQ NO	EXPIRES	SEAL HOLDER	SOLICITATION LEVEL	DATE 1/03

	LOS ANGELES COUNTY METROPOLITAN TRANSPORTATION AUTHORITY SAN FERNANDO VALLEY NORTH-SOUTH TRANSITWAY CORRIDOR M.I.S.
MEYER, MOHADDES ASSOCIATES, INC 707 WILSHIRE BLVD., SUITE 4810 LOS ANGELES, CA 90017	HKA Hernandez, Kroone & Associates, Inc. CONSULTING ENGINEERS — PLANNING — DESIGN — SURVEYING 234 DRAKE DRIVE SAN BERNARDINO, CA 92408 (909) 884-3222 FAX (909) 383-1577

CANOCA AVE CORRIDOR
OXNARD ST TO LASSEN ST

CONTRACT NO PS4350-1018	REV 0
DRAWING NO	
SCALE 1"=200'	
SHEET NO 7 OF 7	

Appendix C

Cost Estimates



**San Fernando Valley
North-South Transit Corridor
Regionally Significant Transportation Investment Study**

PROJECT DESCRIPTION: Lankershim Boulevard-San Fernando Road Corridor

Limits: Lankershim Boulevard at Hollywood Freeway north to San Fernando Road, San Fernando Road north to Hubbard Street

Proposed Improvement:

SUMMARY OF PROJECT COST ESTIMATE

TOTAL ROADWAY ITEMS	\$4,143,800
ALTERNATIVE COST: ADDITIONAL 5' ROADWAY WIDENING	\$1,091,618
TOTAL STRUCTURE ITEMS: RED LINE PORTAL	\$11,500,000
STATION ELEMENTS	\$1,940,000
URBAN DESIGN ENHANCEMENTS TOTAL	\$5,010,000
SUBTOTAL BASE CONSTRUCTION COSTS	\$6,083,800
SUBTOTAL ENHANCED CONSTRUCTION COSTS	\$17,601,618
RIGHT OF WAY	\$0
EQUIPMENT: CORRIDOR BUSES	\$9,100,000
EQUIPMENT: FEEDER BUSES	\$31,200,000
MAINTENANCE FACILITY CONTRIBUTION	\$27,500,000
TOTAL PROJECT BASE CAPITAL OUTLAY COSTS	\$73,883,800
TOTAL PROJECT COSTS (BASE + ENHANCED)	\$91,485,418

I. ROADWAY ITEMS

<u>Section 1 Earthwork</u>	Length	Width	Quantity	Unit	Unit Price	Item Cost	Section Cost
Road Excavation	0	0	0	cy	\$35	\$0	
Imported Borrow	0	0	0	cy	\$30	\$0	
Clearing, Grubbing & Demolition	0	0	0	sf	\$2.00	\$0	
Remove AC			0	cf	\$64	\$0	
Develop Water Supply (Per m3 earthwork)			0	cf	\$0	\$0	
					Subtotal 1 Earthwork		\$0

<u>Section 1 Earthwork, 5' Additional Widening at south end</u>	Length	Width	Quantity	Unit	Unit Price	Item Cost	Section Cost
Road Excavation	4,500	5	1,250	cy	\$35	\$43,750	
Imported Borrow	0	0	0	cy	\$30	\$0	
Clearing, Grubbing & Demolition	4,500	5	22,500	sf	\$2.00	\$45,000	
Remove AC			0	cf	\$64	\$0	
Develop Water Supply (Per m3 earthwork)			0	cf	\$0	\$0	
					Subtotal 1 Earthwork		\$88,750

<u>Section 2 Pavement Structural Section*</u>		Quantity	Unit	Unit Price	Item Cost	Section Cost
Asphalt Concrete, 0.5 feet thick	0	0	0	ton	\$150	\$0
Aggregate Base, 1 foot thick	0	0	0	cy	\$50	\$0
PCC Curb & Gutter	0		0	lf	\$30	\$0
Minor Concrete Sidewalk	0	0	0	cf	\$5	\$0
					Subtotal 2 Pavement Items	\$0

<u>Section 2 Pavement Structural Section* 5'</u>		Quantity	Unit	Unit Price	Item Cost	Section Cost
<u>Additional Widening at south end</u>						
Asphalt Concrete, 0.5 feet thick	4,500	5	810	ton	\$150	\$121,500
Aggregate Base, 1 foot thick	4,500	5	833	cy	\$50	\$41,650
PCC Curb & Gutter	4,500		4,500	lf	\$30	\$135,000
Minor Concrete Sidewalk	4,500	8	18,000	cf	\$5	\$90,000
					Subtotal 2 Pavement Items	\$388,150

<u>Section 3 Drainage</u>		Quantity	Unit	Unit Price	Item Cost	Section Cost
Large Drainage Facilities		0	ea	\$0	\$0	
Storm Drains		0	ea	\$0	\$0	
Storm Water Pollution Prevention Plan		1	ea	\$10,000	\$10,000	
Project Drainage		0	ea	\$0	\$0	
					Subtotal 3 Drainage	\$10,000

Section 3 Drainage 5' Additional Widening
at south end

	Quantity	Unit	Unit Price	Item Cost	Section Cost
Large Drainage Facilities	0	ea	\$0	\$0	
Storm Drains	0	ea	\$0	\$0	
Storm Water Pollution Prevention Plan	0	ea	\$7,500	\$7,500	
Project Drainage	0	ea	\$200,000	\$200,000	
			Subtotal 3 Drainage		\$207,500

Section 4 Specialty Items

	Quantity	Unit	Unit Price	Item Cost	Section Cost
Retaining Walls	0	ls	\$0	\$0	
Noise Barriers	0	ls	\$0	\$0	
Barriers and Guardrails	0	ls	\$0	\$0	
Replacement Planting	0	ls	\$0	\$0	
Irrigation Modification	0	ls	\$10,000	\$10,000	
Relocate Utilities	30	ls	\$50,000	\$1,500,000	
Erosion Control	0	ls	\$0	\$0	
Slope Protection	0	ls	\$0	\$0	
Water Pollution Control	0	ls	\$40,000	\$40,000	
Hazardous Waste Mitigation Work	0	ls	\$0	\$0	
Environmental Mitigation	0	ls	\$0	\$0	
Resident Engineer Office Space	0	months	\$1,000	\$1,000	
			Subtotal 4 Specialty Items		\$1,551,000

Section 5 Traffic Items

	Quantity	Unit	Unit Price	Item Cost	Section Cost
Lighting	0	ls	\$0	\$0	
Traffic Delineation Striping	34500	2	69,000	lf	\$4.00 \$276,000
Remove Striping	34500	2	69,000	lf	\$4.00 \$276,000
Traffic Delineation Markings		30	crossing	\$2,500	\$75,000
Traffic Signals, Modification		0	ls	\$15,000	\$15,000
Overhead Sign Structures		0	ea	\$20,000	\$20,000
Roadside Signs		50	ea	\$500	\$25,000
Traffic Control Systems		20	ea	\$15,000	\$300,000
Transportation Management Plan		1	ea	\$50,000	\$50,000
			Subtotal 5 Traffic Items		\$1,037,000

TOTAL SECTIONS 1 thru 5	\$2,598,000
TOTAL SECTIONS 1 thru 5	\$684,400

Additional 5' Widening, Optional

Section 6 Minor Items

\$2,598,000 10% = \$259,800
 (Subtotal Sections 1 thru 5)

\$684,400 10% = \$68,440
 (Subtotal Sections 1 thru 5)

Additional 5' Widening, Optional**Additional 5' Widening, Optional**

TOTAL MINOR ITEMS	\$259,800
TOTAL MINOR ITEMS	\$68,440

Section 7 Roadway Mobilization

\$2,857,800 10% = \$285,780
 (Subtotal Sections 1 thru 6)

\$752,840 10% = \$75,284
 (Subtotal Sections 1 thru 6)

Additional 5' Widening, Optional

TOTAL ROADWAY MOBILIZATION	\$285,780
TOTAL ROADWAY MOBILIZATION	\$75,284

Section 8 Roadway Additions

Supplemental Work

\$2,857,800 10% = \$285,780
 (Subtotal Sections 1 thru 6)

Supplemental Work

\$752,840 10% = \$75,284
 (Subtotal Sections 1 thru 6)

Contingencies

\$2,857,800 25% = \$714,450
 (Subtotal Sections 1 thru 6)

Contingencies

\$752,840 25% = \$188,210
 (Subtotal Sections 1 thru 6)

Additional 5' Widening, Optional

TOTAL ROADWAY ADDITIONS	\$1,000,230
TOTAL ROADWAY ADDITIONS	\$263,494

Additional 5' Widening, Optional

TOTAL ROADWAY ITEMS	\$4,143,810
TOTAL ROADWAY ITEMS	\$1,091,618

II. STRUCTURES ITEMS

Name	Structure New Portal at North	Structure (2)	Structure (3)
	Hollywood		
	Redline Station		
Bridge Name	\$11,500,000	\$0	\$0
Structure Type	SUBTOTAL STRUCTURES ITEMS \$11,500,000 (Sum of Total Cost for Structures)		
Total Cost for Structure			
Railroad Related Costs:	SUBTOTAL RAILROAD ITEMS \$0		
	TOTAL STRUCTURES ITEMS \$11,500,000 (Sum of Structures Items plus Railroad Items)		

III. RIGHT OF WAY ITEMS

A. Acquisition, including excess lands, damages to remainder(s) and Goodwill	\$0	\$0
B. Utility Relocation (State share)	\$0	\$0
C. Relocation Assistance	\$0	\$0
D. Clearance/Demolition	\$0	\$0
E. Title and Escrow Fees	\$0	\$0
	TOTAL RIGHT OF WAY ITEMS \$0 (Escalated Value)	
	Anticipated Date of Right of Way Certification 0 (Date to which Values are Escalated)	

Estimate Prepared By Matt Tsugawa/Nancy Cooper

Phone: (909) 884-3222

Date: February 2003

Estimate Checked By Richard Hernandez

Phone: (909) 884-3222

Date: February 2003

PROJECT DESCRIPTION: Van Nuys Boulevard Corridor

Limits: Van Nuys Boulevard at Ventura Boulevard north to Foothill Boulevard, Foothill Boulevard north to Hubbard Street

Proposed Improvement:

SUMMARY OF PROJECT COST ESTIMATE

TOTAL ROADWAY ITEMS	\$4,911,800	
ALTERNATIVE COST: INTERCHANGE CONTRIBUTION AT VENTURA FREEWAY	\$5,000,000	
TOTAL STRUCTURE ITEMS	CHANNEL BRIDGE WIDENING	\$500,000
STATION ELEMENTS	\$1,980,000	
URBAN DESIGN ENHANCEMENTS	\$8,450,000	
SUBTOTAL BASE CONSTRUCTION COSTS	\$7,391,800	
SUBTOTAL ENHANCED CONSTRUCTION COSTS	\$13,450,000	
RIGHT OF WAY	\$0	
EQUIPMENT: CORRIDOR BUSES	\$23,400,000	
EQUIPMENT: FEEDER BUSES	\$38,680,000	
MAINTENANCE FACILITY CONTRIBUTION	\$38,750,000	
TOTAL PROJECT BASE CAPITAL OUTLAY COSTS	\$108,221,800	
TOTAL PROJECT COSTS (BASE + OPTIONAL/ALTERNATIVE)	\$121,671,800	

I. ROADWAY ITEMS

<u>Section 1 Earthwork</u>	Length	Width	Quantity	Unit	Unit Price	Item Cost	Section Cost
Road Excavation	1,500	7	583	cy	\$35	\$20,405	
Road Excavation	550	15	4,583	cy	\$35	\$160,405	
Imported Borrow	550	15	4,583	cy	\$30	\$137,490	
Clearing, Grubbing & Demolition	2,600	7	18,200	sf	\$2.00	\$36,400	
Remove AC			0	cf	\$64	\$0	
Develop Water Supply (Per m3 earthwork)			0	cf	\$0	\$0	
						Subtotal 1 Earthwork	\$354,700

Section 2 Pavement Structural Section*

<u>Section 2 Pavement Structural Section*</u>		Quantity	Unit	Unit Price	Item Cost	Section Cost
Asphalt Concrete, 0.5 feet thick	1,500	5	270	ton	\$150	\$40,500
Aggregate Base, 1 foot thick	1,500	7	389	cy	\$50	\$19,450
PCC Curb & Gutter	2,050		4,100	lf	\$30	\$123,000
Minor Concrete Sidewalk	550	10	2,750	cf	\$5	\$13,750
						Subtotal 2 Pavement Items
						\$196,700

Section 3 Drainage

<u>Section 3 Drainage</u>		Quantity	Unit	Unit Price	Item Cost	Section Cost
Large Drainage Facilities		0	ea	\$0	\$0	
Storm Drains		0	ea	\$0	\$0	
Storm Water Pollution Prevention Plan		1	ea	\$20,000	\$20,000	
Project Drainage		0	ea	\$500,000	\$500,000	
						Subtotal 3 Drainage
						\$520,000

Section 4 Specialty Items

<u>Section 4 Specialty Items</u>		Quantity	Unit	Unit Price	Item Cost	Section Cost
Retaining Walls		0	ls	\$0	\$0	
Noise Barriers		0	ls	\$0	\$0	
Barriers and Guardrails		0	ls	\$0	\$0	
Intersection Pop Outs		10	ea	\$35,000	\$350,000	
Highway Planting		0	ls	\$0	\$0	
Replacement Planting		0	ls	\$0	\$0	
Irrigation Modification		0	ls	\$10,000	\$10,000	
Relocate Utilities		3	ls	\$50,000	\$150,000	
Erosion Control		0	ls	\$0	\$0	
Slope Protection		0	ls	\$0	\$0	
Water Pollution Control		0	ls	\$40,000	\$40,000	
Hazardous Waste Mitigation Work		0	ls	\$0	\$0	
Environmental Mitigation		0	ls	\$0	\$0	
Resident Engineer Office Space		0	months	\$1,000	\$1,000	
						Subtotal 4 Specialty Items
						\$551,000

Section 5 Traffic Items

	Quantity	Unit	Unit Price	Item Cost	Section Cost
Lighting	0	ls	\$0	\$0	
Traffic Delineation Striping	68,390	lf	\$4.00	\$273,560	
Remove Striping	68,390	lf	\$4.00	\$273,560	
Traffic Delineation Markings	50	crossing	\$2,500	\$125,000	
Traffic Signals, Modification	0	ls	\$15,000	\$15,000	
Intersection Modification	1	ea	\$250,000	\$250,000	
New Traffic Signal at Chandler	1	ea	\$125,000	\$125,000	
Overhead Sign Structures	0	ea	\$20,000	\$20,000	
Roadside Signs	50	ea	\$500	\$25,000	
Traffic Control Systems	20	ea	\$15,000	\$300,000	
Transportation Management Plan	1	ea	\$50,000	\$50,000	
			Subtotal 5 Traffic Items		\$1,457,120

TOTAL SECTIONS 1 thru 5	\$3,079,520
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Section 6 Minor Items

\$3,079,520	10%	=	\$307,952
(Subtotal Sections 1 thru 5)			

TOTAL MINOR ITEMS	\$307,952
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Section 7 Roadway Mobilization

\$3,387,472	10%	=	\$338,747
(Subtotal Sections 1 thru 6)			

TOTAL ROADWAY MOBILIZATION	\$338,747
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Section 8 Roadway Additions

\$3,387,472	10%	=	\$338,747
(Subtotal Sections 1 thru 6)			

\$3,387,472	25%	=	\$846,868
(Subtotal Sections 1 thru 6)			

TOTAL ROADWAY ADDITIONS	\$1,185,615
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TOTAL ROADWAY ITEMS	\$4,911,834
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(Subtotal Sections 1 thru 8)

TOTAL ALTERNATIVE COST	\$5,000,000
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Alternative Cost: Interchange Contribution at Ventura Freeway

II. STRUCTURES ITEMS

	Structure Channel	Structure (2)	Structure (3)
Name	\$500,000	\$0	\$0
Bridge Name			
Structure Type			
Total Cost for Structure			

SUBTOTAL STRUCTURES ITEMS	\$500,000
(Sum of Total Cost for Structures)	

Railroad Related Costs:

SUBTOTAL RAILROAD ITEMS	\$0
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TOTAL STRUCTURES ITEMS	\$500,000
(Sum of Structures Items plus Railroad Items)	

III. RIGHT OF WAY ITEMS

A. Acquisition, including excess lands, damages to remainder(s) and Goodwill	\$0	\$0
B. Utility Relocation (State share)	\$0	\$0
C. Relocation Assistance	\$0	\$0
D. Clearance/Demolition	\$0	\$0
E. Title and Escrow Fees	\$0	\$0

	TOTAL RIGHT OF WAY ITEMS	\$0
(Escalated Value)		

Anticipated Date of Right of Way Certification	0
(Date to which Values are Escalated)	

Estimate Prepared By Matt Tsugawa/Nancy Cooper

Phone: (909) 884-3222

Date: February 2003

Estimate Checked By Richard Hernandez

Phone: (909) 884-3222

Date: February 2003

PROJECT DESCRIPTION: Sepulveda Boulevard Corridor

Limits: Sepulveda Boulevard at Ventura Boulevard north to Brand Boulevard, Brand Boulevard north to San Fernando Road

Proposed Improvement:

SUMMARY OF PROJECT COST ESTIMATE

TOTAL ROADWAY ITEMS	\$6,669,530
TOTAL STRUCTURE ITEMS METROLINK WIDENING	\$250,000
STATION ELEMENTS	\$2,920,000
URBAN DESIGN ENHANCEMENTS	\$5,480,000
SUBTOTAL BASE CONSTRUCTION COSTS	\$9,839,530
SUBTOTAL ENHANCED CONSTRUCTION COSTS	\$5,480,000
RIGHT OF WAY	\$17,970,000
EQUIPMENT: CORRIDOR BUSES	\$27,950,000
EQUIPMENT: FEEDER BUSES	\$37,050,000
MAINTENANCE FACILITY CONTRIBUTION	\$39,250,000
TOTAL PROJECT BASE CAPITAL OUTLAY COSTS	\$132,059,530
TOTAL PROJECT COSTS (BASE + OPTIONAL/ALTERNATIVE)	\$137,539,530

I. ROADWAY ITEMS**Section 1 Earthwork**

	Length	Width	Quantity	Unit	Unit Price	Item Cost	Section Cost
Road Excavation	1,715	15	1,429	cy	\$35	\$50,021	
Imported Borrow, 1000 x 60 x 30	0	0	0	cy	\$30	\$0	
Clearing, Grubbing & Demolition	1,715	15	25,725	sf	\$2.00	\$51,450	
Remove AC			210	cf	\$64	\$13,440	
Develop Water Supply (Per m3 earthwork)			0	cf	\$0	\$0	
					Subtotal 1 Earthwork		\$114,911

Section 2 Pavement Structural Section

		Quantity	Unit	Unit Price	Item Cost	Section Cost
Asphalt Concrete, 0.5 feet thick	1,715	10	617	ton	\$150	\$92,610
Aggregate Base, 1 foot thick	1,715	15	953	cy	\$50	\$47,639
PCC Curb & Gutter			4,455	lf	\$25	\$111,375
Minor Concrete Sidewalk	1,715	10	17,150	sf	\$5	\$85,750
				Subtotal 2 Pavement Items		\$337,374

Section 3 Drainage

		Quantity	Unit	Unit Price	Item Cost	Section Cost
Large Drainage Facilities		0	ea	\$0	\$0	
Storm Drains		0	ea	\$0	\$0	
Storm Water Pollution Prevention Plan		1	ea	\$20,000	\$20,000	
Project Drainage		0	ea	\$400,000	\$400,000	
				Subtotal 3 Drainage		\$420,000

Section 4 Specialty Items

		Quantity	Unit	Unit Price	Item Cost	Section Cost
Retaining Walls		0	ls	\$0	\$0	
Noise Barriers		0	ls	\$0	\$0	
Barriers and Guardrails		0	ls	\$0	\$0	
Highway Planting		1	ls	\$0	\$0	
Replacement Planting		0	ls	\$0	\$0	
Irrigation Modification		1	ls	\$10,000	\$10,000	
Relocate Utilities		20	ls	\$50,000	\$1,000,000	
Erosion Control		0	ls	\$0	\$0	
Slope Protection		0	ls	\$0	\$0	
Water Pollution Control		1	ls	\$40,000	\$40,000	
Hazardous Waste Mitigation Work		0	ls	\$0	\$0	
Environmental Mitigation		0	ls	\$0	\$0	
Resident Engineer Office Space		0	months	\$1,000	\$0	
				Subtotal 4 Specialty Items		\$1,050,000

Section 5 Traffic Items

	Quantity	Unit	Unit Price	Item Cost	Section Cost
Lighting	0	ls	\$0	\$0	
Traffic Delineation Striping	35,505	6	213,030 lf	\$4.00	\$852,120
Remove Striping	35,505	6	213,030 lf	\$4.00	\$852,120
Traffic Delineation Markings		70	crossing	\$2,500	\$175,000
Traffic Signals, Modification		1	ls	\$15,000	\$15,000
Overhead Sign Structures		0	ea	\$20,000	\$0
Roadside Signs		50	ea	\$500	\$25,000
Traffic Control Systems		20	ea	\$15,000	\$300,000
Transportation Management Plan		1	ea	\$40,000	\$40,000
			Subtotal 5 Traffic Items		\$2,259,240

TOTAL SECTIONS 1 thru 5	\$4,181,525
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Section 6 Minor Items

\$4,181,525	10%	=	\$418,152
			TOTAL MINOR ITEMS
			\$418,152

Section 7 Roadway Mobilization

\$4,599,677	10%	=	\$459,967
(Subtotal Sections 1 thru 6)			
			TOTAL ROADWAY MOBILIZATION
			\$459,967

Section 8 Roadway Additions

Supplemental Work	\$4,599,677	10%	=	\$459,967
(Subtotal Sections 1 thru 6)				

Contingencies	\$4,599,677	25%	=	\$1,149,919
(Subtotal Sections 1 thru 6)				

			TOTAL ROADWAY ADDITIONS
			\$1,609,886
			TOTAL ROADWAY ITEMS
			\$6,669,530
(Subtotal Sections 1 thru 8)			

II. STRUCTURES ITEMS

	Structure Name	Structure (2)	Structure (2)
Bridge Name	Metrolink widening	\$250,000	\$0
Structure Type			\$0
Total Cost for Structure			

SUBTOTAL STRUCTURES ITEMS	\$250,000
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(Sum of Total Cost for Structures)

Railroad Related Costs:

SUBTOTAL RAILROAD ITEMS	\$0
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TOTAL STRUCTURES ITEMS	\$250,000
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(Sum of Structures Items plus Railroad Items)

III. RIGHT OF WAY ITEMS

A. Acquisition, including excess lands, damages to remainder(s) and Goodwill	\$0	\$0
B. Utility Relocation (State share)	\$0	\$0
C. Relocation Assistance	\$0	\$0
D. Clearance/Demolition	\$0	\$0
E. Title and Escrow Fees	\$0	\$0

TOTAL RIGHT OF WAY ITEMS	\$0
---------------------------------	------------

(Escalated Value)

Anticipated Date of Right of Way Certification	0
-------------------------------------------------------	----------

(Date to which Values are Escalated)

Estimate Prepared By Matt Tsugawa/Nancy Cooper

Phone: (909) 884-3222

Date: February 2003

Estimate Checked By Richard Hernandez

Phone: (909) 884-3222

Date: February 2003

PROJECT DESCRIPTION: Reseda Boulevard Corridor

Limits: Reseda Boulevard at Ventura Boulevard north to Nordoff Street, Nordoff Street east to Woodley Avenue, Woodley Avenue north to Plummer Street, Plummer Street east to Sepulveda Boulevard, Sepulveda Boulevard north to Brand Boulevard, Brand Boulevard north to San Fernando Road, San Fernando Road to Hubbard Street

Proposed Improvement:

SUMMARY OF PROJECT COST ESTIMATE

TOTAL ROADWAY ITEMS	\$3,974,500
TOTAL STRUCTURE ITEMS:	\$0
STATION ELEMENTS	\$4,300,000
URBAN DESIGN ENHANCEMENTS	\$7,900,000
SUBTOTAL BASE CONSTRUCTION COSTS	\$8,274,500
SUBTOTAL ENHANCED CONSTRUCTION COSTS	\$7,900,000
TOTAL RIGHT OF WAY ITEMS	\$0
EQUIPMENT: CORRIDOR BUSES	\$18,850,000
EQUIPMENT: FEEDER BUSES	\$25,680,000
MAINTENANCE FACILITY CONTRIBUTION	\$27,000,000
TOTAL PROJECT BASE CAPITAL OUTLAY COSTS	\$79,804,500
TOTAL PROJECT COSTS (BASE + OPTIONAL/ALTERNATIVE)	\$87,704,500

I. ROADWAY ITEMS**Section 1 Earthwork**

	Length	Width	Quantity	Unit	Unit Price	Item Cost	Section Cost
Road Excavation	0	0	23	cy	\$35	\$805	
Imported Borrow	0	0	0	cy	\$30	\$0	
Clearing, Grubbing & Demolition	0	0	1,215	sf	\$2.00	\$2,430	
Remove AC	0	0	210	cf	\$64	\$13,440	
Develop Water Supply (Per m ³ earthwork)			0	cf	\$0	\$0	
					Subtotal 1 Earthwork		\$16,675

Section 2 Pavement Structural Section*

	Length	Width	Quantity	Unit	Unit Price	Item Cost	Section Cost
Asphalt Concrete, 0.5 feet thick	0	0	1	ton	\$150	\$150	
Aggregate Base, 1 foot thick	0	0	16	cy	\$50	\$800	
PCC Curb & Gutter	0	0	75	lf	\$30	\$2,250	
Minor Concrete Sidewalk	0	0	383	cf	\$0	\$0	
					Subtotal 2 Pavement Items		\$3,200

Section 3 Drainage

	Quantity	Unit	Unit Price	Item Cost	Section Cost
Large Drainage Facilities	0	ea	\$0	\$0	
Storm Drains	0	ea	\$0	\$0	
Storm Water Pollution Prevention Plan	1	ea	\$17,500	\$17,500	
Project Drainage	1	ea	\$125,000	\$125,000	
			Subtotal 3 Drainage		\$142,500

Section 4 Specialty Items

	Quantity	Unit	Unit Price	Item Cost	Section Cost
Retaining Walls	0	ls	\$0	\$0	
Noise Barriers	0	ls	\$0	\$0	
Barriers and Guardrails	0	ls	\$0	\$0	
Intersection Pop-outs	9	ea	\$35,000	\$315,000	
Entry Upgrade at VA Hospital	0	ls	\$400,000	\$400,000	
Replacement Planting	0	ls	\$0	\$0	
Irrigation Modification	0	ls	\$13,500	\$13,500	
Relocate Utilities	9	ls	\$50,000	\$450,000	
Erosion Control	0	ls	\$0	\$0	
Slope Protection	0	ls	\$0	\$0	
Water Pollution Control	0	ls	\$52,500	\$52,500	
Hazardous Waste Mitigation Work	0	ls	\$0	\$0	
Environmental Mitigation	0	ls	\$0	\$0	
Resident Engineer Office Space	0	months	\$1,000	\$1,000	
			Subtotal 4 Specialty Items		\$1,232,000

Section 5 Traffic Items

	Quantity	Unit	Unit Price	Item Cost	Section Cost
Lighting	0	ls	\$0	\$0	
Traffic Delineation Striping	0	lf	\$4.00	\$0	
Removal Striping	0	lf	\$4.00	\$0	
Traffic Delineation Markings	130	crossing	\$2,500	\$325,000	
Traffic Signals, Modification	3	ls	\$15,000	\$45,000	
Traffic Signals, New	1	ls	\$125,000	\$125,000	
Overhead Sign Structures	0	ea	\$20,000	\$20,000	
Roadside Signs	65	ea	\$500	\$32,500	
Traffic Control Systems	27	ea	\$15,000	\$405,000	
Queue-Jump at Sherman Intersection	0	ls	\$100,000	\$100,000	
Transportation Management Plan	1	ea	\$45,000	\$45,000	
			Subtotal 5 Traffic Items		\$1,097,500

TOTAL SECTIONS 1 thru 5	\$2,491,875
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Section 6 Minor Items

\$2,491,875 10% = \$249,187

(Subtotal Sections 1 thru 5)

TOTAL MINOR ITEMS	\$249,187
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Section 7 Roadway Mobilization

\$2,741,062 10% = \$274,106

(Subtotal Sections 1 thru 6)

TOTAL ROADWAY MOBILIZATION	\$274,106
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Section 8 Roadway Additions

Supplemental Work

\$2,741,062 10% = \$274,106

(Subtotal Sections 1 thru 6)

Contingencies

\$2,741,062 25% = \$685,265

(Subtotal Sections 1 thru 6)

TOTAL ROADWAY ADDITIONS	\$959,371
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TOTAL ROADWAY ITEMS	\$3,974,539
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(Subtotal Sections 1 thru 8)

II. STRUCTURES ITEMS

	Structure (1)	Structure (2)	Structure (3)	
Name				
Bridge Name	0\$	\$0	\$0	
Structure Type				
Total Cost for Structure	SUBTOTAL STRUCTURES ITEMS			\$0
	(Sum of Total Cost for Structures)			

Railroad Related Costs:

	SUBTOTAL RAILROAD ITEMS		
	TOTAL STRUCTURES ITEMS		

III. RIGHT OF WAY ITEMS

A. Acquisition, including excess lands, damages to remainder(s) and Goodwill	\$0	\$0
B. Utility Relocation (State share)	\$0	\$0
C. Relocation Assistance	\$0	\$0
D. Clearance/Demolition	\$0	\$0
E. Title and Escrow Fees	\$0	\$0

	TOTAL RIGHT OF WAY ITEMS		
	(Escalated Value)		

	Anticipated Date of Right of Way Certification		
	(Date to which Values are Escalated)		

Estimate Prepared By Matt Tsugawa/Nancy Cooper

Phone: (909) 884-3222

Date: February 2003

Estimate Checked By Richard Hernandez

Phone: (909) 884-3222

Date: February 2003

PROJECT DESCRIPTION: Canoga Avenue Corridor

Limits: Canoga Avenue at Oxnard Street to Variel Avenue north to Lassen Street

Proposed Improvement:

SUMMARY OF PROJECT COST ESTIMATE

TOTAL ROADWAY ITEMS	\$24,086,500
TOTAL STRUCTURE ITEMS	
CHANNEL BRIDGE WIDENING	\$1,050,000
RAILROAD IMPROVEMENTS	
ALTERNATIVE/OPTIONAL COSTS	\$19,750,000
GRADE SEPARATION	
PARKING FACILITIES AT WARNER CENTER	
PARKING FACILITIES NEAR SHERMAN	
STATION ELEMENTS	\$10,740,000
URBAN DESIGN ENHANCEMENTS	\$580,000
SUBTOTAL BASE CONSTRUCTION COSTS	\$35,876,500
SUBTOTAL ALTERNATIVE CONSTRUCTION COSTS	\$20,330,000
RIGHT OF WAY	\$7,000,000
RIGHT OF WAY ENHANCED COSTS	\$6,070,000
EQUIPMENT: CORRIDOR BUSES	\$6,500,000
EQUIPMENT: FEEDER BUSES	\$23,080,000
MAINTENANCE FACILITY CONTRIBUTION	\$20,250,000
TOTAL PROJECT BASE CAPITAL OUTLAY COSTS	\$92,706,500
TOTAL PROJECT COSTS (BASE + OPTIONAL/ALTERNATIVE)	\$119,106,500

I. ROADWAY ITEMS**Section 1 Earthwork**

	Length	Width	Quantity	Unit	Unit Price	Item Cost	Section Cost
Road Excavation	23,000	30	38,333	cy	\$35	\$1,341,655	
Imported Borrow, 1000 x 60 x 30	1000	60	66,667	cy	\$30	\$2,000,010	
Clearing, Grubbing & Demolition	32,020	30	960,600	sf	\$2.00	\$1,921,200	
Remove AC			0	cf	\$64	\$0	
Develop Water Supply (Per m3 earthwork)			0	cf	\$0	\$0	
					Subtotal 1 Earthwork		\$5,262,865

Section 2 Pavement Structural Section*

		Quantity	Unit	Unit Price	Item Cost	Section Cost
Asphalt Concrete, 0.5 feet thick	23,000	26	21,528	ton	\$150	\$3,229,200
Aggregate Base, 1 foot thick	23,000	30	25,556	cy	\$50	\$1,277,800
PCC Curb & Gutter	23,000		46,000	lf	\$30	\$1,380,000
Minor Concrete Sidewalk			0	cf	\$0	
Bike Path, 0.25 feet thick	14,300	22	5,663	ton	\$150	\$849,420
					Subtotal 2 Pavement Items	\$6,736,420

Section 3 Drainage

	Quantity	Unit	Unit Price	Item Cost	Section Cost
Large Drainage Facilities	0	ea	\$0	\$0	
Storm Drains	0	ea	\$0	\$0	
Storm Water Pollution Prevention Plan	1	ea	\$35,000	\$35,000	
Project Drainage	1	ea	\$500,000	\$500,000	
				Subtotal 3 Drainage	\$535,000

Section 4 Specialty Items

	Quantity	Unit	Unit Price	Item Cost	Section Cost
Noise Barriers	0	ls	\$0	\$0	
Barriers and Guardrails	0	ls	\$0	\$0	
Replacement Planting	0	ls	\$0	\$0	
Irrigation Modification	0	ls	\$10,000	\$10,000	
Relocate Utilities	30	ls	\$50,000	\$1,500,000	
Erosion Control	0	ls	\$200,000	\$200,000	
Slope Protection	0	ls	\$0	\$0	
Water Pollution Control	0	ls	\$40,000	\$40,000	
Hazardous Waste Mitigation Work	0	ls	\$0	\$0	
Environmental Mitigation	0	ls	\$0	\$0	
Resident Engineer Office Space	0	months	\$1,000	\$1,000	
				Subtotal 4 Specialty Items	\$1,751,000

Section 5 Traffic Items

	Quantity	Unit	Unit Price	Item Cost	Section Cost
Lighting	1	ls	\$0	\$0	
Traffic Delineation Striping	69,000	lf	\$4.00	\$276,000	
Traffic Delineation Markings	30	crossing	\$2,500	\$75,000	
Traffic Signals, Modification	6	ls	\$15,000	\$90,000	
Overhead Sign Structures	0	ea	\$20,000	\$20,000	
Roadside Signs	50	ea	\$500	\$25,000	
Traffic Control Systems	20	ea	\$15,000	\$300,000	
Transportation Management Plan	1	ea	\$30,000	\$30,000	
			Subtotal 5 Traffic Items		\$816,000

TOTAL SECTIONS 1 thru 5	\$15,101,285
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Section 6 Minor Items

\$15,101,285 10% = \$1,510,128
 (Subtotal Sections 1 thru 5)

TOTAL MINOR ITEMS	\$1,510,128
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Section 7 Roadway Mobilization

\$16,611,413 10% = \$1,661,141
 (Subtotal Sections 1 thru 6)

TOTAL ROADWAY MOBILIZATION	\$1,661,141
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Section 8 Roadway Additions

Supplemental Work \$16,611,413 10% = \$1,661,141
 (Subtotal Sections 1 thru 6)

Contingencies \$16,611,413 25% = \$4,152,853
 (Subtotal Sections 1 thru 6)

TOTAL ROADWAY ADDITIONS	\$5,813,994
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TOTAL ROADWAY ITEMS	\$24,086,548
----------------------------	---------------------

(Subtotal Sections 1 thru 8)

II. STRUCTURES ITEMS

Name	Structure (1)	Structure Channel widening	Optional Structure Grade Separation	Optional Structure 500-car Parking at Warner Center
Bridge Name	\$0	\$750,000	\$10,000,000	\$7,500,000
Structure Type				
Total Cost for Structure				

SUBTOTAL STRUCTURES ITEMS	\$750,000
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(Sum of Total Cost for Structures, not including Optional Structures)

Railroad Related Costs:

SUBTOTAL RAILROAD ITEMS	\$300,000
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TOTAL STRUCTURES ITEMS	\$1,050,000
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(Sum of Structures Items plus Railroad Items)

Optional Item Costs

Grade Separation	1	\$10,000,000
500-car Parking Lot at Warner Center	2	\$7,500,000
Parking Lot near Sherman	3	\$2,250,000
		TOTAL OPTIONAL ITEMS
		\$19,750,000

III. RIGHT OF WAY ITEMS

A. Acquisition, including excess lands, damages to remainder(s) and Goodwill	\$0	\$0
B. Utility Relocation (State share)	\$0	\$0
C. Relocation Assistance	\$0	\$0
D. Clearance/Demolition	\$0	\$0
E. Title and Escrow Fees	\$0	\$0

TOTAL RIGHT OF WAY ITEMS	\$0
---------------------------------	------------

(Escalated Value)

Anticipated Date of Right of Way Certification	0
-------------------------------------------------------	----------

(Date to which Values are Escalated)

Estimate Prepared By Matt Tsugawa/Nancy Cooper

Phone: (909) 884-3222

Date: February 2003

HKA

Alignment 1

02-1021

Estimate Checked By Richard Hernandez

Phone: (909) 884-3222

Date: February 2003

Appendix D


Cost Effectiveness Tables



APPENDIX ITEMS

Table 5.9-5 – Cost Effectiveness Summary- Key Indicators

CRITERIA	CORRIDOR ALTERNATIVES						
	2025 TSM	2025 RB	Canoga Ave. RR ROW	Reseda Blvd.	Sepulveda Blvd.	Van Nuys Blvd. - Foothill Terminus	Lankershim Blvd. - SF Rd.
Weekday Boardings per Mile*(Minimal Base)	n/a	n/a	653	751	890	939	1,625
Weekday Boardings per Mile* (Full Enhanced)	n/a	n/a	816	939	1,113	1,173	2,031
Farebox Recovery Ratio (Minimal Base)		40.62%	40.70%	39.78%	38.86%	37.78%	38.53%
Farebox Recovery Ratio (Full Enhanced)		40.62%	40.70%	40.02%	39.17%	38.14%	38.92%
Capital Cost (Minimal Base)	n/a	\$4,510,000	\$41,950,000	\$8,280,000	\$27,810,000	\$7,390,000	\$6,080,000
Capital Cost (Full Enhanced)	n/a	\$4,510,000	\$68,351,000	\$16,180,000	\$33,290,000	\$20,840,000	\$23,690,000
Operating Cost per Mile (Minimal and Full)	n/a	n/a	\$36,621,709	\$14,090,113	\$10,012,665	\$9,703,829	\$16,167,521
Capital Cost per Mile (Minimal Base)	n/a	n/a	\$7,768,519	\$571,034	\$1,318,009	\$345,327	\$486,400
Capital Cost per Mile (Full Enhanced)	n/a	n/a	\$12,657,593	\$1,115,862	\$1,577,725	\$973,832	\$1,895,200
Capital Cost per Passgr (Minimal Base)	n/a	\$0.0044	\$0.0296	\$0.0066	\$0.0179	\$0.0052	\$0.0044
Capital Cost per Passgr (Full Enhanced)	n/a	\$0.0044	\$0.0499	\$0.0140	\$0.0229	\$0.0161	\$0.0178
Incremental Cost Per New Trip (Minimal Base)		\$3.93	\$11.52	\$7.25	\$6.31	\$7.32	\$5.78
Incremental Cost Per New Trip (Full Enhanced)		\$3.93	\$11.52	\$6.50	\$5.24	\$5.96	\$4.84

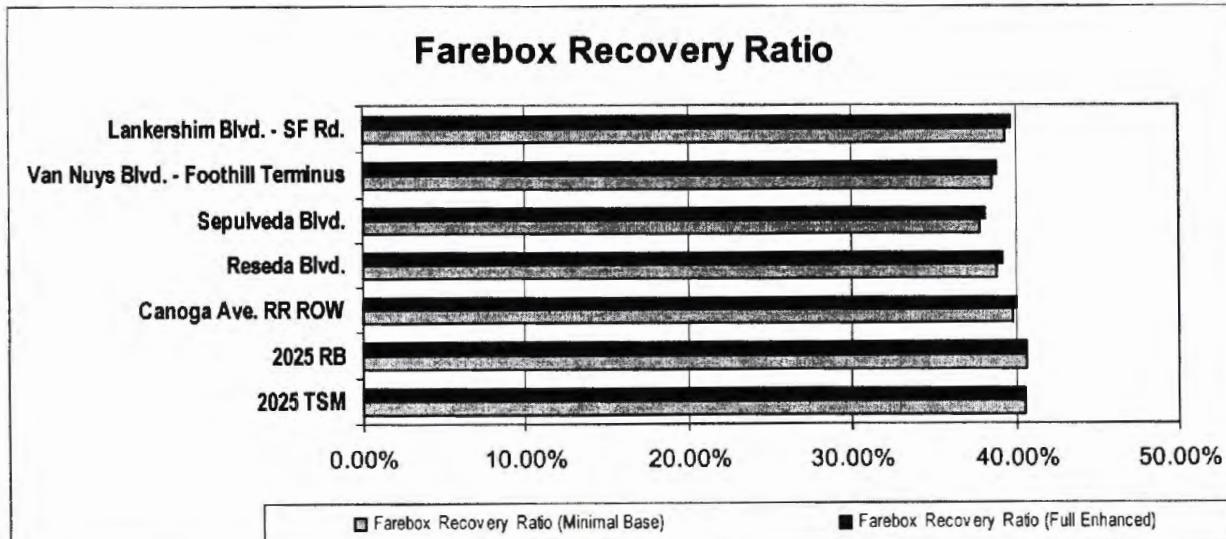

San Fernando Valley North-South Transit Corridor Study



San Fernando Valley
North-South Transit Corridor
Regionally Significant Transportation Investment Study

Table 5.7-6 – Capital Cost Estimates by Project Elements**San Fernando Valley North-South Transit Corridor Alternatives Analysis**

Corridor Alternatives	Station Elements	Station Access Improvements	Urban Design Elements	Base Roadway Improvements	Additional Roadway Improvements	Grade Separations	Project Element				Right of Way	Total (\$million)
							Parking Facilities	Red Line Portal				
Base 2025											\$ -	
Capital Cost (\$million)											\$ -	
Annualized Capital Cost (\$million)											\$ -	
Annual O&M Cost (\$million)											\$ 181.46	
Total Annualized Cost (\$million)											\$ 181.46	
2025 TSM	\$ -	\$ -		\$ -	\$ -	\$ -	\$ -	\$ -	\$ -	\$ -	\$ -	
Capital Cost (\$million)	\$ -	\$ -		\$ -	\$ -	\$ -	\$ -	\$ -	\$ -	\$ -	\$ -	
Annualized Capital Cost (\$million)											\$ -	
Annual O&M Cost (\$million)											\$ 194.87	
Total Annualized Cost (\$million)											\$ 194.87	
2025 RB	\$ 4.51	\$ -		\$ -	\$ -	\$ -	\$ -	\$ -	\$ -	\$ -	\$ 4.51	
Capital Cost (\$million)	\$ 4.51	\$ -		\$ -	\$ -	\$ -	\$ -	\$ -	\$ -	\$ -	\$ 0.50	
Annualized Capital Cost (\$million)											\$ 190.03	
Annual O&M Cost (\$million)											\$ 190.53	
Total Annualized Cost (\$million)												
Canoga RR ROW	\$ 10.74	\$ -		\$ 25.14	\$ -	\$ -	\$ -	\$ -	\$ -	\$ 6.07	\$ 41.95	
Capital Cost (\$million)	\$ 10.74	\$ -		\$ 25.14	\$ -	\$ -	\$ -	\$ -	\$ -	\$ 6.07	\$ 41.95	
Annualized Capital Cost (\$million)											\$ 3.37	
Annual O&M Cost (\$million)											\$ 197.76	
Total Annualized Cost (\$million)											\$ 201.12	

Table 5.7-7 – Capital Cost Estimates by Project Elements (Appendix [Cont'd])

**San Fernando Valley
North-South Transit Corridor
Regionally Significant Transportation Investment Study**

APPENDIX D: Cost Effectiveness Tables

San Fernando Valley North-South Transit Corridor Alternatives Analysis

Corridor Alternatives	Project Element										Total (\$million)
	Station Elements	Station Access Improvements	Urban Design Elements	Base Roadway Improvements	Additional Roadway Improvements	Grade Separations	Parking Facilities	Red Line Portal	Right of Way		
Reseda Boulevard											
Capital Cost (\$million)	\$ 4.30	\$ -		\$ 3.98	\$ -	\$ -	\$ -	\$ -	\$ -	\$ 8.28	
Annualized Capital Cost (\$million)										\$ 0.75	
Annual O&M Cost (\$million)										\$ 204.31	
Total Annualized Cost (\$million)										\$ 205.06	
Sepulveda Boulevard											
Capital Cost (\$million)	\$ 2.92	\$ -		\$ 6.92	\$ -	\$ -	\$ -	\$ -	\$ 17.97	\$ 27.81	
Annualized Capital Cost (\$million)										\$ 2.06	
Annual O&M Cost (\$million)										\$ 211.27	
Total Annualized Cost (\$million)										\$ 213.33	
Van Nuys Boulevard - Sylmar Terminus											
Capital Cost (\$million)	\$ 1.98	\$ -		\$ 5.41	\$ -	\$ -	\$ -	\$ -	\$ -	\$ 7.39	
Annualized Capital Cost (\$million)										\$ 0.60	
Annual O&M Cost (\$million)										\$ 207.66	
Total Annualized Cost (\$million)										\$ 208.26	
Lankershim Boulevard – San Fernando Road											
Capital Cost (\$million)	\$ 1.94	\$ -		\$ 4.14	\$ -	\$ -	\$ -	\$ -	\$ -	\$ 6.08	
Annualized Capital Cost (\$million)										\$ 0.50	
Annual O&M Cost (\$million)										\$ 202.09	
Total Annualized Cost (\$million)										\$ 202.60	



Table 5.7-8 – Cost Effectiveness Summary (Minimal Base Scenario)*San Fernando Valley North-South Transit Corridor Alternatives Analysis*

Corridor Alternatives	2025 TSM	2025 RB	Canoga Avenue RR ROW	Reseda Boulevard	Sepulveda Boulevard	Van Nuys Boulevard - Sylmar Terminus	Lankershim Boulevard – San Fernando Road
Total Capital Cost (\$million)	\$ -	\$ 4.51	\$ 41.95	\$ 8.28	\$ 27.81	\$ 7.39	\$ 6.08
Annualized Capital Cost (\$million)	\$ -	\$ 0.50	\$ 3.37	\$ 0.75	\$ 2.06	\$ 0.60	\$ 0.50
Annual O&M Cost (\$million)	\$ 194.87	\$ 190.03	\$ 197.76	\$ 204.31	\$ 211.27	\$ 207.66	\$ 202.09
Total Annualized Costs (\$million)	\$ 194.87	\$ 190.53	\$ 201.12	\$ 205.06	\$ 213.33	\$ 208.26	\$ 202.60
Total Annual Ridership (million)	113.71	111.61	113.69	114.72	115.34	115.62	115.08



Table 5.7-9 – Cost Effectiveness Summary (Fully Enhanced Base Scenario)*San Fernando Valley North-South Transit Corridor Alternatives Analysis*

Corridor Alternatives	2025 TSM	2025 RB	Canoga Avenue RR ROW	Reseda Boulevard	Sepulveda Boulevard	Van Nuys Boulevard - Sylmar Terminus	Lankershim Boulevard – San Fernando Road
Total Capital Cost (\$million)	\$ -	\$ 4.51	\$ 68.35	\$ 16.18	\$ 33.29	\$ 20.84	\$ 23.69
Annualized Capital Cost (\$million)	\$ -	\$ 0.50	\$ 5.71	\$ 1.62	\$ 2.67	\$ 1.88	\$ 2.06
Annual O&M Cost (\$million)	\$ 194.87	\$ 190.03	\$ 197.76	\$ 204.31	\$ 211.27	\$ 207.66	\$ 202.09
Total Annualized Costs (\$million)	\$ 194.87	\$ 190.53	\$ 203.47	\$ 205.93	\$ 213.93	\$ 209.54	\$ 204.16
Total Annual Ridership (million)	114.39	111.77	114.37	115.65	116.43	116.78	116.10



APPENDIX D: Cost Effectiveness Tables

Table 5.7-10 – Capital Cost Estimates by Criteria (Minimal Base Scenario)

Total Capital and Annualized Cost Estimates

San Fernando Valley North-South Transit Corridor Alternatives Analysis

CRITERIA/GOALS	CORRIDOR ALTERNATIVES								
	Base 2025	2025 TSM	2025 RB	Canoga Avenue RR ROW	Reseda Boulevard	Sepulveda Boulevard	Van Nuys Boulevard - Sylmar Terminus	Lankershim Boulevard – San Fernando Road	
Route Length (Miles)	n/a	n/a	n/a	5.4	14.5	21.1	21.4	12.5	
Annual Vehicle Hours	2,592,339	2,783,801	2,714,708	2,825,103	2,918,666	3,018,103	2,966,599	2,887,057	
Weekday Boardings	435,228	445,923	437,695	445,855	449,882	452,311	453,422	451,296	
Annual Boardings	110,983,140	113,710,416	111,612,276	113,693,076	114,720,012	115,339,356	115,622,712	115,080,480	
Weekday Boardings per Mile*	n/a	n/a	n/a	653	751	890	939	1,625	
Weekday Boardings per Vehicle Hour	43	41	41	40	39	38	39	40	
Daily Farebox Revenue	\$ 301,177.78	\$ 308,578.85	\$ 302,885.08	\$ 308,531.80	\$ 311,318.62	\$ 312,999.35	\$ 313,768.30	\$ 312,296.83	
Farebox Recovery Ratio	42.32%	40.38%	40.64%	39.78%	38.86%	37.78%	38.53%	39.41%	
Capital Cost	n/a	n/a	\$ 4,510,000.00	\$ 41,950,000.00	\$ 8,280,000.00	\$ 27,810,000.00	\$ 7,390,000.00	\$ 6,080,000.00	
Annualized Capital Cost	n/a	n/a	\$ 496,100.00	\$ 3,366,100.00	\$ 751,600.00	\$ 2,063,500.00	\$ 596,500.00	\$ 503,200.00	
Annual O&M Cost	\$181,463,749.95	\$194,866,089.95	\$190,029,579.95	\$197,757,229.95	\$204,306,639.95	\$211,267,229.95	\$207,661,949.95	\$202,094,009.95	
Total Annualized Cost	\$181,463,749.95	\$194,866,089.95	\$190,525,679.95	\$201,123,329.95	\$205,058,239.95	\$213,330,729.95	\$208,258,449.95	\$202,597,209.95	
Operating Cost per Mile	n/a	n/a	n/a	\$ 36,621,709.25	\$ 14,090,113.10	\$ 10,012,664.93	\$ 9,703,829.44	\$ 16,167,520.80	
Operating Cost per Passgr	\$ 1.64	\$ 1.71	\$ 1.70	\$ 1.74	\$ 1.78	\$ 1.83	\$ 1.80	\$ 1.76	
Capital Cost per Mile	n/a	n/a	n/a	\$ 7,768,518.52	\$ 571,034.48	\$ 1,318,009.48	\$ 345,327.10	\$ 486,400.00	
Capital Cost per Passgr	n/a	n/a	\$ 0.00	\$ 0.03	\$ 0.01	\$ 0.02	\$ 0.01	\$ 0.00	

* Based on ridership for the N/S corridors only.



**San Fernando Valley
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Table 5.7-11 – Capital Cost Estimates by Criteria (Fully Enhanced Base Scenario)

Total Capital and Annualized Cost Estimates

San Fernando Valley North-South Transit Corridor Alternatives Analysis

CRITERIA/GOALS	CORRIDOR ALTERNATIVES							
	Base 2025	2025 TSM	2025 RB	Canoga Avenue RR ROW	Reseda Boulevard	Sepulveda Boulevard	Van Nuys Boulevard - Sylmar Terminus	Lankershim Boulevard – San Fernando Road
Route Length (Miles)	n/a	n/a	n/a	5.4	14.5	21.1	21.4	12.5
Annual Vehicle Hours	2,592,339	2,783,801	2,714,708	2,825,103	2,918,666	3,018,103	2,966,599	2,887,057
Weekday Boardings	435,228	448,597	438,312	448,512	453,546	456,582	457,971	455,313
Annual Boardings	110,983,140	114,392,235	111,769,560	114,370,560	115,654,230	116,428,410	116,782,605	116,104,815
Weekday Boardings per Mile*	n/a	n/a	n/a	816	939	1,113	1,173	2,031
Weekday Boardings per Vehicle Hour	43	41	41	40	40	39	39	40
Daily Farebox Revenue	\$ 301,177.78	\$ 310,429.12	\$ 303,311.90	\$ 310,370.30	\$ 313,853.83	\$ 315,954.74	\$ 316,915.93	\$ 315,076.60
Farebox Recovery Ratio	42.32%	40.62%	40.70%	40.02%	39.17%	38.14%	38.92%	39.76%
Capital Cost	n/a	n/a	\$ 4,510,000.00	\$ 68,351,000.00	\$ 16,180,000.00	\$ 33,290,000.00	\$ 20,840,000.00	\$ 23,690,000.00
Annualized Capital Cost	n/a	n/a	\$ 496,100.00	\$ 5,711,410.00	\$ 1,620,600.00	\$ 2,666,300.00	\$ 1,876,000.00	\$ 2,062,800.00
Annual O&M Cost	\$181,463,749.95	\$194,866,089.95	\$190,029,579.95	\$197,757,229.95	\$204,306,639.95	\$211,267,229.95	\$207,661,949.95	\$202,094,009.95
Total Annualized Cost	\$181,463,749.95	\$194,866,089.95	\$190,525,679.95	\$203,468,639.95	\$205,927,239.95	\$213,933,529.95	\$209,537,949.95	\$204,156,809.95
Operating Cost per Mile	n/a	n/a	n/a	\$ 36,621,709.25	\$ 14,090,113.10	\$ 10,012,664.93	\$ 9,703,829.44	\$ 16,167,520.80
Operating Cost per Passgr	\$ 1.64	\$ 1.70	\$ 1.70	\$ 1.73	\$ 1.77	\$ 1.81	\$ 1.78	\$ 1.74
Capital Cost per Mile	n/a	n/a	n/a	\$ 12,657,592.59	\$ 1,115,862.07	\$ 1,577,725.12	\$ 973,831.78	\$ 1,895,200.00
Capital Cost per Passgr	n/a	n/a	\$ 0.00	\$ 0.05	\$ 0.01	\$ 0.02	\$ 0.02	\$ 0.02



APPENDIX D: Cost Effectiveness Tables

* Based on ridership for the N/S corridors only.



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